

Parking Greenspace	e Relocation

	arking Greenspace	Refocuti
	Description	Area
CODE	6' Divider medians between parking aisles	8,590 s.f.
PROP.	Varied width greenspace pushed to outside of parking area	14,214 s.f.

Site Data

Application Number Name of Project Proposed Use Future Land Use Designat Tier Zoning District Section, Township, Range Property Control Numbers	s 56–4 56–4	TBE Tropical Shipping Office and Warehouse INE Urban/Suburbar IC 32/42/43 43-42-32-35-000-0020 43-42-32-38-000-0040 43-42-32-38-000-0030
Traffic Analysis Zone Total Site Area Total Gross Floor Area Proposed Office Existing Office Existing Warehouse	(582,327 s.f.) 30,000 s.f. 14,524 s.f. 101,694 s.f.	13.3684 acres 146,218 s.t
Total Floor Area Ratio Total Building Coverage (Including canopies o		25% 34%
Impervious Area Buildings Pavement/Walks	195,643 s.f. 290,115 s.f.	83%
Pervious Area	96,569 s.f.	17%
Building Height Number of Stories		max. 50
Parking Required Ex. Office— 1 Space/ Prop. Office— 1 Spac Ex. Warehouse—1 Spac	e/300 s.f. @ 30,0	00 s.f. = 100
Proposed Parking General Parking= 33 Motorcycle Parking=		344 SPACES
Handicap Spaces Required Handicap Spaces Propose Loading Required (15' x 5 Loading Provided	d d	8 8 3 Loading Yard 3+

Development Regulations


	_				_								
		IG PROPERTY DEVELOPMENT REQUIREMENTS											
Г	\neg	ZONING	MINIMU	M LOT DIME	NSIONS	MAX.	MINIMUM	MAX. BLDG.	MAX. BLDG.		SETBACKS/S	EPARATIONS	
		DISTRICT	SIZE	WIDTH	DEPTH	FAR	PERV. AREA	COVER	HEIGHT	FRONT	SIDE INTERIOR	SIDE CORNER	REAR
1 8	CODE	IG	1.0 AC.			N/A	N/A	45%	50'	40'	15'	N/A	20'
0	PROP.	IG	13.37 AC.			N/A	N/A	34%	40'	632'	15'	N/A	63'


Notes


OBASE INFORMATION FOR THIS PROJECT WAS OBTAINED FROM A BOUNDARY SURVEY PREPARED BY CALVIN, GIORDANO & ASSOCIATES, INC. DATED 4/22/14

Development Team

	A
OWNER:	TROPICAL SHIPPING USA LLC 5 EAST 11TH STREET RIVIERA BEACH, FLORIDA 33404 (561) 881—3900
SURVEYOR:	CALVIN GIORDANO & ASSOCIATES 560 VILLAGE BLVD. SUITE 340 WEST PALM BEACH, FL 33409 (561) 684-6161
CIVIL ENGINEER:	REIKENIS & ASSOCIATES LLC 13081 SE GREEN TURTLE WAY TEQUESTA, FL 33469 (561) 818-5381
ARCHITECT:	LCA ARCHITECTURE, INC. 1975 SANSBURY'S WAY SUITE 108 WEST PALM BEACH, FLORIDA 33411 (561) 493–4787
TRAFFIC ENGINEER:	SIMMONS & WHITE 5601 CORPORATE WAY WEST PALM BEACH, FLORIDA 33407 (561) 478-7848
PLANNER/ LANDSCAPE ARCHITECT:	JON E. SCHMIDT AND ASSOCIATES, INC. 2247 PALM BEACH LAKES BOULEVARD SUITE 101 WEST PALM BEACH, FLORIDA 33409 (561) 684-6141

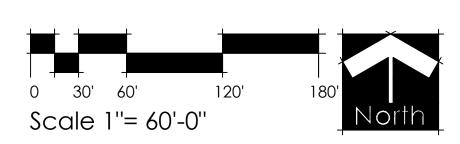

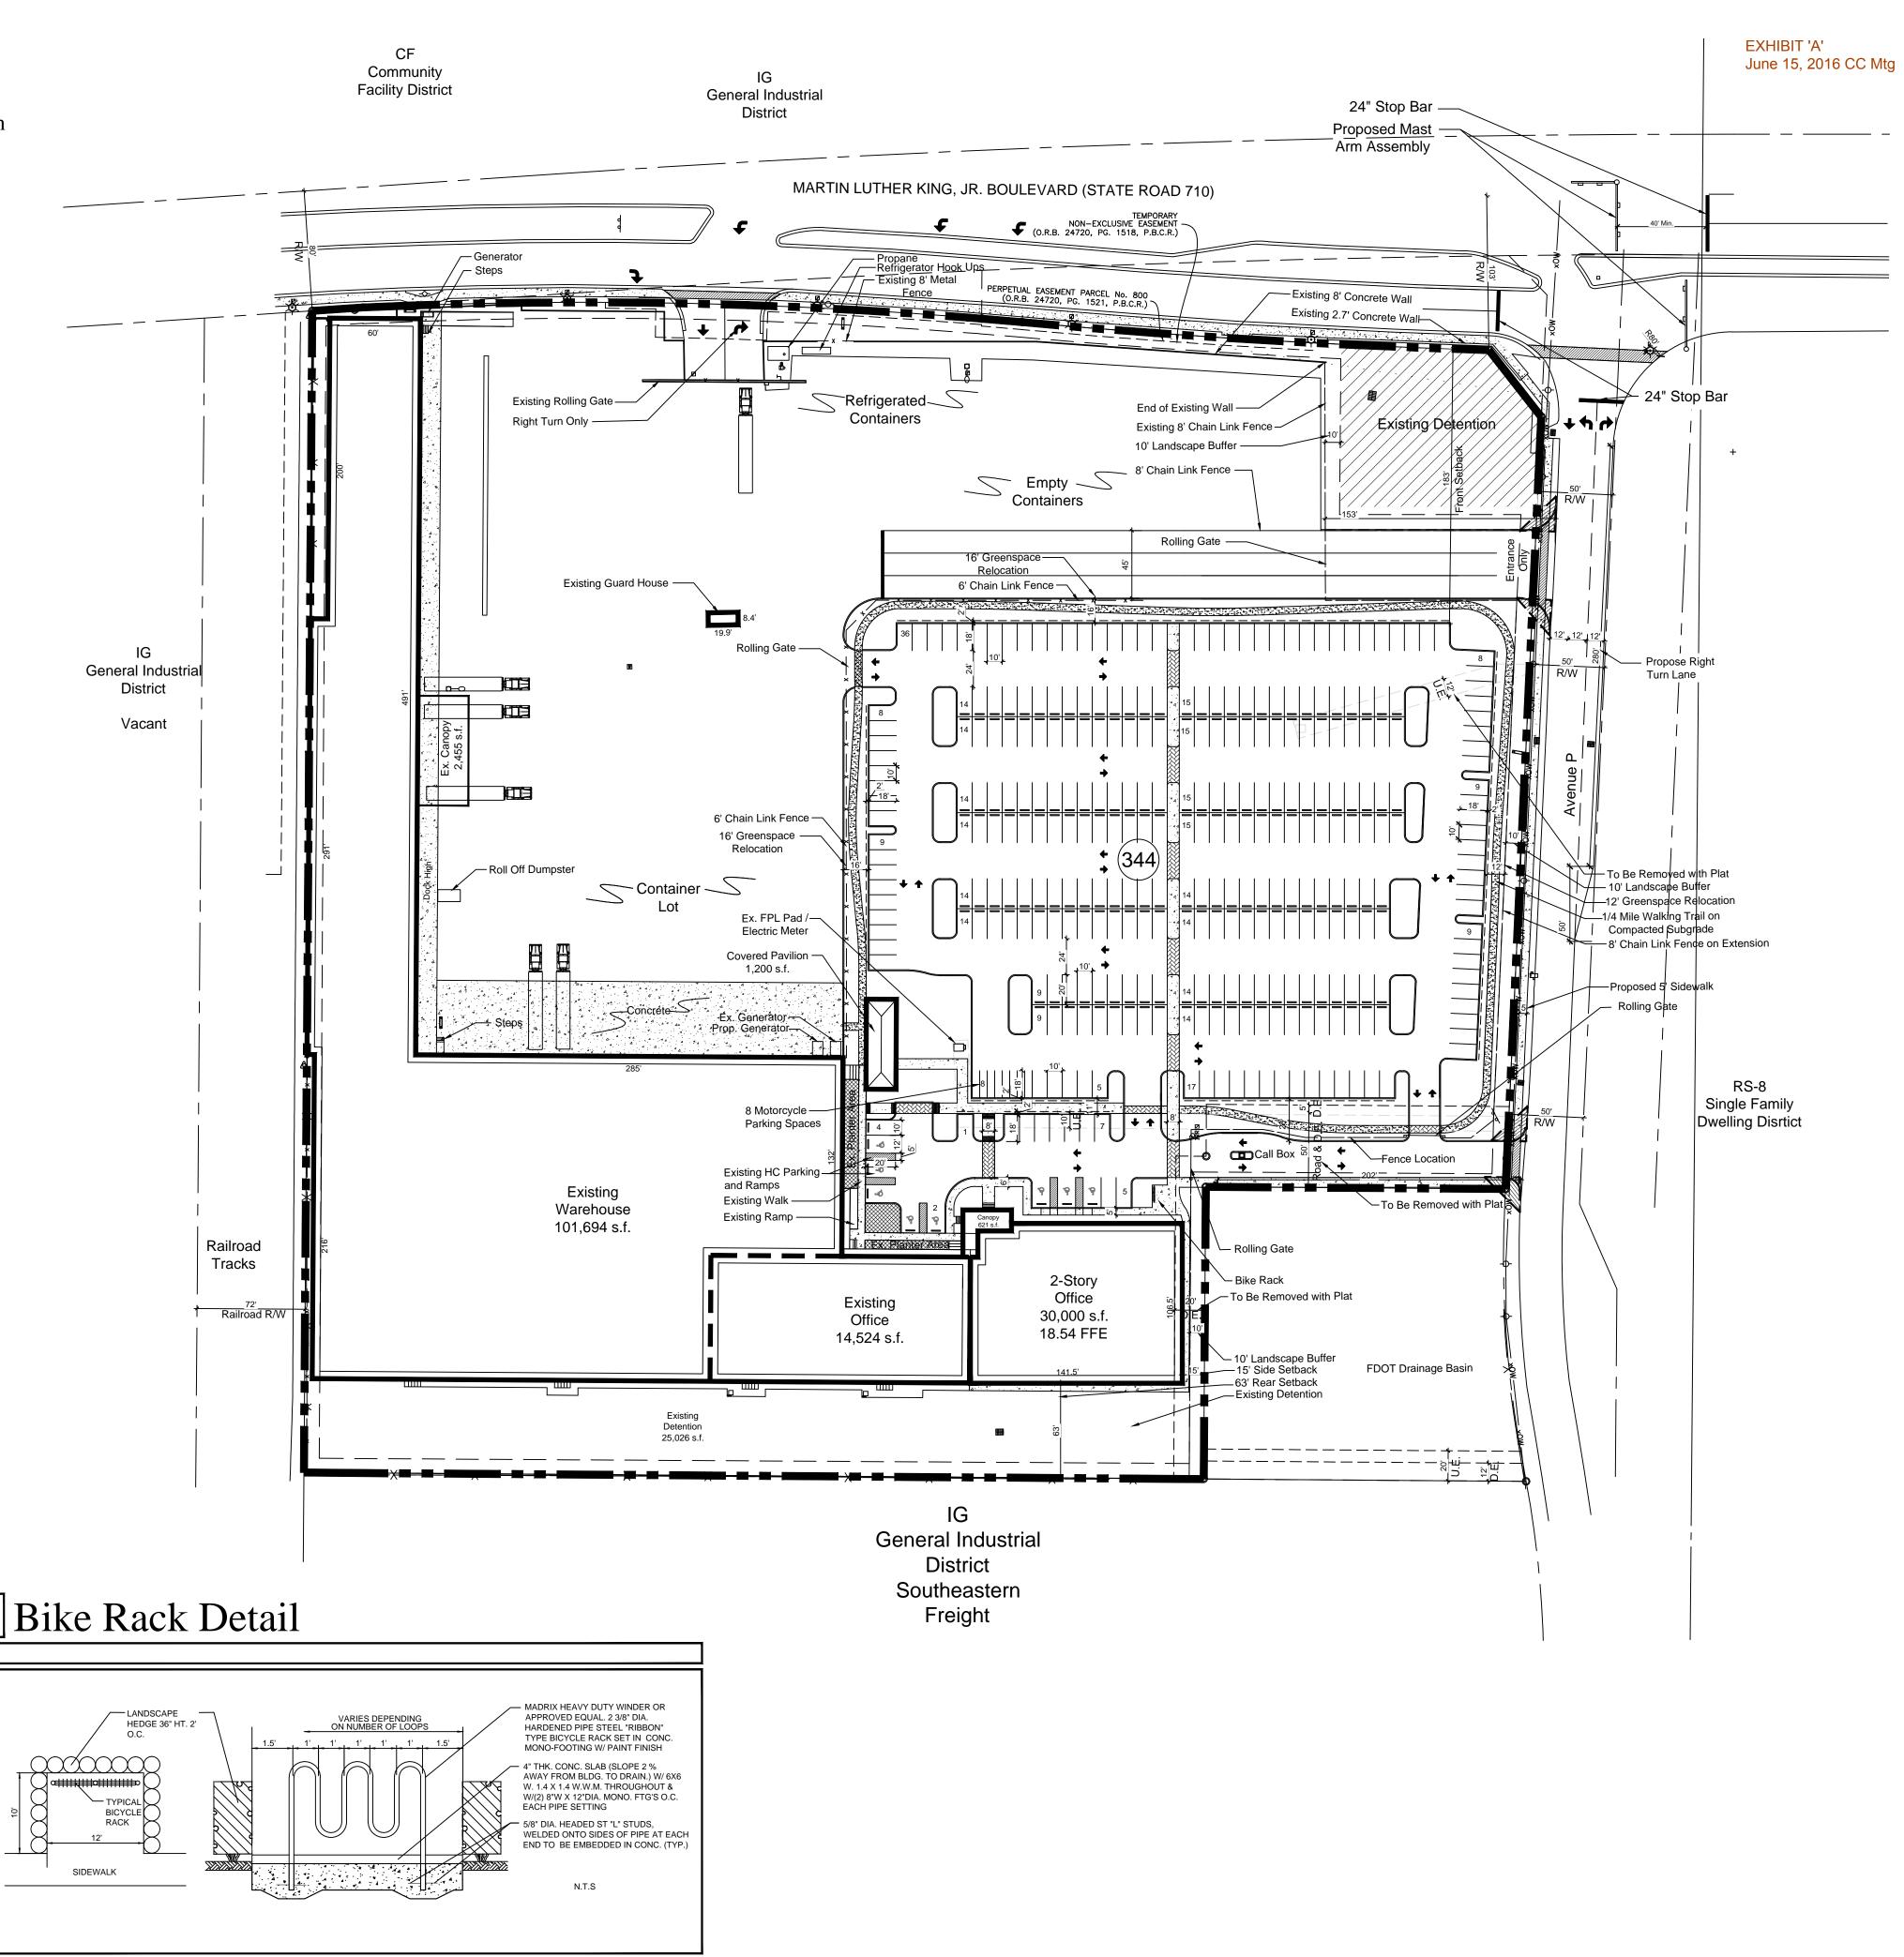

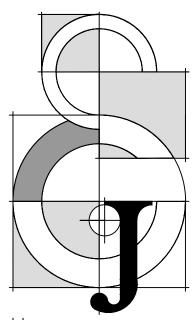

Jon E. Schmidt and Associates
Landscape Architecture & Site Planning
2247 Palm Beach Lakes Blvd.- Suite 101
West Palm Beach, Florida 33409
Tel. (561) 684-6141 • Fax. (561) 684-6142
E-mail: Jschmidt@jesla.com
Website: www.jesla.com
License No.: LC26000232

Tropical Shipping Riviera Facility

1.1	
Date:	05/21/14
Scale:	1" = 60'-0"
Design By:	JES
Drawn By:	BMC
Checked By:	Jes
File No.	688.01
Job No.	14-08
1-1	


REVISIONS / SUBMISSIONS


09/12/14 Footprint Expansion 09/30/14 Staff Comments 10/03/14 Fencing Revision 11/05/14 Trucks Removed 10/13/15 Ex. FPL Pad 10/13/15 Sidewalk Rev. 10/30/15 Entry Revisions. 03/18/16 SP Amendment


Phase 1 Site Plan

SP-1 of

EXHIBIT 'A'
June 15, 2016 CC Mtg

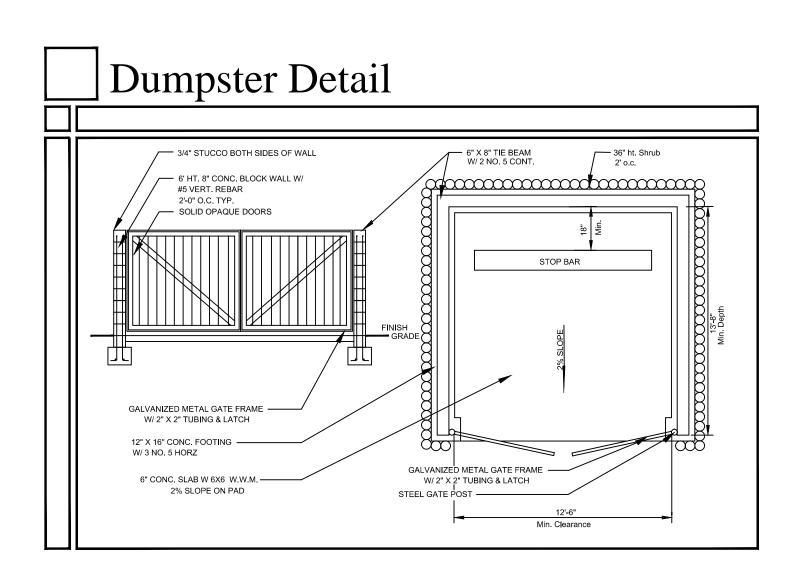

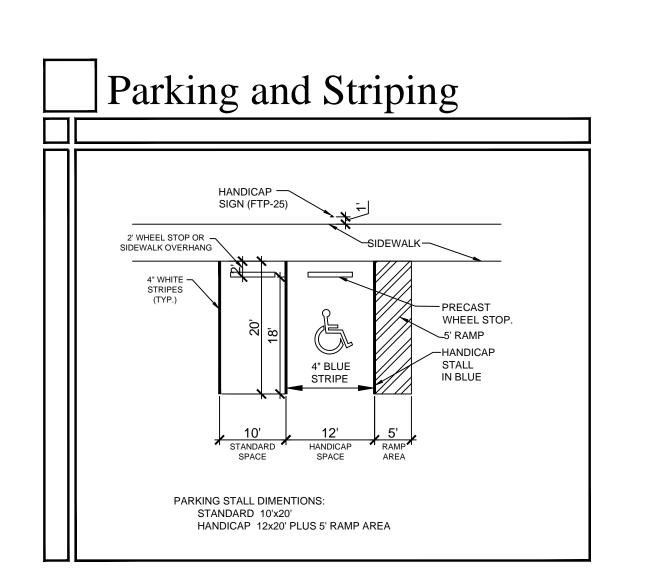

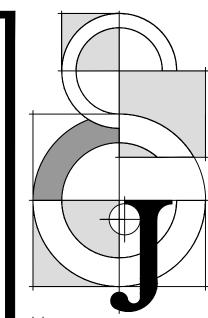

Jon E. Schmidt and Associates
Landscape Architecture & Site Planning
2247 Palm Beach Lakes Blvd.- Suite 101
West Palm Beach, Florida 33409
Tel. (561) 684-6141 • Fax. (561) 684-6142
E-mail: Jschmidt@jesla.com
Website: www.jesla.com
License No.: LC26000232

Tropical Shipping Riviera Facility

Tate:	05/21/14
Scale:	NTS
Design By:	JES
Drawn By:	BMC
Checked By:	Jes
File No.	688.01
Job No.	14-08

REVISIONS / SUBMISSIONS

09/30/14 Staff Comments

03/18/16 SP Amendment

05/10/16 Submittal


Phase 1 Regulating Plan

SP-2 of 2




Phase 1 Tropical Shipping

- LI-1 Phase 1 Landscape Index
- LP-1 Phase 1 Foundation Landscape Plan
- LP-2 Phase 1 Parking Lot Landscape Plan
- LP-3 Phase 1 North End Landscape Plan
- LP-4 Upgraded Area Landscape Plan
- LP-5 Landscape Specifications
- LP-6 Tree Disposition Plan

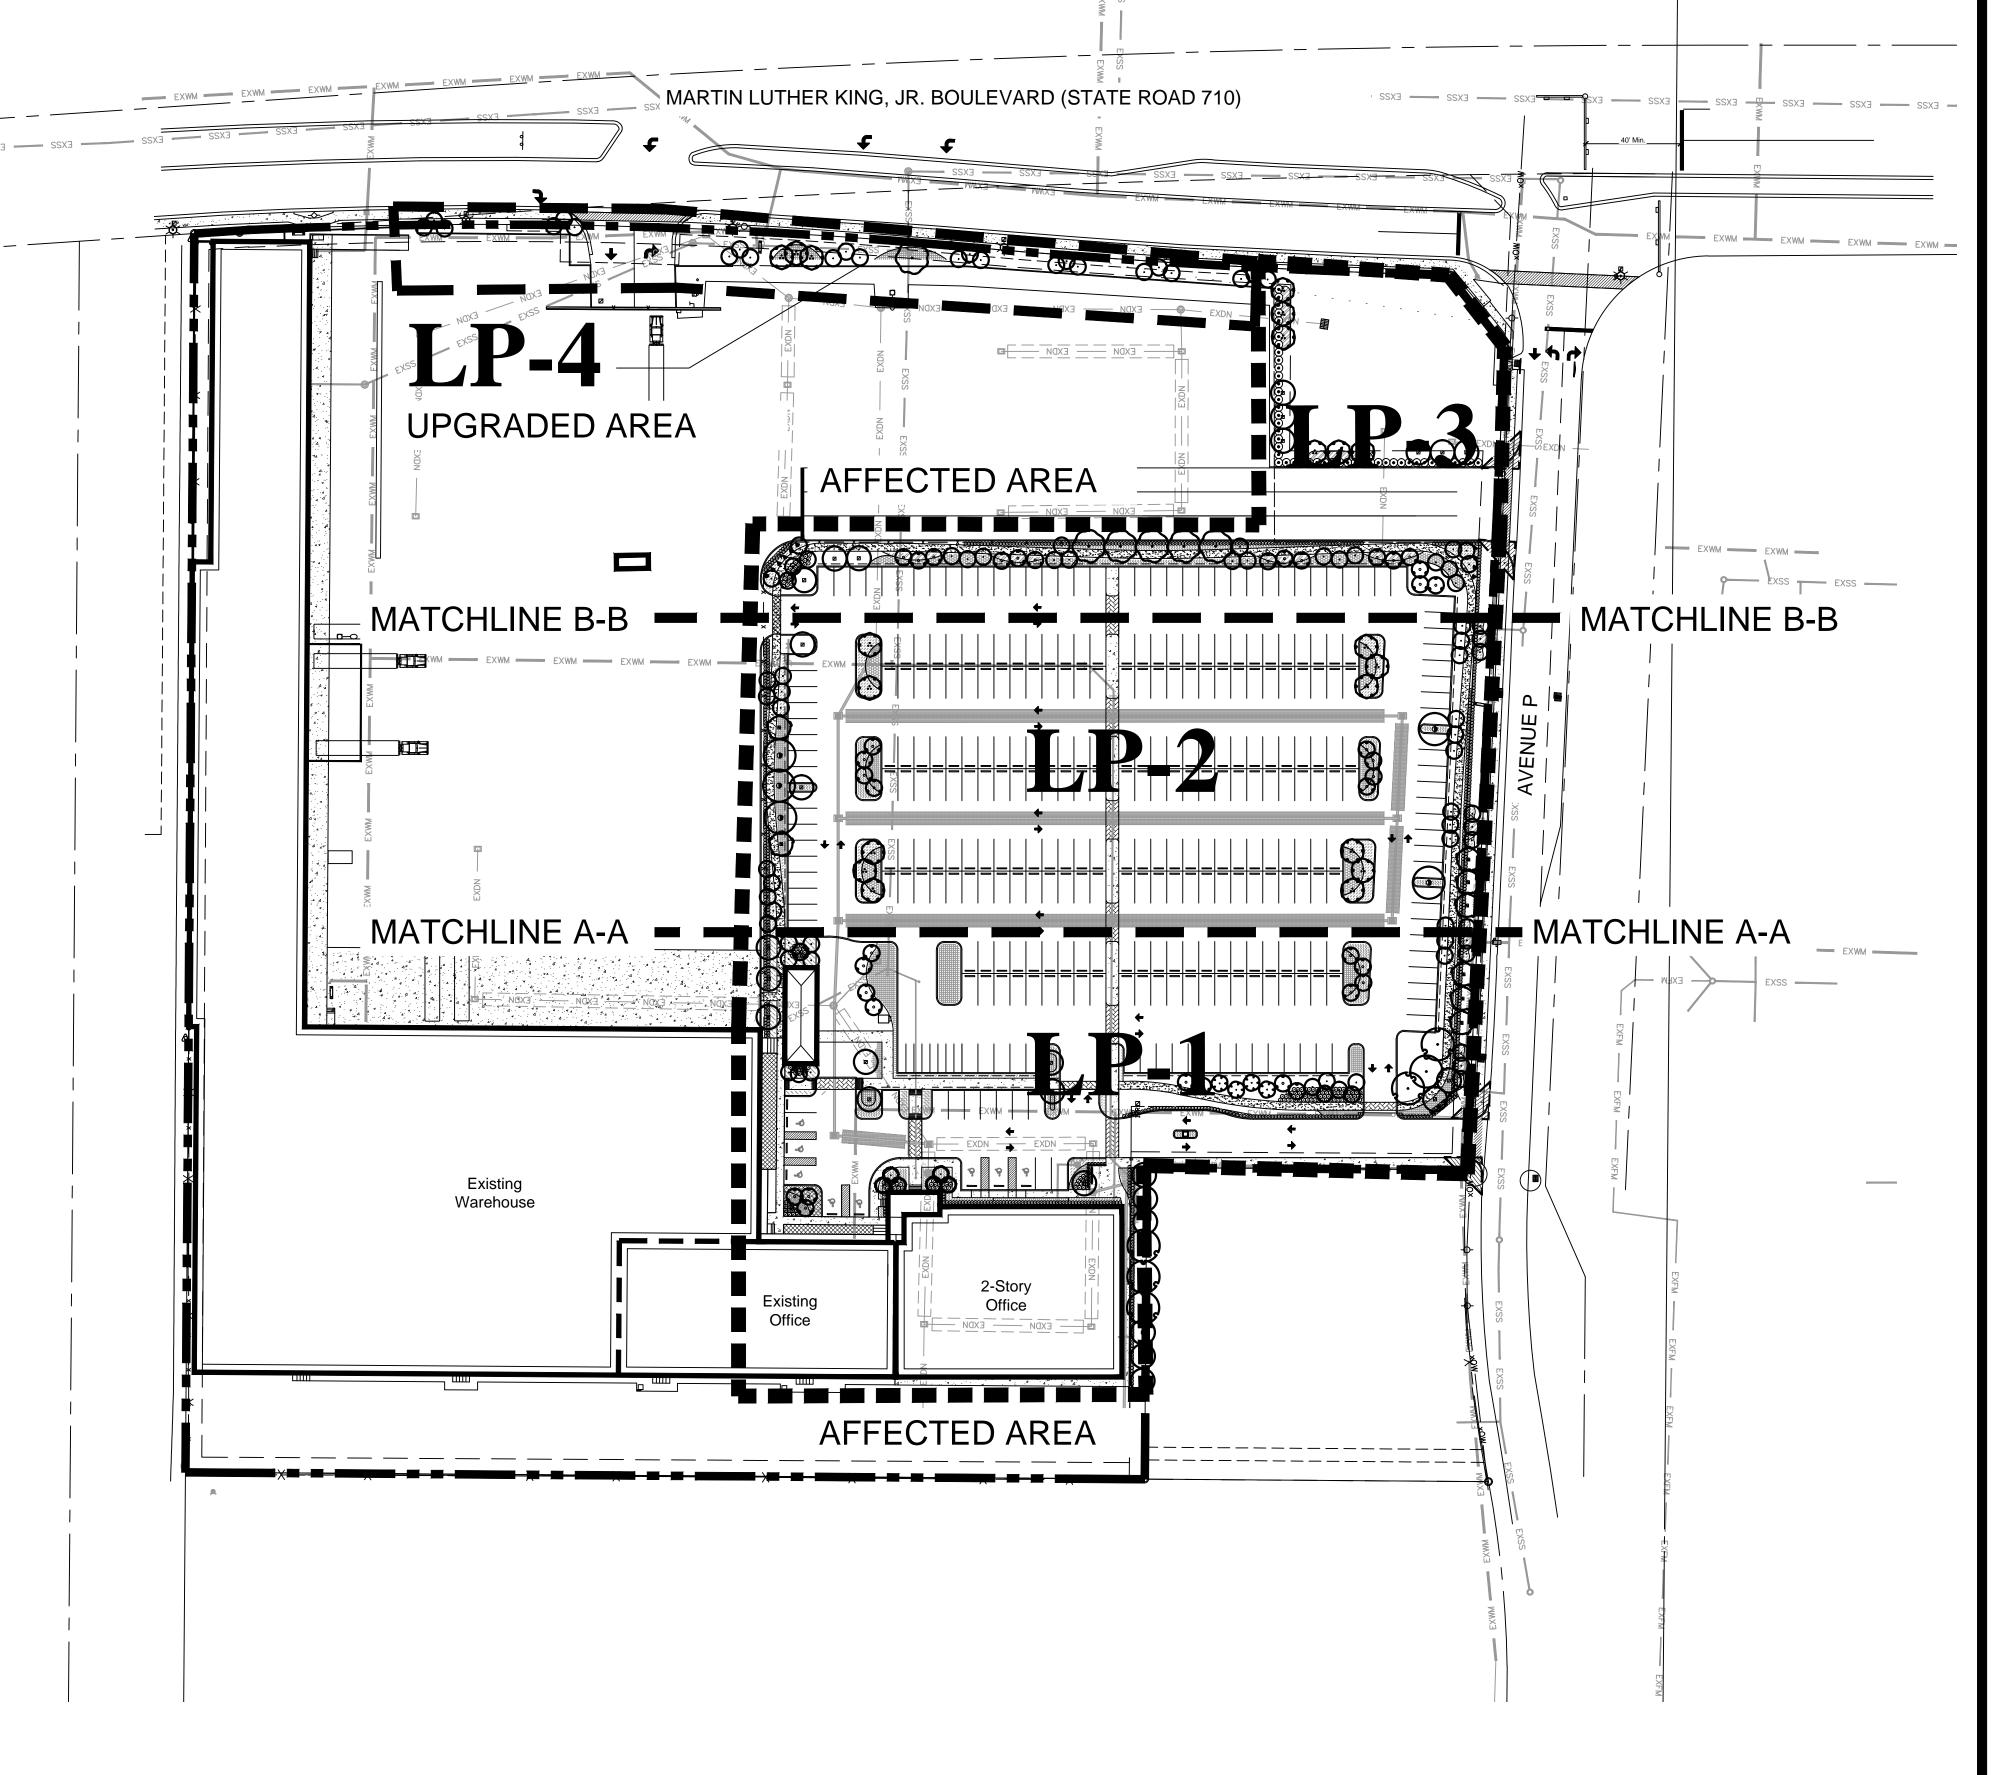



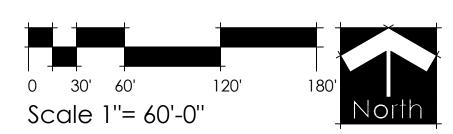

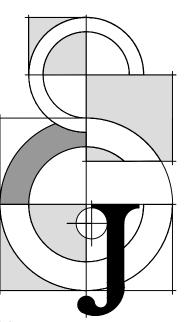


EXHIBIT 'A'

June 15, 2016 CC Mtg

Jon E. Schmidt and Associated Landscape Architecture & Site Plannin 2247 Palm Beach Lakes Blvd.- Suite 101 West Palm Beach, Florida 33409 Tel. (561) 684-6141 • Fax. (561) 684-614 E-mail: Jschmidt@jesla.com Website: www.jesla.com License No.: LC26000232

Tropical Shipping Riviera Facility

 Date:
 5/21/14

 Scale:
 1" = 60'-0"

 Design By:
 JES

 Drawn By:
 BMC

 Checked By:
 Jes

 File No.
 688.01

 Job No.
 14-08

REVISIONS / SUBMISSIONS 09/30/14 Staff Comments

10/03/14 Fencing Revision

01/13/15 MYC Spec 10/14/15 FPL Pad/Easment Rev.

03/17/16 Revise per Civil

05/10/16 Submittal

NOT VALID WITHOUT THE SIGNATURE AN ORIGINAL RAISED SEAL OF A FLORIDA LICENSED LANDSCAPE ARCHITECT.


Printed name


FLORIDA REGISTRATION NO. LA 0001638

Phase 1 Landscape Index

LI-1

of 1

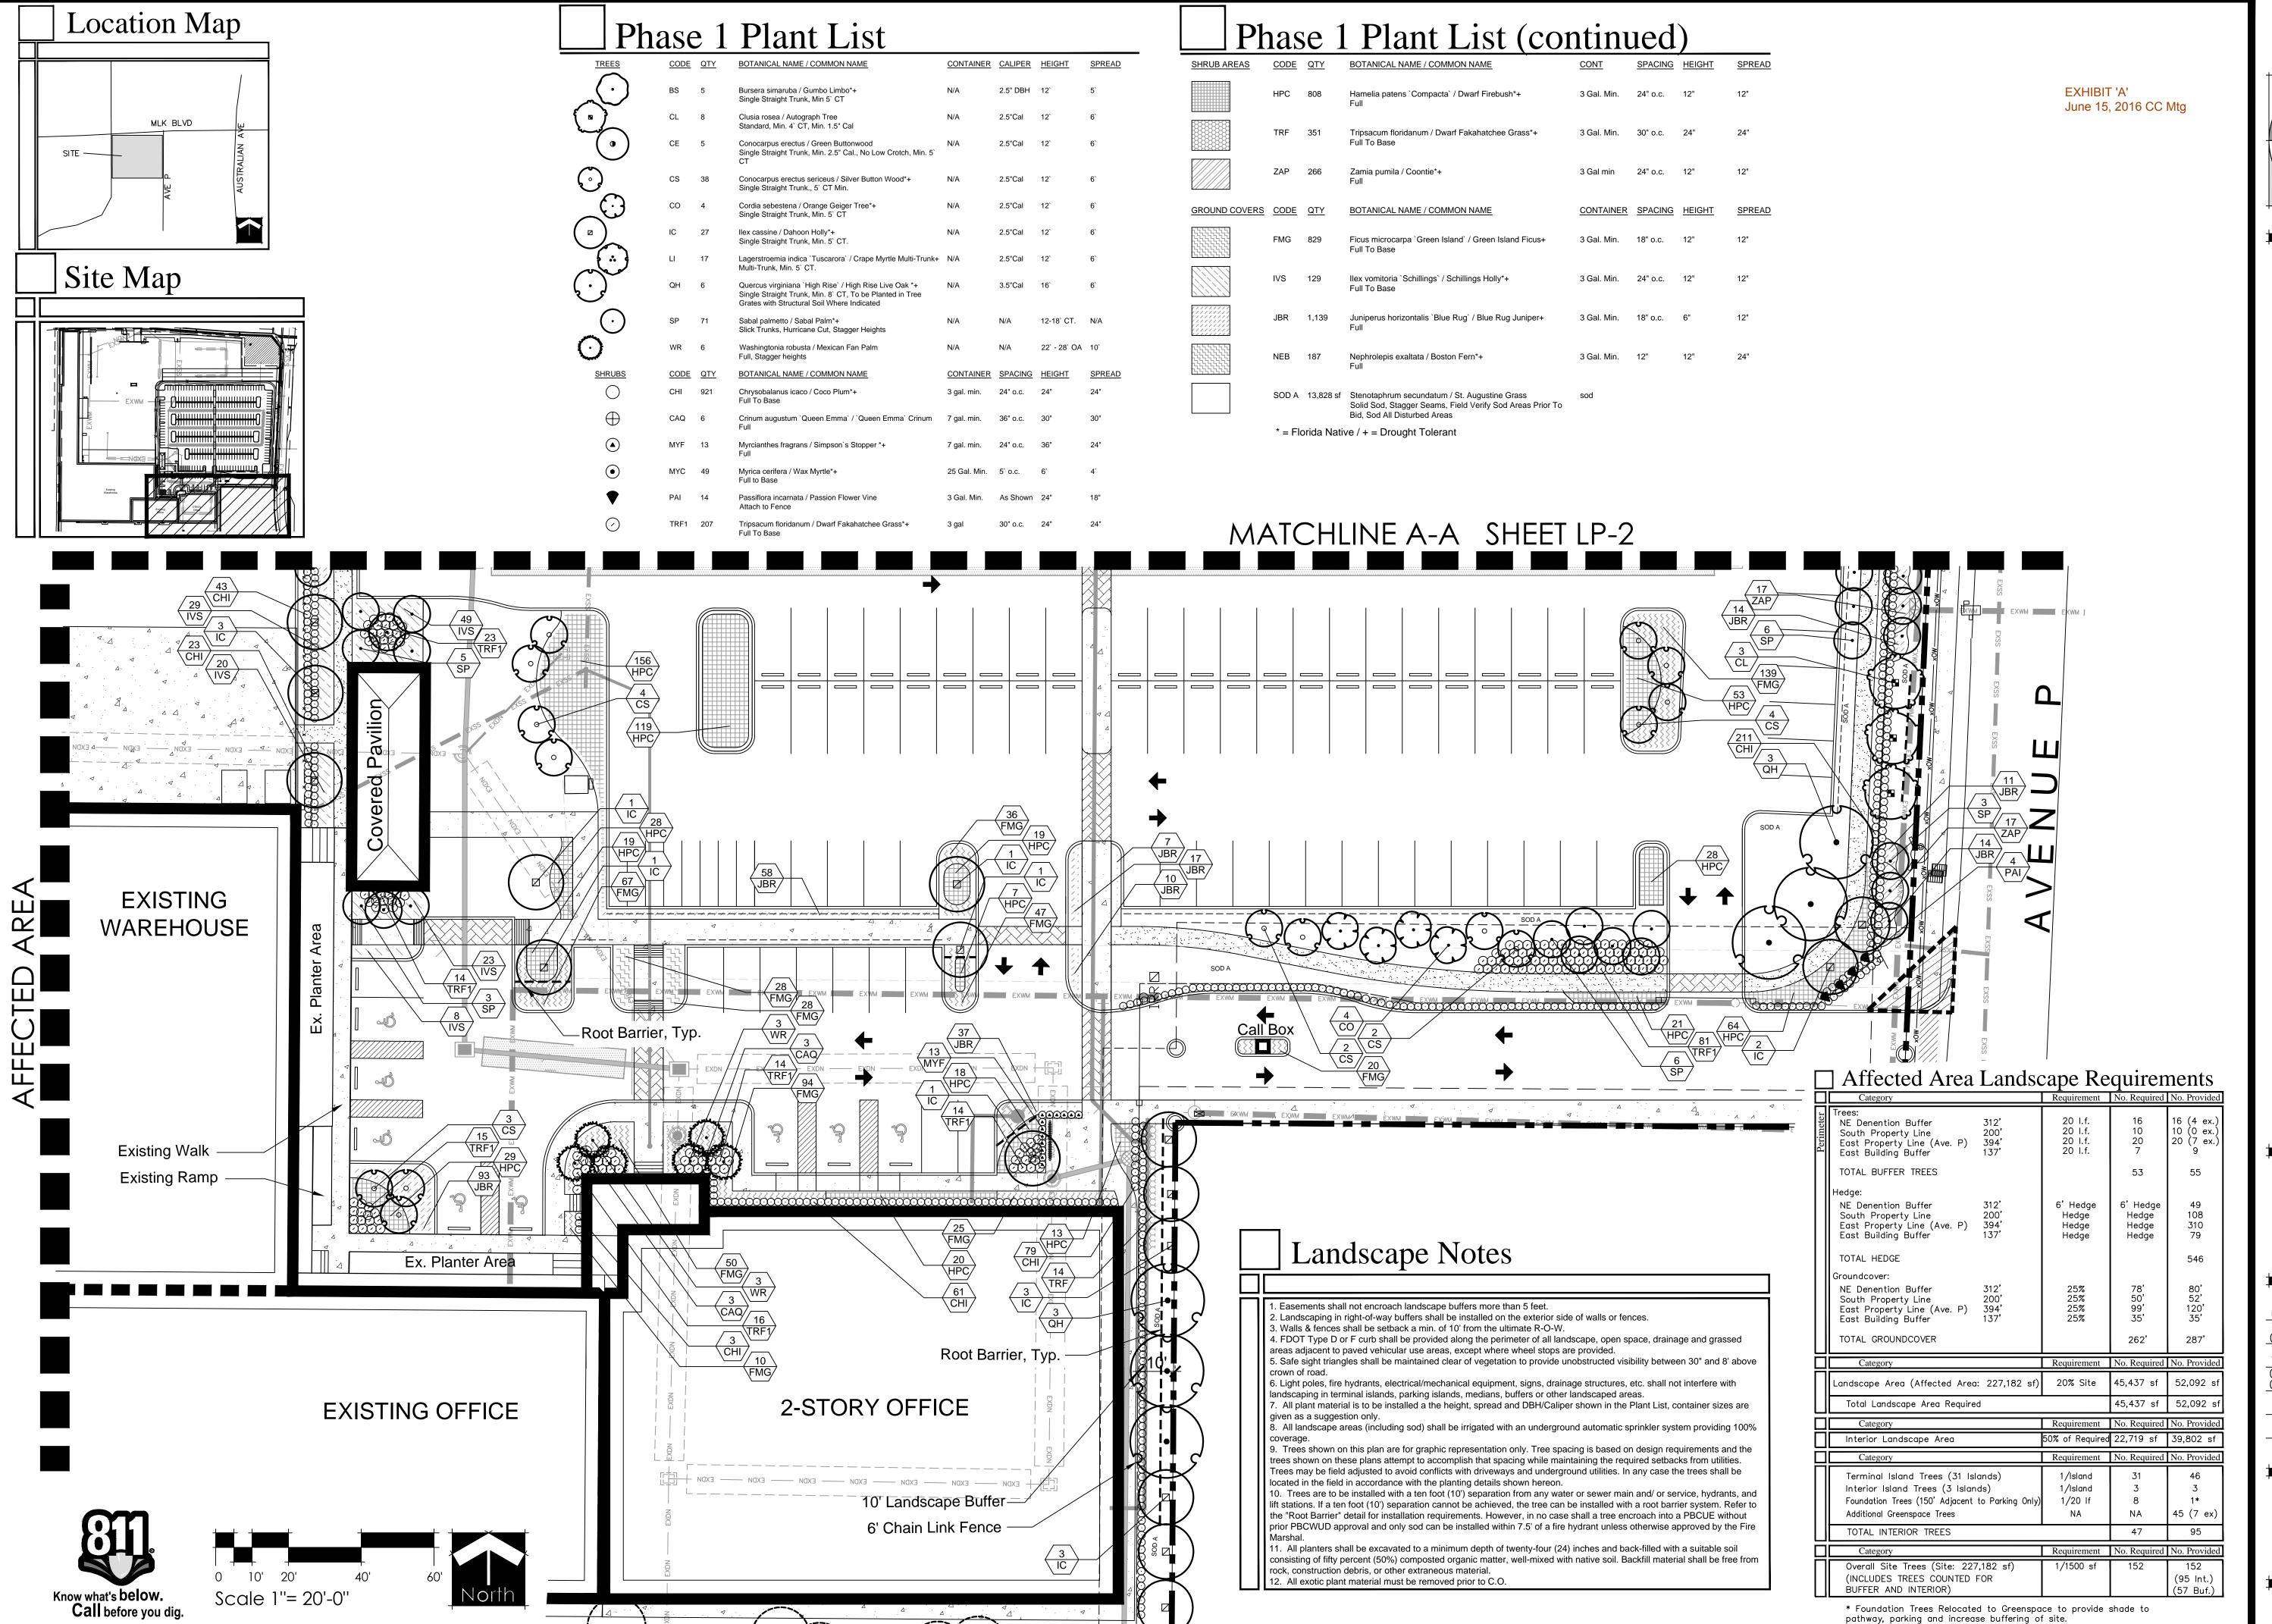

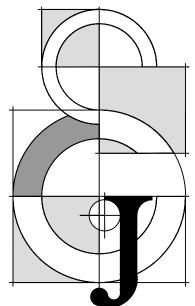


4.1	
Date:	5/21/14
Scale:	1" = 20'-0"
Design By:	JES
Drawn By:	ВМС
Checked By:	Jes
File No.	688.01
Job No.	14-08

revisions / submissions

/03/14 Fencing Revision /13/15 MYC Spec /14/15 FPL Pad/Easment Rev. /10/15 Entry Revisions

Phase 1 Landscape Plan

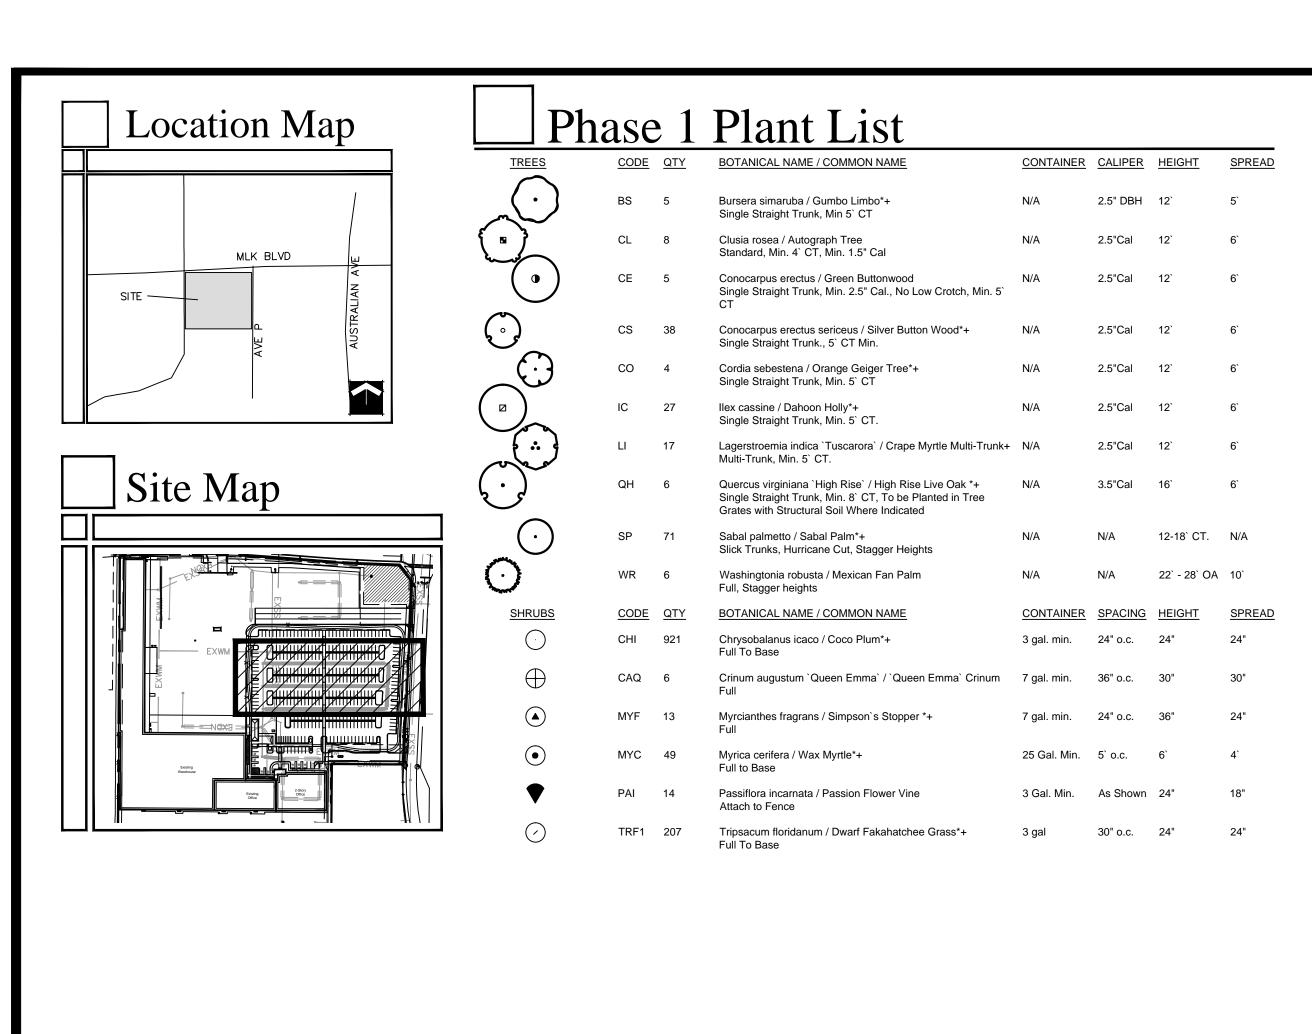

SHRUB AREAS	CODE	<u>QTY</u>	BOTANICAL NAME / COMMON NAME	CONT	SPACING	<u>HEIGHT</u>	SPREA
	HPC	808	Hamelia patens `Compacta` / Dwarf Firebush*+ Full	3 Gal. Min.	24" o.c.	12"	12"
	TRF	351	Tripsacum floridanum / Dwarf Fakahatchee Grass*+ Full To Base	3 Gal. Min.	30" o.c.	24"	24"
	ZAP	266	Zamia pumila / Coontie*+ Full	3 Gal min	24" o.c.	12"	12"
GROUND COVERS	CODE	QTY	BOTANICAL NAME / COMMON NAME	CONTAINER	SPACING	<u>HEIGHT</u>	<u>SPREA</u>
	FMG	829	Ficus microcarpa `Green Island` / Green Island Ficus+Full To Base	3 Gal. Min.	18" o.c.	12"	12"
	IVS	129	Ilex vomitoria `Schillings` / Schillings Holly*+ Full To Base	3 Gal. Min.	24" o.c.	12"	12"
· · · · · · · · · · · · · · · · · · ·	JBR	1,139	Juniperus horizontalis `Blue Rug` / Blue Rug Juniper+ Full	3 Gal. Min.	18" o.c.	6"	12"
	NEB	187	Nephrolepis exaltata / Boston Fern*+ Full	3 Gal. Min.	12"	12"	24"
	SOD A	13,828 sf	Stenotaphrum secundatum / St. Augustine Grass Solid Sod, Stagger Seams, Field Verify Sod Areas Prior To Bid, Sod All Disturbed Areas	sod			

_ Landscape Notes	5
-------------------	---

Easements shall not encroach landscape buffers more than 5 feet. . Landscaping in right-of-way buffers shall be installed on the exterior side of walls or fences.

3. Walls & fences shall be setback a min. of 10' from the ultimate R-O-W. 4. FDOT Type D or F curb shall be provided along the perimeter of all landscape, open space, drainage and grassed areas adjacent to paved vehicular use areas, except where wheel stops are provided.

5. Safe sight triangles shall be maintained clear of vegetation to provide unobstructed visibility between 30" and 8' above 6. Light poles, fire hydrants, electrical/mechanical equipment, signs, drainage structures, etc. shall not interfere with


landscaping in terminal islands, parking islands, medians, buffers or other landscaped areas. 7. All plant material is to be installed a the height, spread and DBH/Caliper shown in the Plant List, container sizes are

given as a suggestion only. All landscape areas (including sod) shall be irrigated with an underground automatic sprinkler system providing 100%

9. Trees shown on this plan are for graphic representation only. Tree spacing is based on design requirements and the trees shown on these plans attempt to accomplish that spacing while maintaining the required setbacks from utilities. Trees may be field adjusted to avoid conflicts with driveways and underground utilities. In any case the trees shall be located in the field in accordance with the planting details shown hereon.

10. Trees are to be installed with a ten foot (10') separation from any water or sewer main and/ or service, hydrants, and lift stations. If a ten foot (10') separation cannot be achieved, the tree can be installed with a root barrier system. Refer to the "Root Barrier" detail for installation requirements. However, in no case shall a tree encroach into a PBCUE without prior PBCWUD approval and only sod can be installed within 7.5' of a fire hydrant unless otherwise approved by the Fire


11. All planters shall be excavated to a minimum depth of twenty-four (24) inches and back-filled with a suitable soil consisting of fifty percent (50%) composted organic matter, well-mixed with native soil. Backfill material shall be free from rock, construction debris, or other extraneous material.

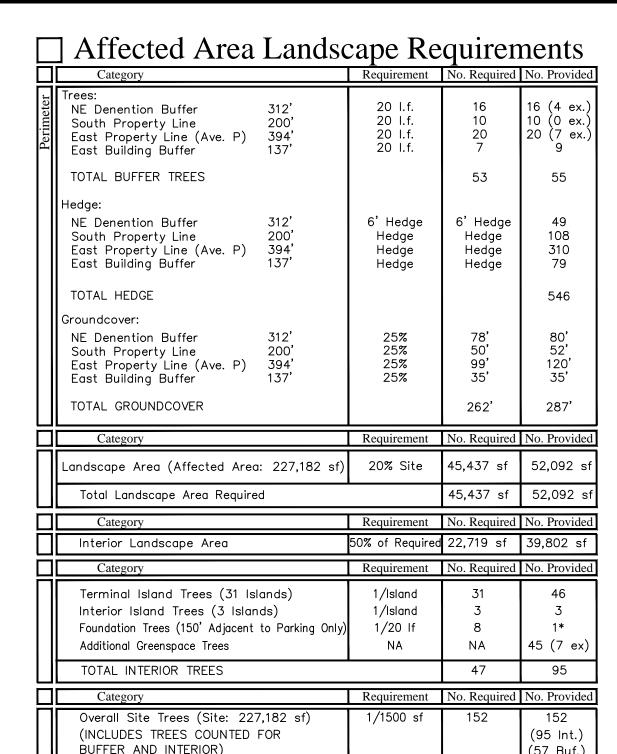

* Foundation Trees Relocated to Greenspace to provide shade to pathway, parking and increase buffering of site.

EXHIBIT 'A' June 15, 2016 CC Mtg



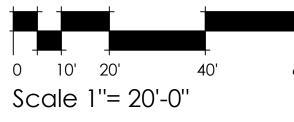



- ر		
_	North	

1 1	
Date:	5/21/14
Scale:	1" = 20'-0"
Design By:	JES
Drawn By:	ВМС
Checked By:	Jes
File No.	688.01
Job No.	14-08
1 1	

Jon E. Schmidt and Associates

Landscape Architecture & Site Planning

2247 Palm Beach Lakes Blvd.- Suite 101

Tel. (561) 684-6141 • Fax. (561) 684-6142

Riviera

West Palm Beach, Florida 33409

E-mail: Jschmidt@jesla.com


Website: www.jesla.com

License No.: LC26000232


${}^{\mathsf{T}}$ revisions / submissions

09/30/14 Staff Comments
10/03/14 Fencing Revision
01/13/15 MYC Spec
10/14/15 FPL Pad/Easment Rev.
11/10/15 Entry Revisions
03/17/16 Revise per Civil
05/10/16 Submittal

Phase 1 Landscape Plan

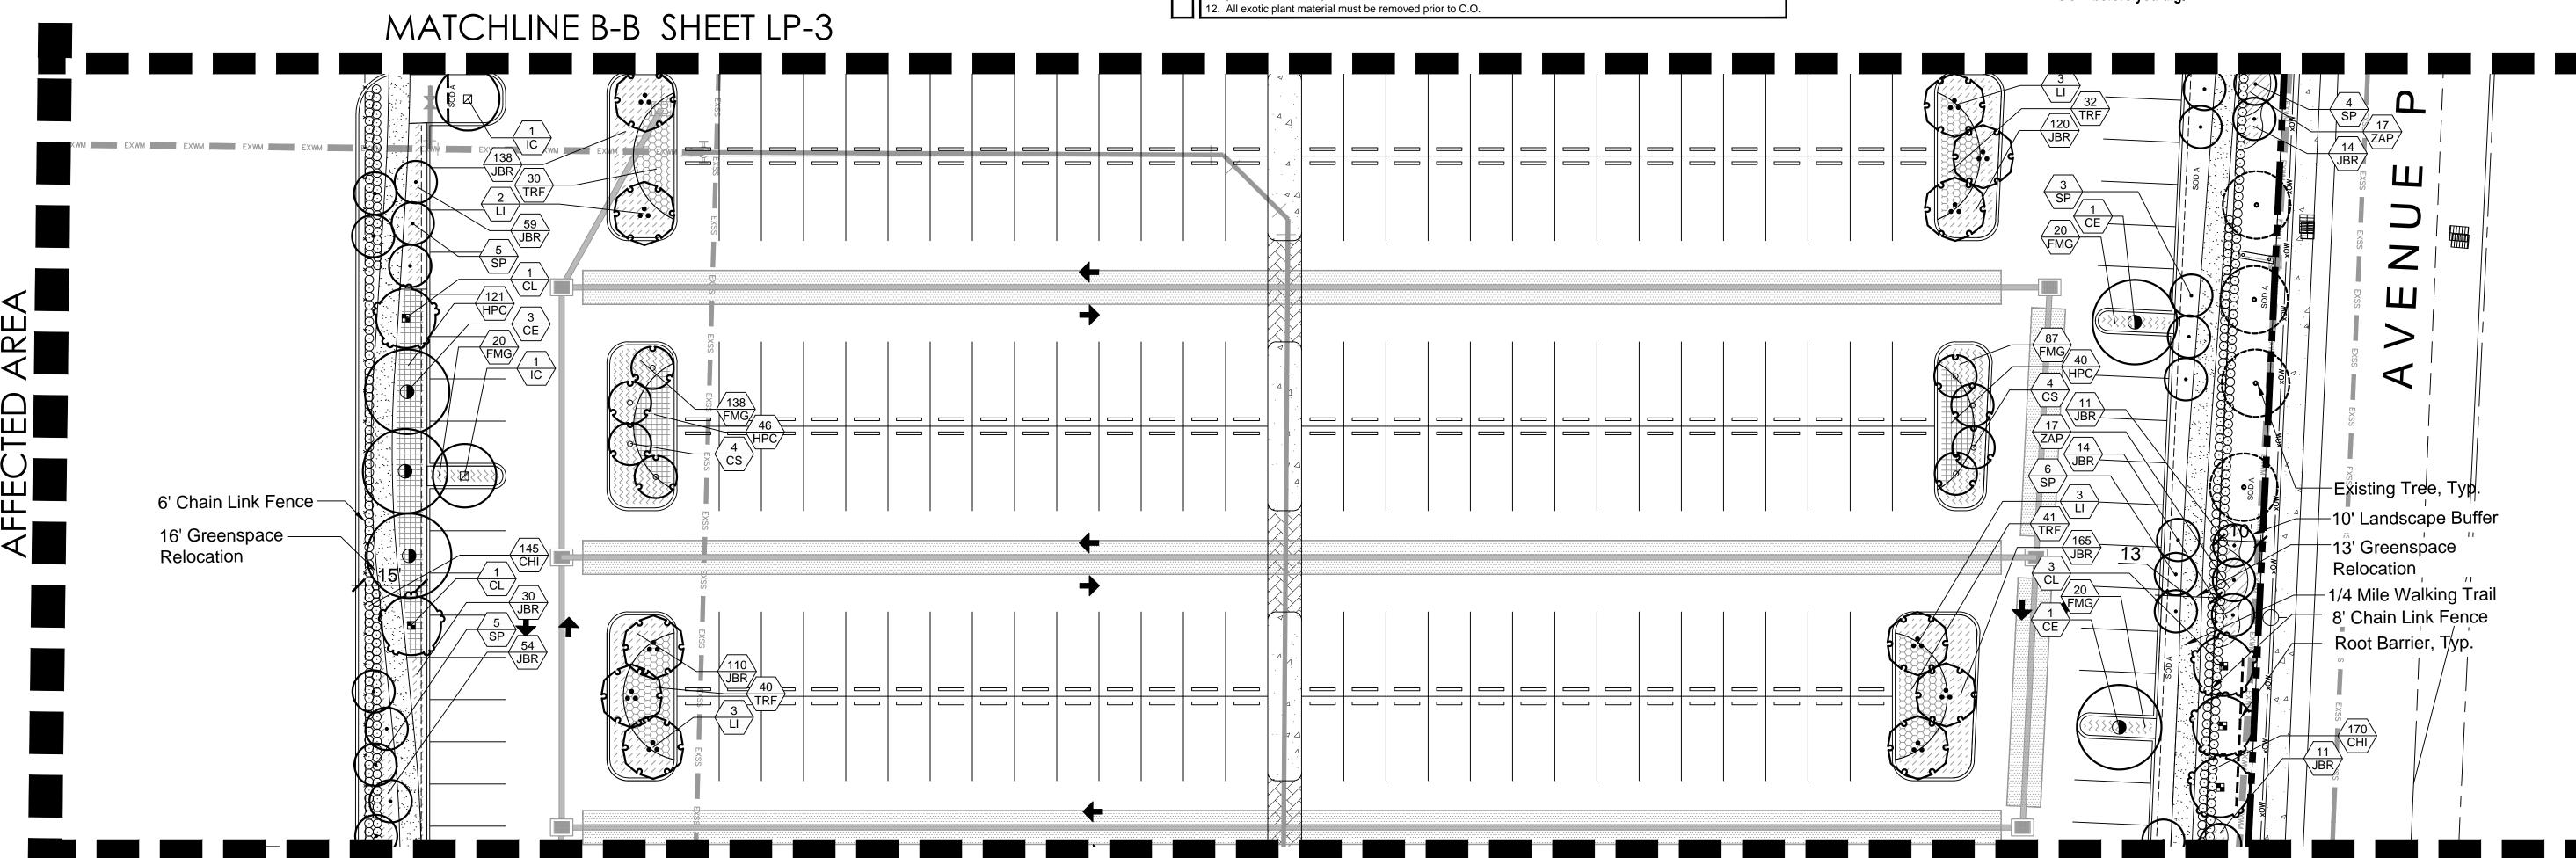

MATCHLINE A-A SHEET LP-1

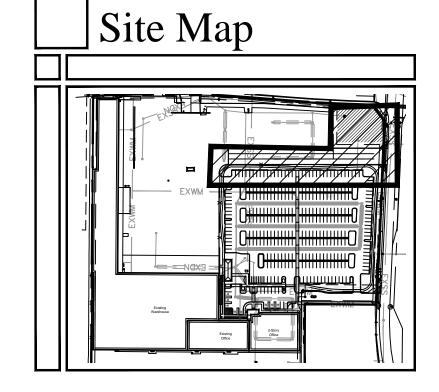

☐ Affected Area	Landso	cape Re	quiren	nents
Category		Requirement	No. Required	No. Provid
Trees: NE Denention Buffer South Property Line East Property Line (Ave. P) East Building Buffer	312' 200' 394' 137'	20 l.f. 20 l.f. 20 l.f. 20 l.f.	16 10 20 7	16 (4 ex 10 (0 ex 20 (7 ex 9
TOTAL BUFFER TREES			53	55
Hedge:				
NE Denention Buffer South Property Line East Property Line (Ave. P) East Building Buffer	312' 200' 394' 137'	6' Hedge Hedge Hedge Hedge	6' Hedge Hedge Hedge Hedge	49 108 310 79
TOTAL HEDGE				546
Groundcover:				
NE Denention Buffer South Property Line East Property Line (Ave. P) East Building Buffer	312' 200' 394' 137'	25% 25% 25% 25%	78' 50' 99' 35'	80' 52' 120' 35'

TOTAL GROUNDCOVER

Category	Requirement	No. Required	No. Provided
andscape Area (Affected Area: 227,182 sf)	20% Site	45,437 sf	52,092 sf
Total Landscape Area Required		45,437 sf	52,092 sf
Category	Requirement	No. Required	No. Provided
Interior Landscape Area	50% of Required	22,719 sf	39,802 sf
Category	Requirement	No. Required	No. Provided
Terminal Island Trees (31 Islands) Interior Island Trees (3 Islands) Foundation Trees (150' Adjacent to Parking Only) Additional Greenspace Trees	1/Island 1/Island 1/20 If NA	31 3 8 NA	46 3 1* 45 (7 ex)
TOTAL INTERIOR TREES		47	95
Category	Requirement	No. Required	No. Provided
Overall Site Trees (Site: 227,182 sf) (INCLUDES TREES COUNTED FOR BUFFER AND INTERIOR)	1/1500 sf	152	152 (95 Int.) (57 Buf.)

BUFFER AND INTERIOR)	
* Foundation Trees Relocated to Greenspace to provide pathway, parking and increase buffering of site.	shade

	June 15, 2016 CC Mtg
otes	

EXHIBIT 'A'

Landscape No

Easements shall not encroach landscape buffers more than 5 feet. 2. Landscaping in right-of-way buffers shall be installed on the exterior side of walls or fences. 3. Walls & fences shall be setback a min. of 10' from the ultimate R-O-W.

4. FDOT Type D or F curb shall be provided along the perimeter of all landscape, open space, drainage and grassed areas adjacent to paved vehicular use areas, except where wheel stops are provided. 5. Safe sight triangles shall be maintained clear of vegetation to provide unobstructed visibility between 30" and 8' above

crown of road. 6. Light poles, fire hydrants, electrical/mechanical equipment, signs, drainage structures, etc. shall not interfere with landscaping in terminal islands, parking islands, medians, buffers or other landscaped areas.

7. All plant material is to be installed a the height, spread and DBH/Caliper shown in the Plant List, container sizes are given as a suggestion only. 8. All landscape areas (including sod) shall be irrigated with an underground automatic sprinkler system providing 100%

9. Trees shown on this plan are for graphic representation only. Tree spacing is based on design requirements and the trees shown on these plans attempt to accomplish that spacing while maintaining the required setbacks from utilities. Trees may be field adjusted to avoid conflicts with driveways and underground utilities. In any case the trees shall be

located in the field in accordance with the planting details shown hereon.

10. Trees are to be installed with a ten foot (10') separation from any water or sewer main and/ or service, hydrants, and lift stations. If a ten foot (10') separation cannot be achieved, the tree can be installed with a root barrier system. Refer to the "Root Barrier" detail for installation requirements. However, in no case shall a tree encroach into a PBCUE without


prior PBCWUD approval and only sod can be installed within 7.5' of a fire hydrant unless otherwise approved by the Fire 11. All planters shall be excavated to a minimum depth of twenty-four (24) inches and back-filled with a suitable soil

consisting of fifty percent (50%) composted organic matter, well-mixed with native soil. Backfill material shall be free from rock, construction debris, or other extraneous material.

12. All exotic plant material must be removed prior to C.O.

P	hase 1	Plant List
TREES	CODE QTY	BOTANICAL NAME / COMMON NAME


TREES	CODE	<u>QTY</u>	BOTANICAL NAME / COMMON NAME	CONTAINER	CALIPER	<u>HEIGHT</u>	SPREAD
\odot	BS	5	Bursera simaruba / Gumbo Limbo*+ Single Straight Trunk, Min 5` CT	N/A	2.5" DBH	12`	5`
•	CL	8	Clusia rosea / Autograph Tree Standard, Min. 4` CT, Min. 1.5" Cal	N/A	2.5"Cal	12`	6`
•	CE	5	Conocarpus erectus / Green Buttonwood Single Straight Trunk, Min. 2.5" Cal., No Low Crotch, Min. 5` CT	N/A	2.5"Cal	12`	6`
\odot	CS	38	Conocarpus erectus sericeus / Silver Button Wood*+ Single Straight Trunk., 5` CT Min.	N/A	2.5"Cal	12`	6`
\bigcirc	СО	4	Cordia sebestena / Orange Geiger Tree*+ Single Straight Trunk, Min. 5` CT	N/A	2.5"Cal	12`	6`
	IC	27	llex cassine / Dahoon Holly*+ Single Straight Trunk, Min. 5` CT.	N/A	2.5"Cal	12`	6`
	LI	17	Lagerstroemia indica `Tuscarora` / Crape Myrtle Multi-Trunk+ Multi-Trunk, Min. 5` CT.	N/A	2.5"Cal	12`	6`
	QH	6	Quercus virginiana `High Rise` / High Rise Live Oak *+ Single Straight Trunk, Min. 8` CT, To be Planted in Tree Grates with Structural Soil Where Indicated	N/A	3.5"Cal	16`	6`
$\overline{}$	SP	71	Sabal palmetto / Sabal Palm*+ Slick Trunks, Hurricane Cut, Stagger Heights	N/A	N/A	12-18` CT.	N/A
0	WR	6	Washingtonia robusta / Mexican Fan Palm Full, Stagger heights	N/A	N/A	22` - 28` OA	10`
<u>SHRUBS</u>	CODE	QTY	BOTANICAL NAME / COMMON NAME	CONTAINER	SPACING	<u>HEIGHT</u>	SPREAD
\odot	CHI	921	Chrysobalanus icaco / Coco Plum*+ Full To Base	3 gal. min.	24" o.c.	24"	24"
\oplus	CAQ	6	Crinum augustum `Queen Emma` / `Queen Emma` Crinum Full	7 gal. min.	36" o.c.	30"	30"
(A)	MYF	13	Myrcianthes fragrans / Simpson`s Stopper *+ Full	7 gal. min.	24" o.c.	36"	24"
lacktriangle	MYC	49	Myrica cerifera / Wax Myrtle*+ Full to Base	25 Gal. Min.	5` o.c.	6`	4`
•	PAI	14	Passiflora incarnata / Passion Flower Vine Attach to Fence	3 Gal. Min.	As Shown	24"	18"
\odot	TRF1	207	Tripsacum floridanum / Dwarf Fakahatchee Grass*+ Full To Base	3 gal	30" o.c.	24"	24"

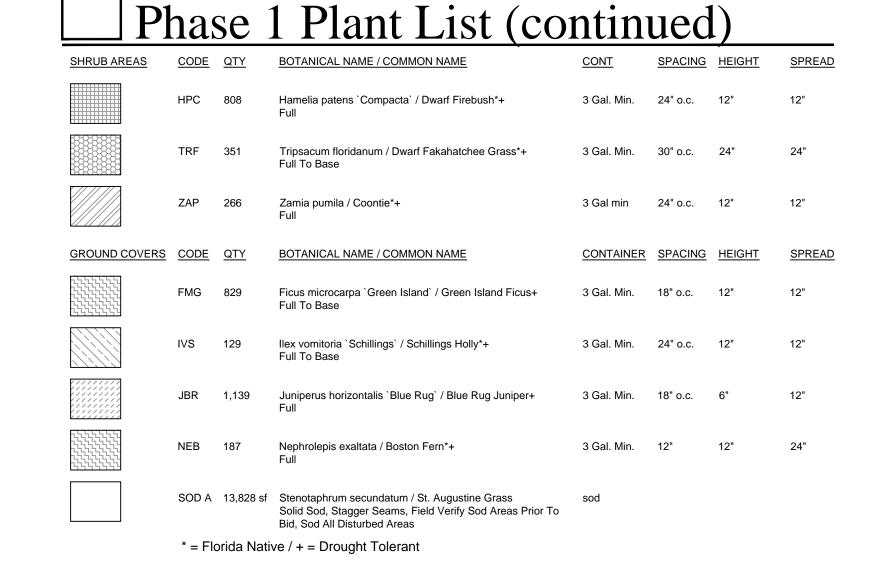

262'


MLKBLEVD Existing Tree, Typ. Existing 2.7' Wall Selectively Remove End of Existing Wall Existing Landscape to Install Sidewalk Existing 8' Chain Link Fence Extension **Existing Detention** -10' Landscape Buffer,

AFFECTED AREA

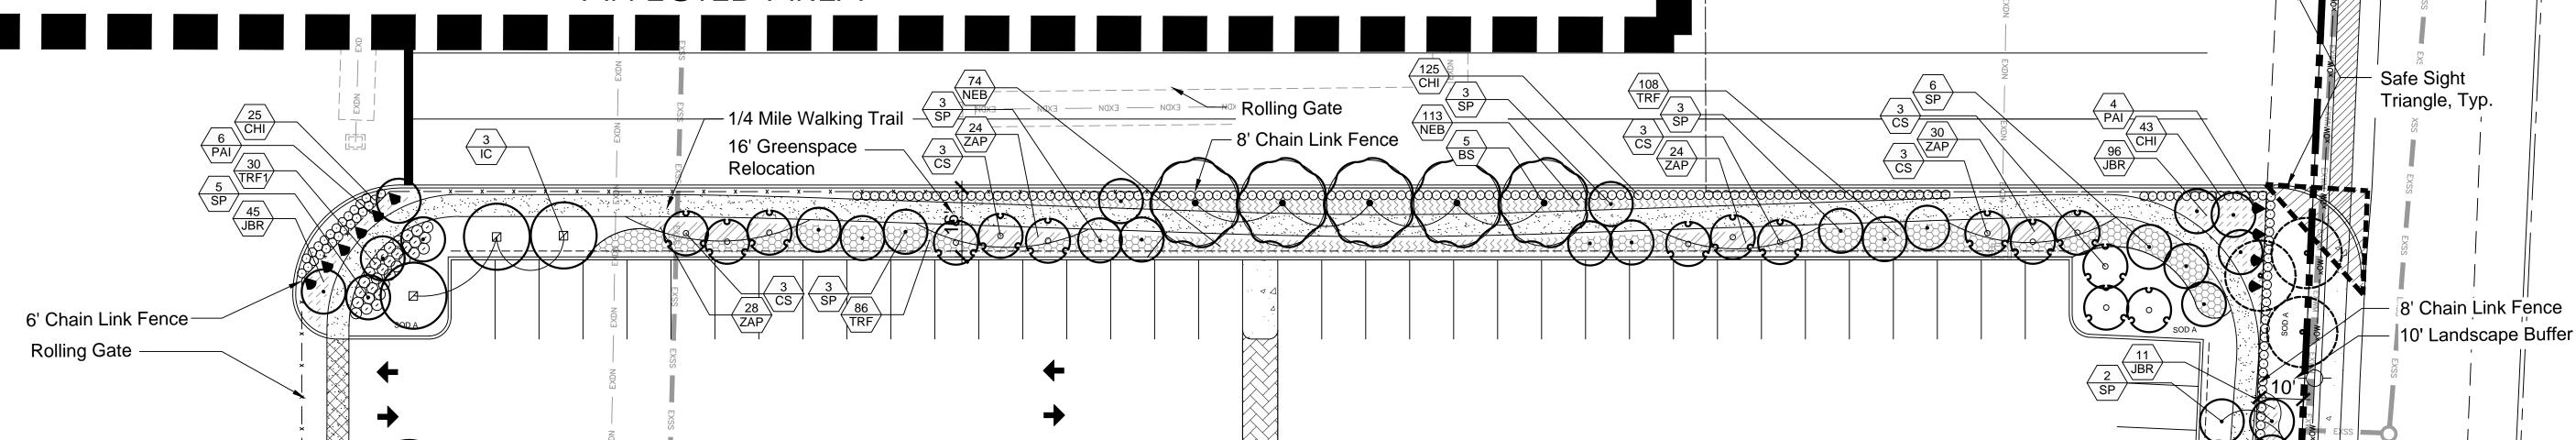

MATCHLINE B-B SHEET LP-2




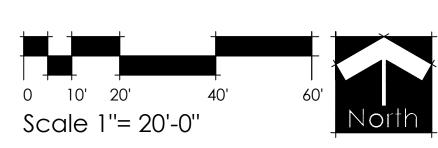

Phase 1 Landscape Plan

Jon E. Schmidt and Associates Landscape Architecture & Site Planning 2247 Palm Beach Lakes Blvd.- Suite 101 West Palm Beach, Florida 33409 Tel. (561) 684-6141 • Fax. (561) 684-6142 E-mail: Jschmidt@jesla.com Website: www.jesla.com License No.: LC26000232

5/21/14 1'' = 20'-0'' Drawn By: Checked By: 14-08

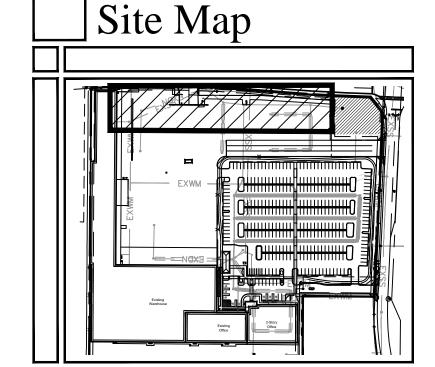

Landscape Notes

- Easements shall not encroach landscape buffers more than 5 feet.
 Landscaping in right-of-way buffers shall be installed on the exterior side of walls or fences.
- Walls & fences shall be setback a min. of 10' from the ultimate R-O-W.
 FDOT Type D or F curb shall be provided along the perimeter of all landscape, open space, drainage and grassed
- areas adjacent to paved vehicular use areas, except where wheel stops are provided.


 5. Safe sight triangles shall be maintained clear of vegetation to provide unobstructed visibility between 30" and 8' above crown of road.
- 6. Light poles, fire hydrants, electrical/mechanical equipment, signs, drainage structures, etc. shall not interfere with landscaping in terminal islands, parking islands, medians, buffers or other landscaped areas.7. All plant material is to be installed a the height, spread and DBH/Caliper shown in the Plant List, container sizes are
- given as a suggestion only.

 8. All landscape areas (including sod) shall be irrigated with an underground automatic sprinkler system providing 100% coverage.
- coverage.
 9. Trees shown on this plan are for graphic representation only. Tree spacing is based on design requirements and the trees shown on these plans attempt to accomplish that spacing while maintaining the required setbacks from utilities.
 Trees may be field adjusted to avoid conflicts with driveways and underground utilities. In any case the trees shall be
- located in the field in accordance with the planting details shown hereon.

 10. Trees are to be installed with a ten foot (10') separation from any water or sewer main and/ or service, hydrants, and lift stations. If a ten foot (10') separation cannot be achieved, the tree can be installed with a root barrier system. Refer to the "Root Barrier" detail for installation requirements. However, in no case shall a tree encroach into a PBCUE without prior PBCWUD approval and only sod can be installed within 7.5' of a fire hydrant unless otherwise approved by the Fire
- 11. All planters shall be excavated to a minimum depth of twenty-four (24) inches and back-filled with a suitable soil consisting of fifty percent (50%) composted organic matter, well-mixed with native soil. Backfill material shall be free from rock, construction debris, or other extraneous material.

 12. All exotic plant material must be removed prior to C.O.

Upgraded Area Plant List

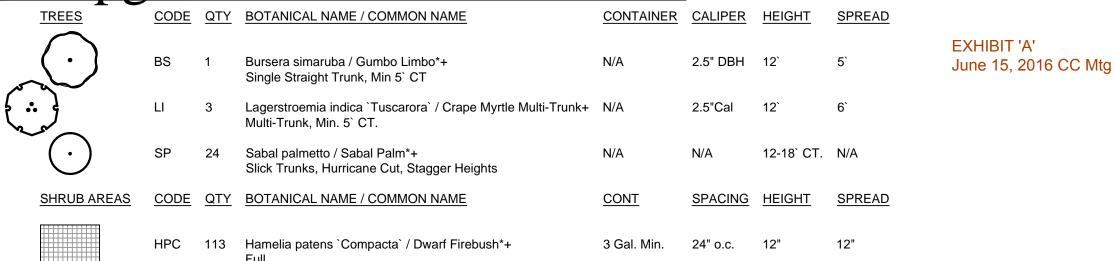

Affected Area Landscape Requirements

Category Requirement No. Required No. Provided


=	j mneeted mea Landse			
	Category	Requirement	No. Required	No. Provided
Perimeter	Trees: NE Denention Buffer 312' South Property Line 200' East Property Line (Ave. P) 394' East Building Buffer 137'	20 l.f. 20 l.f. 20 l.f. 20 l.f.	16 10 20 7	16 (4 ex.) 10 (0 ex.) 20 (7 ex.) 9
Ш	TOTAL BUFFER TREES		53	55
	Hedge: NE Denention Buffer 312' South Property Line 200' East Property Line (Ave. P) 394' East Building Buffer 137'	6' Hedge Hedge Hedge Hedge	6' Hedge Hedge Hedge Hedge	49 108 310 79
Ш	TOTAL HEDGE			546
	Groundcover: NE Denention Buffer 312' South Property Line 200' East Property Line (Ave. P) 394' East Building Buffer 137'	25% 25% 25% 25%	78' 50' 99' 35'	80' 52' 120' 35'
	TOTAL GROUNDCOVER		262'	287'
	Category	Requirement	No. Required	No. Provided
\prod	Landscape Area (Affected Area: 227,182 sf)	20% Site	45,437 sf	52,092 sf
Ц	Total Landscape Area Required		45,437 sf	52,092 sf
	Category	Requirement	No. Required	No. Provided
	Interior Landscape Area	50% of Required	22,719 sf	39,802 sf
	Category	Requirement	No. Required	No. Provided
	Terminal Island Trees (31 Islands) Interior Island Trees (3 Islands) Foundation Trees (150' Adjacent to Parking Only) Additional Greenspace Trees	1/Island 1/Island 1/20 If NA	31 3 8 NA	46 3 1* 45 (7 ex)
	TOTAL INTERIOR TREES	147.	47	95
님		D : .		
님	Category	Requirement	No. Required	
11	Overall Site Trees (Site: 227,182 sf) (INCLUDES TREES COUNTED FOR	1/1500 sf	152	152 (95 Int.)

* Foundation Trees Relocated to Greenspace to provide shade to pathway, parking and increase buffering of site.


Upgraded Area Notes

 Upgraded area improvements are not included in the affected area landscape requirements, and are additional to the numbers seen in the chart.

UPGRADED AREA

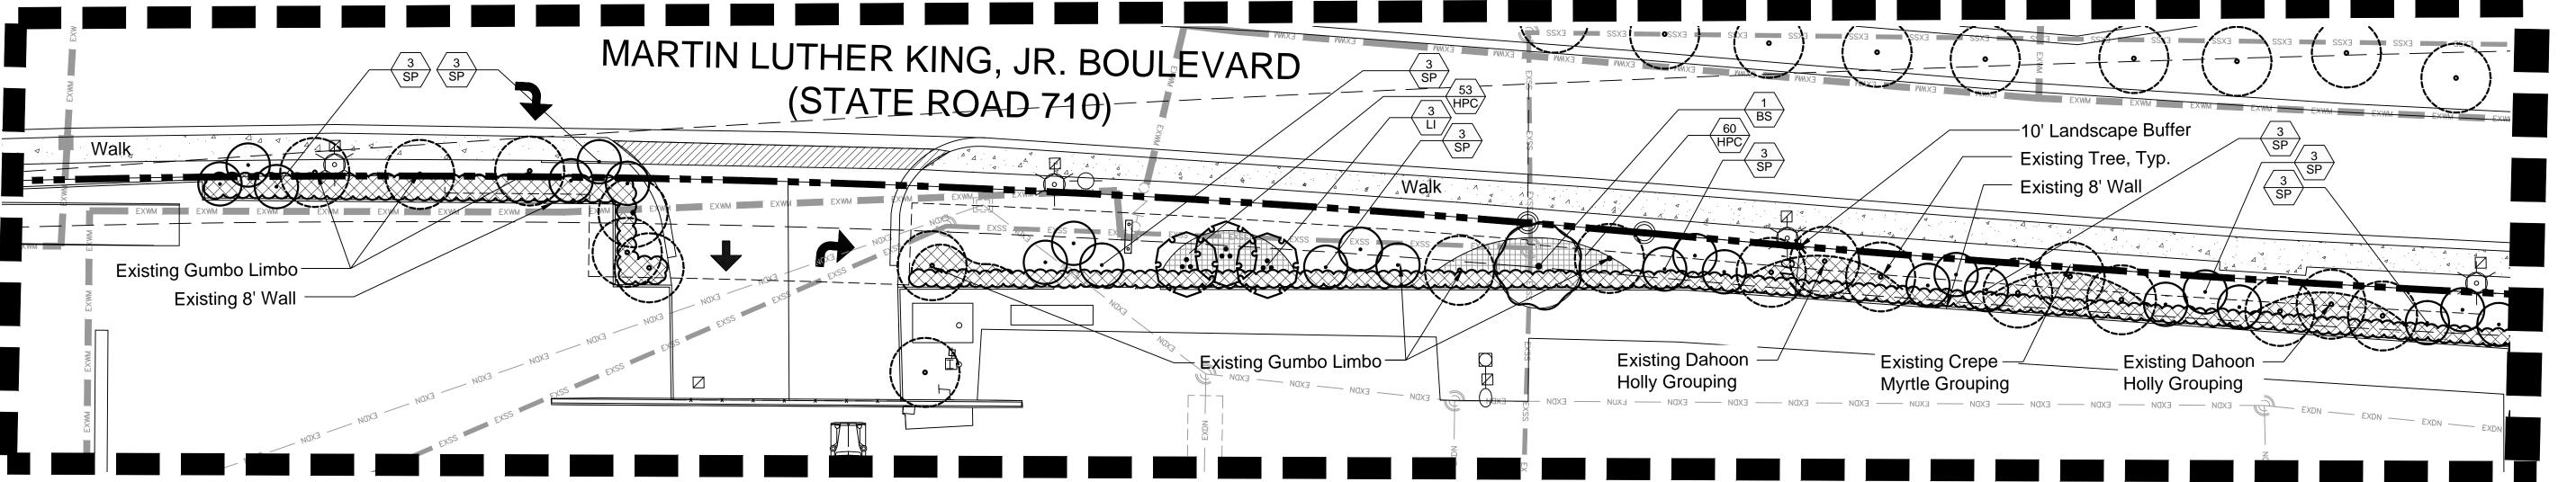

UPGRADED AREA

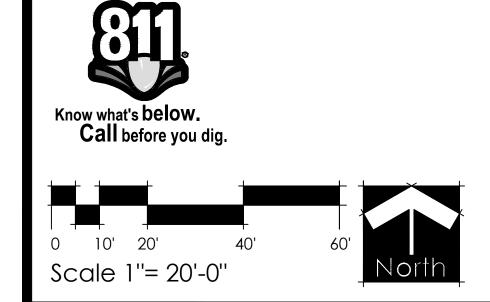

Date: 5/21/14
Scale: 1" = 20'-0"
Design By: JES
Drawn By: BMC
Checked By: Jes
File No. 688.01
Job No. 14-08

Jon E. Schmidt and Associates
Landscape Architecture & Site Planning

2247 Palm Beach Lakes Blvd.- Suite 101

Tel. (561) 684-6141 • Fax. (561) 684-6142

West Palm Beach, Florida 33409

E-mail: Jschmidt@jesla.com Website: www.jesla.com License No.: LC26000232

REVISIONS / SUBMISSIONS

09/30/14 Staff Comments
10/03/14 Fencing Revision
01/13/15 MYC Spec
10/14/15 FPL Pad/Easment Re
11/10/15 Entry Revisions
03/17/16 Revise per Civil

Phase 1 Landscape Plan

LP-4 of ϵ

1.01 WORK INCLUDED

- Extent of planting work is shown on drawings and in schedules. Subgrade Elevations: Excavation, filling and grading required to establish elevations 4" lower than elevations and contours shown on drawings are not
- specified in this Section. C. Finish Grade Elevations: 1 inch below top of pathway edging.

1.02 QUALITY ASSURANCE

- A. Subcontract landscape work to a single firm specializing in landscape work. B. Source Quality Control:
 - 1. General: Ship landscape materials with certificates of inspection required by governing authorities. Comply with regulations applicable to landscape materials.
 - 2. Do not make substitutions. If specified landscape material is not obtainable, submit to Landscape Architect proof of non-availability and proposal for use of equivalent material. When authorized, adjustment of contract amount will be made.
 - Analysis and Standards: Package standard products with manufacturer's certified analysis. For other materials, provide analysis by recognized laboratory made in accordance with methods established by the Association of Official Agricultural Chemists, wherever applicable.
 - 4. Trees, Palms and Shrubs: Provide trees, palms and shrubs grown in a recognized nursery in accordance with good horticultural practice. Provide healthy, vigorous stock free of disease, insects, eggs, larvae, and defects such as decay, knots, sun-scald, injuries, abrasions disfigurement. Provide trees, palms and shrubs for grade needed as outlined under Grades and Standards for Nursery Plants, State Plant Board of Florida, unless otherwise noted.
 - a. Sizes: Provide trees and shrubs of sizes shown or specified. Trees, palms and shrubs of larger size may be used if acceptable to Landscape Architect, and if sizes of roots or balls are increased proportionately.
- C. Inspection: Landscape Architect reserves right to inspect trees, palms and shrubs either at place of growth or at site before planting, for compliance with requirements for name, variety, size and quality.

1.03 SUBMITTALS

- A. Certification: Submit certificates of inspections as required by governmental authorities, and manufacturer's or vendor's certified analysis for soil amendments and fertilizer materials. Submit other data substantiating that materials comply with specified requirements
- B. Submit seed vendor's certified statement for each grass seed mixture required, stating botanical and common name, percentage by weight, and percentage of purity, germination, and weed seed for each grass seed species. Planting Schedule:
- Submit planting schedule showing schedule dates for each type of planting in each area of site. Maintenance Instructions:
- Submit typewritten procedures for maintenance of landscape work.

1.04 DELIVERY, STORAGE AND HANDLING

- A. Packaged Materials: Deliver packaged materials in original containers showing weight analysis and name of manufacturer. Protect materials from deterioration during delivery, and while stored at site.
- Sod: Time delivery so that sod will be placed within 24 hours after stripping. Protect sod against drying and breaking of rolled strips. C. Trees, palms and shrubs: Provide freshly dug trees, palms and shrubs. Do not
- prune prior to delivery. Do not bend or bind—tie trees or shrubs in such a manner to damage bark, break branches or destroy natural shape. Provide protective covering during delivery. D. Deliver trees, palms and shrubs after preparations for planting have been
- completed and plant immediately. If planting is delayed more than 6 hours after delivery, set trees and shrubs in shade, protect from weather and mechanical damage, and keep roots moist.
- E. Do not remove container grown stock from containers until planting time

1.05 JOB CONDITIONS A. Proceed with and complete landscape work as rapidly as portions of site become

- B. Utilities: Determine location of underground utilities and perform work in a manner which will avoid possible damage. Hand excavate, as required. Maintain grade stakes set by others until removal is mutually agreed upon by parties
- Excavation: When conditions detrimental to plant growth are encountered, such as rubble fill, adverse drainage conditions, or obstructions, notify Landscape Architect before planting.
- D. Planting Schedule: Where applicable, prepare a proposed planting schedule. Schedule dates to establish a logical sequence for completing each type of landscape work to avoid damage to other landscape work and work performed by other disciplines. Correlate with specified maintenance periods to provide maintenance from date of substantial completion. Once accepted, revise dates
- only as approved in writing, after documentation of reasons for delay. Coordination with Lawns: Plant trees, palms and shrubs after final grades are established and prior to planting of lawns, unless otherwise acceptable to Landscape Architect. If planting of trees, palms and shrubs occurs after lawn work, protect lawn areas and promptly repair damage to lawns resulting from planting operations.

1.06 SPECIAL PROJECT WARRANTY

- Warrant lawns through specified maintenance period, and until final acceptance. The required period is for one full year following installation of lawn areas. B. Warrant trees for a period of one year after date of substantial completion against defects death and unsatisfactory growth, except for defects resulting from neglect by Owner, abuse or damage by others, or unusual phenomena or
- incidents which are beyond Landscape Contractor's control. Warrant shrubs for 1 full year after date of substantial completion. Remove and replace trees, shrubs or other plants found to be dead or in unhealthy condition during warranty period. Make replacements during growth season following end of warranty period. Replace trees and shrubs which are in doubtful condition at end of warranty period; unless, in opinion of the Landscape Architect, it is advisable to extend warranty period for a full growing season or for
- 1. Another inspection will be conducted at end of extended warranty period, to determine acceptance or rejection. Only one replacement will be required at end of warranty period, except for losses or replacements due to failure to comply with specified requirements.

PART 2 PRODUCTS

- A. If topsoil is not available on site it must be furnished as specified. Throughout all parts of site where finish grades and contour lines differ from existing contour lines, bring to finish grade contours shown on "Grading Plan."
- B. Topsoil shall be friable fertile soil with representative characteristics of area soils. It should be free of heavy clay, silt, stone, extraneous lime, plant roots and other foreign matter greater than 1 1/2" in diameter. It shall not contain noxious plant growth (such as bermuda or nut grass). It shall test in neutral Ph range of 5.0 to 6.75 and contain no toxic substances that can be deemed to impede plant growth. The contractor shall be prepared to have soil lab-tested at his expense by the Landscape Architect. Topsoil shall comply with the following quantative

COMPONENTS	VOLUME MEASURE	PARTICLE SIZE
Organic Matter Silt Sand Clay	3 - 5% 10 - 30% 25 - 75% 5 - 25%	0.05 to 0.002 MM 0.2 to 0.05 MM 0.002 MM and below
•		

2.02 SOIL AMENDMENTS If necessary to bring soil into above specified limits:

- A. Lime: Natural limestone (Dolomite) containing not less than 85% of total carbonates, ground so that not less than 90% passes a 10-mesh sieve and not
- less than 50% passes a 100-mesh sieve. B. Peat Humus or Peat Moss: Texture, moisture and pH range suitable for intended
- Humus Soil Conditioner: Consisting of yard trimmings and biosolids co-compost. Commercial Fertilizer: Complete fertilizer of neutral character, with 40% - 50% of the total nitrogen in a water insoluble form. It shall be uniform in composition, dry and free flowing.

- 1. For trees, palms and shrubs, provide fertilizer with not less than 6%
- available phosphoric acid, 6% nitrogen and 6% soluble potash. For lawns, provide fertilizer with not less than 6% phosphoric acid, and 6% potassium, and percentage of nitrogen required to provide not less than 1 lb. of actual nitrogen per 1000 square feet of lawn area. Provide nitrogen in a form that will be available to lawn during initial period of

2.03 PLANT MATERIAL

- A. Plant list is part of this specification section. B. Quality: Trees, palms, shrubs and other plants shall conform to the standards for Florida No. 1 or better as given in the latest edition of Grades and Standards for
- Nursery Plants, State Plant Board of Florida. C. Deciduous Trees: Provide trees of height and caliper listed or shown and with branching configuration for No. 1 graded trees in Grades and Standard for Nursery Plants for type and species required. Provide single stem trees except where special forms are shown or listed. Ball condition variable.
- D. Coniferous and Broadleafed Evergreens: Provide evergreens of size shown or listed. Dimensions indicate minimum height and spread. Provide specified quality evergreens with well-balanced form complying with requirements for other size relationships to the primary dimension shown.

2.04 GRASS MATERIALS

A. Grass Seed: Provide fresh, clean, new-crop seed complying with established tolerance for purity and germination. Provide seed of grass species, proportions and minimum percentages of purity, germination, and maximum percentage of weed seed, as specified. Attach a schedule of requirements. B. Sod: Provide strongly rooted sod free of weeds and undesirable native grasses.

2.05 MISCELLANEOUS LANDSCAPE MATERIALS

A. Ground Cover: Provide plants established and well-rooted in removable containers or internal peat pots and with not less than minimum number and length of runners specified.

capable of growth and development when planted.

- B. Anti-Erosion Mulch: Provide clean, dry, mulching hay or straw of coastal bermuda, pangola or bahia grass. Only undeteriorated mulch which can be readily cut into the soil shall be used.
- Mulch: Melaleuca or equal. D. Stakes and Guys: When required provide stakes and deadmen of sound new hardwood, treated softwood, or redwood, free of knot holes and other defects. Provide wire ties and guys of 2—strand, twisted, pliable galvanized iron wire not lighter than 12 ga. with zinc-coated turnbuckles. Provide not less than 1/2" hose, cut to required lengths to protect tree trunks from damage by wires.

PART 3 EXECUTION

3.01 LAYOUT

A. Layout individual trees and shrub locations and areas for multiple plantings. Stake locations and outline areas and secure Landscape Architect's acceptance before start of planting work. Make adjustments as maybe required.

3.02 PREPARATION OF PLANTING SOIL

- A. Before mixing, clean topsoil of roots, plants, sods, stones, clay lumps, and other extraneous materials harmful or toxic to plant growth. B. Mix specified soil amendments and fertilizers with topsoil at rates specified. Delay mixing of fertilizer if planting will not follow placing of planting soil within a few
- C. For planting beds, mix planting soil either prior to planting or apply on surface of topsoil and mix thoroughly before planting.
 - Mix lime with dry soil prior to mixing of fertilizer.
- Prevent lime from contacting roots of acid—loving plants. D. Remove all shellrock encountered and backfill with clean sand or sand/soil mix.
- 3.03 PREPARATION FOR PLANTING AREAS (To include Lawn and Planting Bed Areas)

site soil prior to backfilling of the planting holes around the rootballs

A. Spread a layer of 2 to 3 inches of humus soil conditioner over the entire planting area. Planting areas shall include all new sod areas, shrub areas and tree areas. These areas shall be as large as 3 times the diameter of the beds of the plants, except where confined by hardscape features such as paved parking areas, paved walk ways, structures, etc. Overlapping areas shall be considered to be one large planting area for the entire mass. The humus soil conditioner shall then be uniformly disked, tilled or aerified into the existing soil to a depth of 6 to 8 inches with the following exception: no rototilling shall occur closer to the trunks of established plants than one half the distance to the dripline of the existing plant canopy. All plants, including hedges and ground cover shall be planted in individually dug holes

and the material dug from the holes shall then be further mixed with the prepared

3.04 PREPARATION FOR PLANTING LAWNS

- A. Preparation of Unchanged Grades: Where lawns are to be planted in areas that have not been altered or disturbed by excavating, grading, or stripping operations, prepare soil for lawn planting as follows: Till to a depth of not less than 6"; apply soil amendments and initial fertilizers; remove high areas and fill in depressions; till soil to a homogenous mixture of fine texture, free of lumps, clods, stones, roots and other extraneous matter.
 - 1. Prior to preparation of unchanged areas, remove existing grass, vegetation and turf. Dispose of such material outside of Owner's property; do not turn over into soil being prepared for lawns.
- B. Elsewhere: Loosen subgrade of lawn areas to a minimum depth of 4". Remove stones over 1 1/2" in any dimension and sticks, roots, rubbish and other extraneous matter. Limit preparation to areas which will be planted promptly after
 - 1. Spread planting soil mixture to minimum depth required to meet lines,
 - grades and elevations shown, after light rolling and natural settlement. Place approximately 1/2 of total amount of planting soil required. Work into top of loosened subgrade to create a transition layer and then place remainder of planting soil.
- 3. Allow for sod thickness in areas to be sodded.
- C. Grade lawn areas to smooth, even surface with loose, uniformly fine texture. Roll and rake and remove ridges and fill depressions, as required to meet finish grades. Limit fine grading to areas which can be planted immediately after
- D. Moisten prepared lawn areas before planting if soil is dry. Water thoroughly and allow surface moisture to dry before planting lawns. Do not create a muddy soil
- E. Restore lawn areas to specified condition if eroded or otherwise disturbed after fine grading and prior to planting.

3.05 PREPARATION OF PLANTING BEDS

- A. Loosen subgrade of planting bed areas to a minimum depth of 12" using a cultimulcher or similar equipment Remove stones over 1 1/2" in any dimension, and sticks, stones, rubbish and other extraneous matter. Spread planting soil mixture to minimum depth required to meet lines, grades and elevations shown, after light rolling and natural settlement. Place approximately 1/2 of total amount of planting soil required. Work into top of loosened subgrade to create a transition layer, then place remainder of the planting soil. Add soil amendment.
- Excavation for Tress and Shrubs: Excavate pits, beds and trenched with vertical sides and with bottom of excavation slightly raised at center to provide proper drainage. Loosen hard subsoil in bottom of excavation.
- 1. For balled and burlapped (B & B trees and shrubs), make excavations at least half again as wide as the ball diameter and equal to the ball depth.
- 2. For container grown stocks, excavate as specified for balled and burlapped stock, adjusted to size of container width and depth.
- Dispose of subsoil removed from landscape excavations. Do not mix with planting soil or use as backfill. Fill excavations for trees and shrubs with water and allow to percolate out before planting.

3.06 PLANTING TREES, PALMS AND SHRUBS

- A. Lay out individual trees, palm and shrub locations and areas for multiple plantings where required. Stake locations and outline areas and secure Landscape Architect's acceptance before start of planting work. Make adjustments as may be required.
- B. Set balled and burlapped (B&B) stock on layer of compacted planting soil mixture, plumb and center of pit or trench with top of ball at same elevation as adjacent finished landscape grades. Remove burlap from sides of balls; retain on bottoms. When set, place additional backfill around base and sides of ball, and work each layer to settle backfill and eliminate voids and air pockets. When excavation is approximately 2/3 full, water thoroughly before placing remainder of backfill. Repeat watering until no more is absorbed. Water again after placing final layer

- C. Set container grown stock as specified for balled and burlapped stock, except cut
- cans on 2 sides with an approved can cutter; remove bottoms of wooden boxes after partial backfilling so as not to damage root balls. Dish top of backfill to allow for mulching.
- Mulch pits, trenches and planting areas. Provide not less than following thickness of mulch and work into top of backfill and finish level with adjacent finish grades: Provide 3" thickness of mulch.
- Guy and stake trees immediately after planting , as indicated.

- All pruning shall be done on the site before planting as directed by Landscape Architect. Pruning shall follow modern horticultural practices (Grades and Standards for Nursery Plants) and shall be done with approved tools designed for the purpose intended. Lopping, topping, or shearing of trees or shrubs will be grounds for rejecting the plants as unsuitable and not meeting requirements. Damaged, scarred, frayed, split, or skinned branches, limbs or roots shall be pruned back to line wood nearest to the next sound outside lateral bud, branch, limb or root. The terminal leader or bud in all trees or shrubs shall be left intact and not removed unless damaged.
- Prune, thin out and shape trees and shrubs. Prune trees to retain required height and spread. Unless otherwise directed by Landscape Architect, do not cut tree leaders, and remove only injured or dead branches from flowering trees, if any. Prune shrubs to retain natural character.

3.08 SODDING NEW LAWNS

- Lay sod within 24 hours from time of stripping. Lay sod to form a solid mass with tightly fitted joints. Butt ends and sides of sod strips; do not overlap. Stagger strips to offset joints in adjacent courses. Work from boards to avoid damage to subgrade or sod. Tamp or roll tightly to ensure contact with subgrade. Work sifted soil into minor cracks between pieces to sod;
- remove excess to avoid smothering of adjacent grass. C. Water sod thoroughly with a fine spray immediately after planting.

3.09 MAINTENANCE

- Begin maintenance immediately after planting.
- Maintain trees, palms, shrubs and other plants until final acceptance but in no case less than following period: 30 days after substantial completion of planting. C. Maintain trees, palms, shrubs and other plants by pruning, cultivating and weeding as required for healthy growth. Restore planting saucers. tighten and repair stake and guy supports and reset trees and shrubs to proper grades or

vertical position as required. Restore or replace damaged wrappings. Spray as

- required to keep trees and shrubs free of insects and diseases. Remove and replace excessively pruned or misformed stock resulting from
- Maintain lawns for not less than the period stated below, and longer as required to establish an acceptable lawn.
- Sodded lawns, not less than 30 days after substantial completion. 2. Seeded lawns, not less than 60 days after substantial completion.
- F. Maintain lawns by watering fertilizing, weeding, mowing, trimming, and other operations such as rolling, regrading and replanting as required to establish a
- smooth, acceptable lawn, free of eroded or bare areas. Landscape Contractor is responsible for watering all sod and plant materials from day of installation through final acceptance even if irrigation is not in place, unless this responsibility is assumed in writing by another party.
- H. Landscape Contractor is to maintain the site weed—free untill acceptance by the Owner.

3.10 CLEANUP AND PROTECTION A. During landscape work, keep pavement clean and work area in an orderly

Protect landscape work and materials from damage due to landscape operations, operations by other contractors and trades and trespassers. Maintain protection during installation and maintenance periods. Treat, repair or replace damaged landscape work as directed.

3.11 INSPECTION AND ACCEPTANCE


- A. When landscape work is completed, including maintenance, Landscape Architect will, upon request, make an inspection to determine acceptability. Landscape work may be inspected for acceptance in parts agreeable to Landscape Architect, provided work offered for inspection is complete, including maintenance.
- Seeded lawns will be acceptable provided requirements, including maintenance, have been complied with, and healthy, uniform close stand of specified grass is established, free of weeds, bare spots and surface irregularities (95% coverage required for acceptance). Sodded lawns will be acceptable provided requirements, including maintenance,
- have been complied with, and healthy, well-rooted, even-colored, viable lawn is established, free of weeds, open joints and bare areas (95% coverage required for acceptance). Where inspected landscape work does not comply with requirements, replace rejected work and continue specified maintenance until reinspected by Landscape Architect and found to be acceptable. Remove rejected plants and materials promptly from project site.

- A. An automatic irrigation system providing 100% coverage with 50% overlap
- is to be provided. A rain sensor is required on all Irrigation Systems.
- C. Provide an as built drawing of the irrigation system to the Landscape Architect.

LANDSCAPE AND ROOT BARRIER NOTE:

Trees shown on this plan are for graphic reprsentation only. Tree spacing is based on design requirements and the trees shown on this plans attempt to accomplish that spacing while maintaining the required setbacks from utilities. Trees may be field adjusted to avoid conflicts with driveways and underground utilities. In any case the trees shall be located in the filed in accordance with the planting details shown hereon.

Additionally, trees are to be installed with a ten foot (10') separation from any water or sewer main and/or service, hydrants, and lift stations. If a ten foot (10') separation cannot be achieved, the tree can be installed with a root barrier system. Refer to the "Root Barrier" detail for installation requirements.

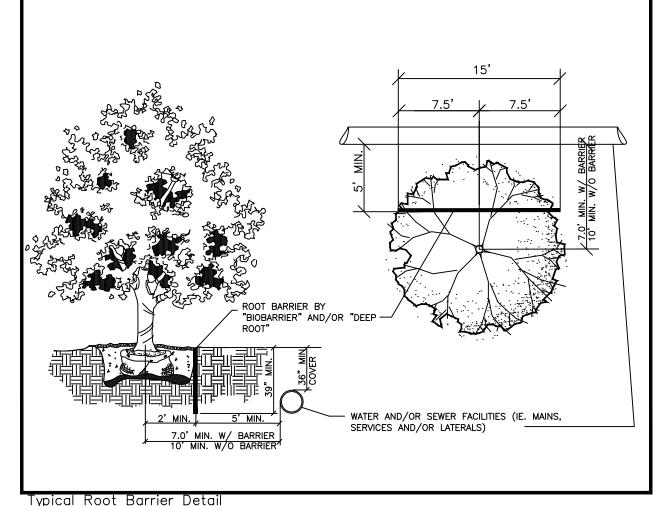

LANDSCAPE NOTES

EXHIBIT 'A'

June 15, 2016 CC Mtg

- 1. All proposed material shall be Florida No. 1 or better as set forth in "Grades & Standards for Nursery Plants," Florida Dept. of Agriculture. 2nd Edition 2/98.
- No deviations will be permitted. 2. By submitting a bid, the landscape contractor is responsible for providing the material
- specified on the plans. No substitutions will be accepted without prior written approval and acceptance by the Owner or his representative, or Landscape Architect.
- Materials to be hand-selected at the discretion of the Owner or his representative, or Landscape Architect.
- 4. All work shall proceed in a professional manner in accordance with standard nursery and installation practices.
- Quantities on plant list are for convenience only. Landscape Contractor is responsible for all plants shown on planting plans. When discrepancies occur between plant list and planting plans, the plans are to override the plant list in all cases. Contractor is responsible for confirming sod quantities and certifying such to the Owner or his representative.
- Contractor is responsible for locating all underground utilities prior to digging. Notify the Owner or his representative, or the Landscape Architect immediately regarding discrepancies or conflicts.
- Landscape Contractor to notify the Owner or his representative, or Landscape
- Architect at least three (3) working days prior to beginning any stage of work. Owner or Landscape Architect to be immediately notified of any discrepancies
- 9. The Owner or his representative, or Landscape Architect reserve the right to field adjust plant material on-site to avoid conflicts or discrepancies not anticipated in the planning process.
- 10. Existing plant material to be removed, except as noted.
- TREES & PALMS All trees, new and relocated, to be staked and guyed as detailed. No double or multi-trunk trees unless otherwise specified.
- Face of trees and palms to be located a minimum of 2'-0" off all sidewalks/bike paths or other paved surfaces, unless otherwise notated on plans.
- Root suckers on Live Oaks are not acceptable. All trees falling within grassed areas to have a 3" mulch ring with no more tḥan 1" of mulcḥ ḍirectly adgacent to the trunk of the tree. Min. 3' radius mulch
- PLANTING BEDS Groundcover and shrubs to be layed out in a uniform and consistent pattern.

and backfill with planting soil per specifications.


- All planting beds to receive 3" deep shredded mulch per specifications. Landscape Contractor is responsible for verifying that clean top soil, meeting the attached specifications, exists in each planting bed prior to planting. Contractor shall add or amend top soil if necessary. Tree pits shall be backfilled as noted in attached specifications. Excavate all shrub and groundcover beds as specified
- All existing asphalt base material to be removed from planting areas and replaced with clean top soil prior to planting. Final grade within planting areas to be 2" below adjacent paved areas or top of curb.
- Landscape Contractor is responsible for replacing any damaged sod.


All sod areas to receive a 3" top dressing of soil per specifications.


Landscape Architect.

1. All landscape areas (including sod) shall be irrigated with an underground automatic sprinkler system providing 100% coverage, and a rain sensor per attached plans. No landscape installation shall occur until the irrigation system is operational, unless approval is granted by Owner or his representative, or

DFTAILS

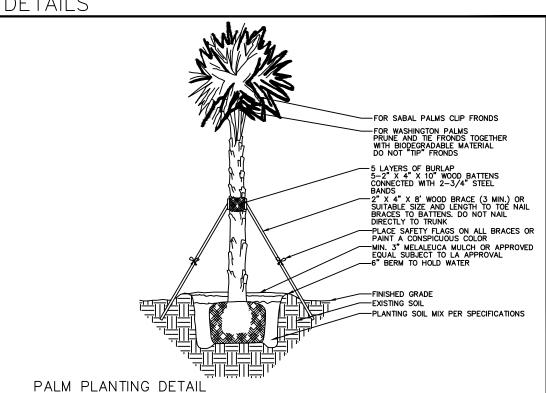

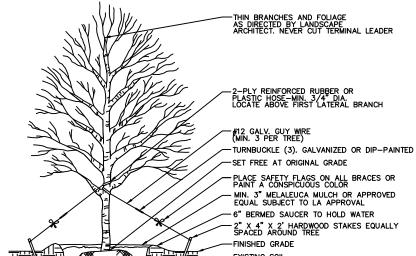

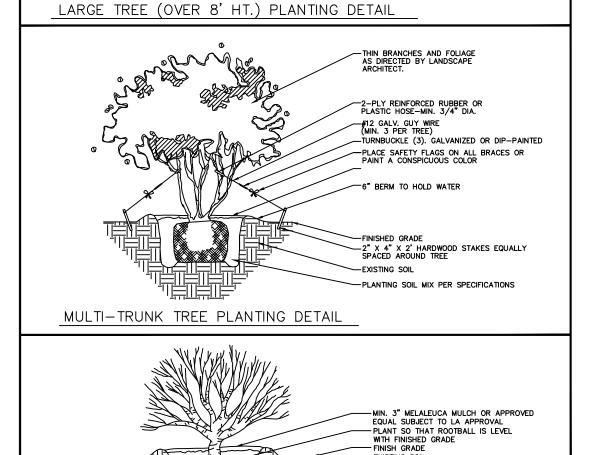

- REMOVE BURLAP FROM TOP 1/3 OF ROOT BALL

NOTES:
1. DO NOT ALLOW AIR POCKETS TO FORM WHEN BACK FILLING
2. LEAVE 10" OF STAKE ABOVE GRADE FOR REMOVAL

—EXCAVATE SHRUB AND GROUND COVER BEDS TO 24" DEPTH AND BACK FILL WITH PLANTING SOIL. SEE SPECIFICATIONS FOR PLANTING SOIL MIX.

HRUB AND GROUND COVER DETAIL

Jon E. Schmidt and Associates Landscape Architecture & Site Planning 2247 Palm Beach Lakes Blvd.- Suite 101 West Palm Beach, Florida 33409 Tel. (561) 684-6141 • Fax. (561) 684-6142 E-mail: Jschmidt@jesla.com Website: www.jesla.com License No.: LC26000232

ach

5/21/14 'Date: 1" = 20'-0" Scale: JES Design By: BMCDrawn By: Checked By: 688.01 File No.

TREVISIONS / SUBMISSIONS

14-08


09/30/14 Staff Comments 10/03/14 Fencing Revision 01/13/15 MYC Spec 10/14/15 FPL Pad/Easment Rev. 11/10/15 Entry Revisions


03/17/16 Revise per Civil

<u>05/10/16 Submittal</u>

Job No.

Phase 1 Specs

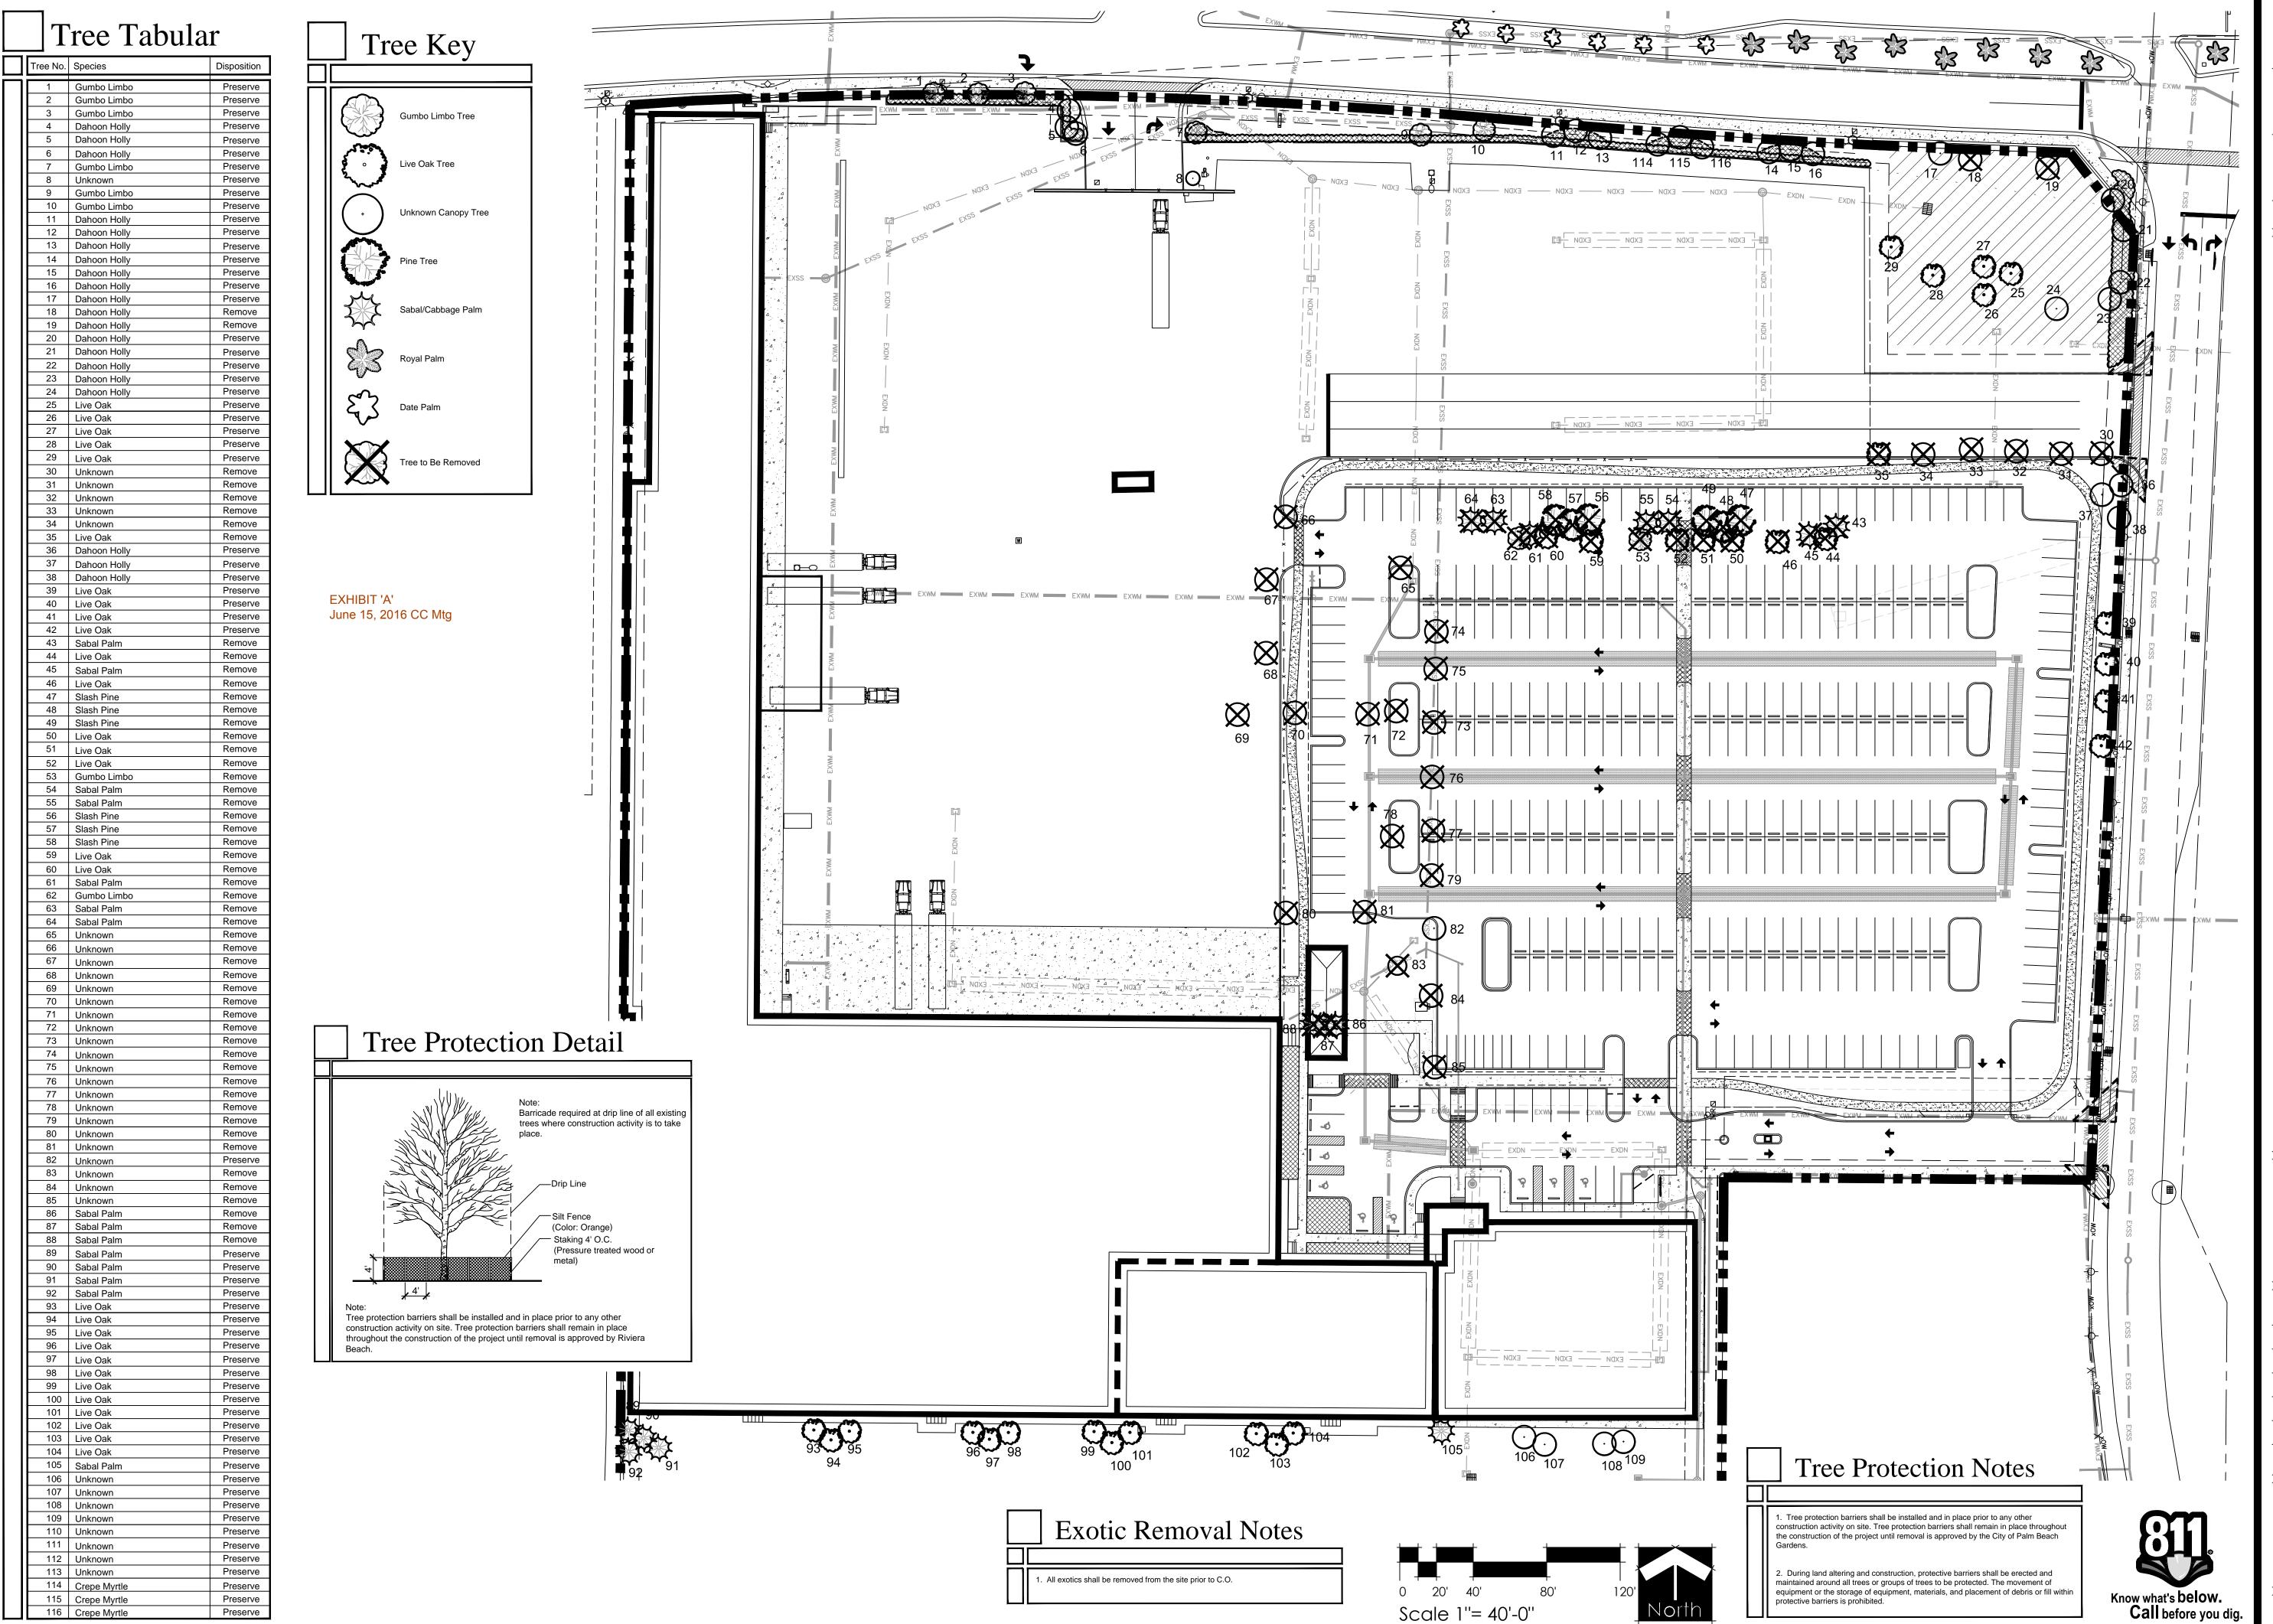

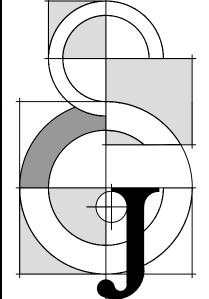

Oate:	09/26/14
cale:	1'' = 40'-0''
Design By:	JES
Drawn By:	ВМС
Checked By:	Jes
ile No.	688.01
ob No.	14-08

REVISIONS / SUBMISSIONS


10/03/14 Fencing Revision 10/14/15 FPL Pad/Easment Rev.

11/10/15 Entry Revisions

03/17/16 Revise per Civil

05/<u>10/16</u> Submittal

Tree Disposition Plan

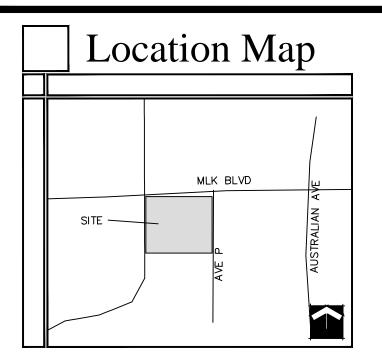

	Parking Greenspace	Relocat	io
	Description	Area	
ODE	6' Divider medians between parking aisles	8.590 s.f.	

	Parking Greenspace	Relocati
	Description	Area
CODE	6' Divider medians between parking aisles	8,590 s.f.
PROP.	Varied width greenspace pushed to outside of parking area	14,214 s.f.

Site Data

	Application Number Name of Project Proposed Use Future Land Use Designatio Tier Zoning District Section, Township, Range Property Control Numbers	56- 56-	TBD Tropical Shipping Office and Warehouse IND Urban/Suburban IG 32/42/43 -43-42-32-35-000-0020 -43-42-32-38-000-0040 -43-42-32-38-000-0030
	Traffic Analysis Zone Total Site Area (Total Gross Floor Area Proposed Office Existing Office Existing Warehouse Total Floor Area Ratio Total Building Coverage (Including canopies of)	582,327 s.f.) 30,000 s.f. 14,524 s.f. 101,694 s.f. 64,368 s.f.	13.3684 acres 146,218 s.f. 25% 34%
	Impervious Area Buildings Pavement/Walks	195,643 s.f. 290,115 s.f.	83%
	Pervious Area	96,569 s.f.	17%
- 11	Building Height Number of Stories		max. 50' 2
	Parking Required Ex. Office— 1 Space/3 Prop. Office— 1 Space, Ex. Warehouse—1 Spac	/300 s.f. @ 30,0	000 s.f. = 100
	Proposed Parking General Parking= 338		344 SPACES
	Motorcycle Parking= 8 Handicap Spaces Required Handicap Spaces Proposed Loading Required (15' x 55 Loading Provided		8 8 3 Loading Yard 3+

Development Regulations


느					_								
		IG PROPERTY DEVELOPMENT REQUIREMENTS											
Ī		ZONING MINIMUM LOT DIMENSIONS					MINIMUM	MAX. BLDG.	MAX. BLDG.			EPARATIONS	
L		DISTRICT	SIZE	WIDTH	DEPTH	FAR	PERV. AREA	COVER	HEIGHT	FRONT	SIDE INTERIOR	SIDE CORNER	REAR
	CODE	IG	1.0 AC.			N/A	N/A	45%	50'	40'	15'	N/A	20'
	PROP.	IG	13.37 AC.			N/A	N/A	34%	40'	632'	15'	N/A	63'


Notes


OBASE INFORMATION FOR THIS PROJECT WAS OBTAINED FROM A BOUNDARY SURVEY PREPARED BY CALVIN, GIORDANO & ASSOCIATES, INC. DATED 4/22/14

Development Team

	*
OWNER:	TROPICAL SHIPPING USA LLC 5 EAST 11TH STREET RIVIERA BEACH, FLORIDA 33404 (561) 881—3900
SURVEYOR:	CALVIN GIORDANO & ASSOCIATES 560 VILLAGE BLVD. SUITE 340 WEST PALM BEACH, FL 33409 (561) 684-6161
CIVIL ENGINEER:	REIKENIS & ASSOCIATES LLC 13081 SE GREEN TURTLE WAY TEQUESTA, FL 33469 (561) 818–5381
ARCHITECT:	LCA ARCHITECTURE, INC. 1975 SANSBURY'S WAY SUITE 108 WEST PALM BEACH, FLORIDA 33411 (561) 493-4787
TRAFFIC ENGINEER:	SIMMONS & WHITE 5601 CORPORATE WAY WEST PALM BEACH, FLORIDA 33407 (561) 478-7848
PLANNER/ LANDSCAPE ARCHITECT:	JON E. SCHMIDT AND ASSOCIATES, INC. 2247 PALM BEACH LAKES BOULEVARD SUITE 101 WEST PALM BEACH, FLORIDA 33409 (561) 684-6141

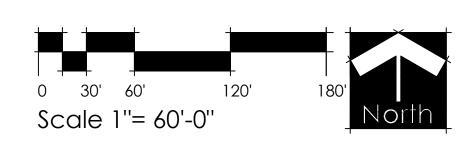

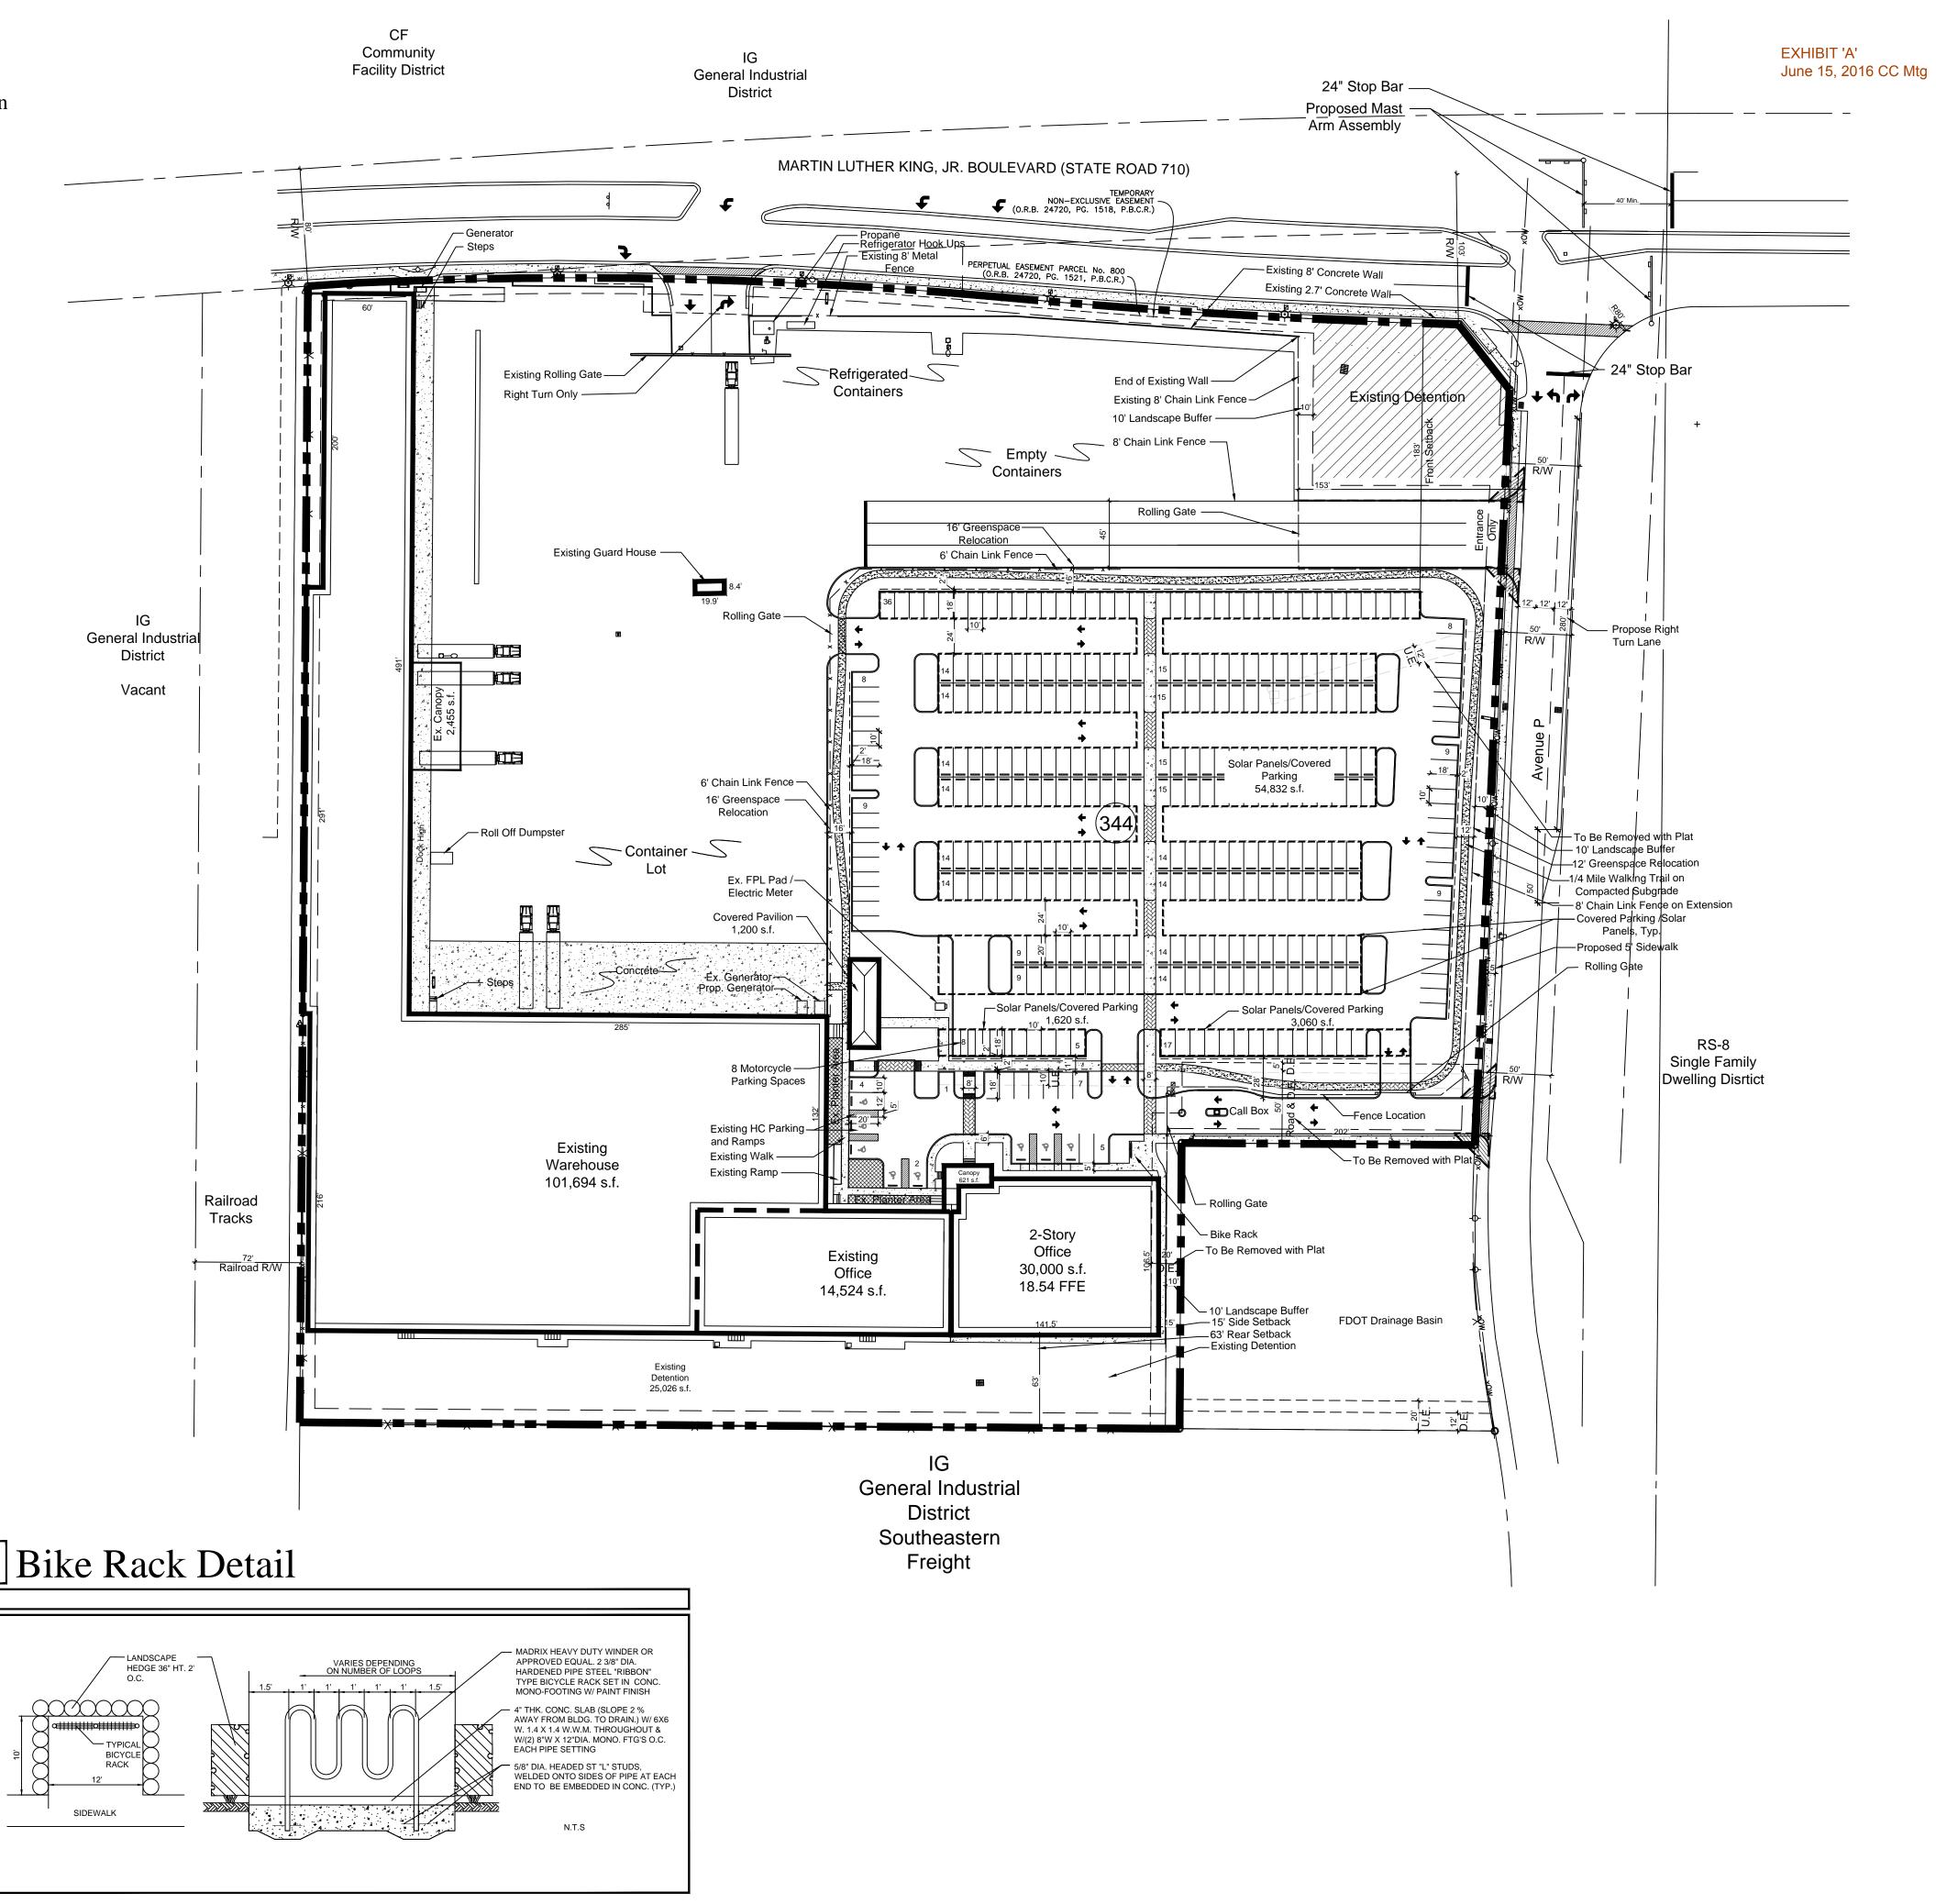

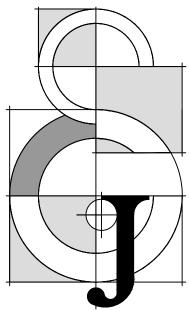

Jon E. Schmidt and Associates Landscape Architecture & Site Planning 2247 Palm Beach Lakes Blvd.- Suite 101 West Palm Beach, Florida 33409 Tel. (561) 684-6141 • Fax. (561) 684-6142 E-mail: Jschmidt@jesla.com Website: www.jesla.com License No.: LC26000232


11	
Date:	05/21/14
Scale:	1" = 60'-0"
Design By:	JES
Drawn By:	BMC
Checked By:	Jes
File No.	688.01
Job No.	14-08


REVISIONS / SUBMISSIONS


07/15/14 Footprint Expansion
09/12/14 Footprint Expansion
09/30/14 Staff Comments
10/03/14 Fencing Revision
11/05/14 Trucks Removed
10/13/15 Ex. FPL Pad
10/13/15 Sidewalk Rev.
10/30/15 Entry Revisions.
03/18/16 SP Amendment
05/1 <u>0/16 Submittal</u>

Phase 2A Site Plan

EXHIBIT 'A'
June 15, 2016 CC Mtg

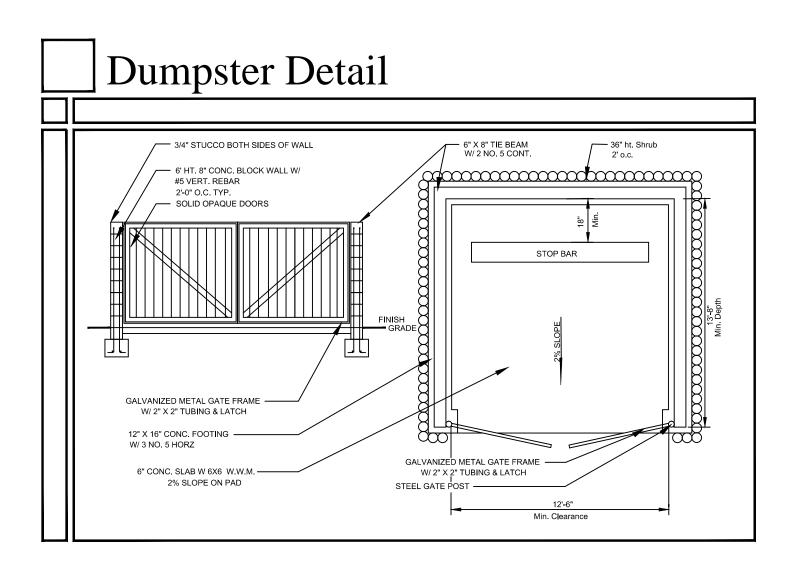

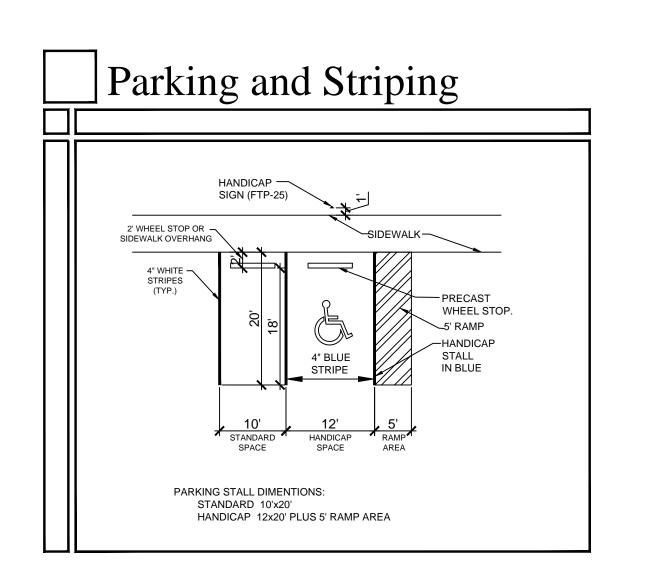

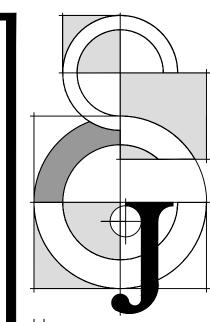

Jon E. Schmidt and Associates
Landscape Architecture & Site Planning
2247 Palm Beach Lakes Blvd.- Suite 101
West Palm Beach, Florida 33409
Tel. (561) 684-6141 • Fax. (561) 684-6142
E-mail: Jschmidt@jesla.com
Website: www.jesla.com
License No.: LC26000232

Tropical Shipping Riviera Facility

Date:	05/21/14
Scale:	NTS
Design By:	JES
Drawn By:	BMC
Checked By:	Jes
File No.	688.01
Job No.	14-08

REVISIONS / SUBMISSIONS


09/30/14 Staff Comments

03/18/16 SP Amendment

05/10/16 Submittal


Phase 2A Regulating Plan

SP-2 of 2

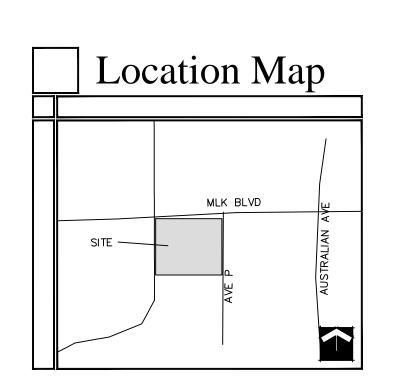



Phase 2A Tropical Shipping

- LI-1 Phase 2A Landscape Index
- LP-1 Phase 2A Foundation Landscape Plan
- LP-2 Phase 2A Parking Lot Landscape Plan
- LP-3 Phase 2A North End Landscape Plan
- LP-4 Upgraded Area Landscape Plan
- LP-5 Landscape Specifications
- LP-6 Tree Disposition Plan

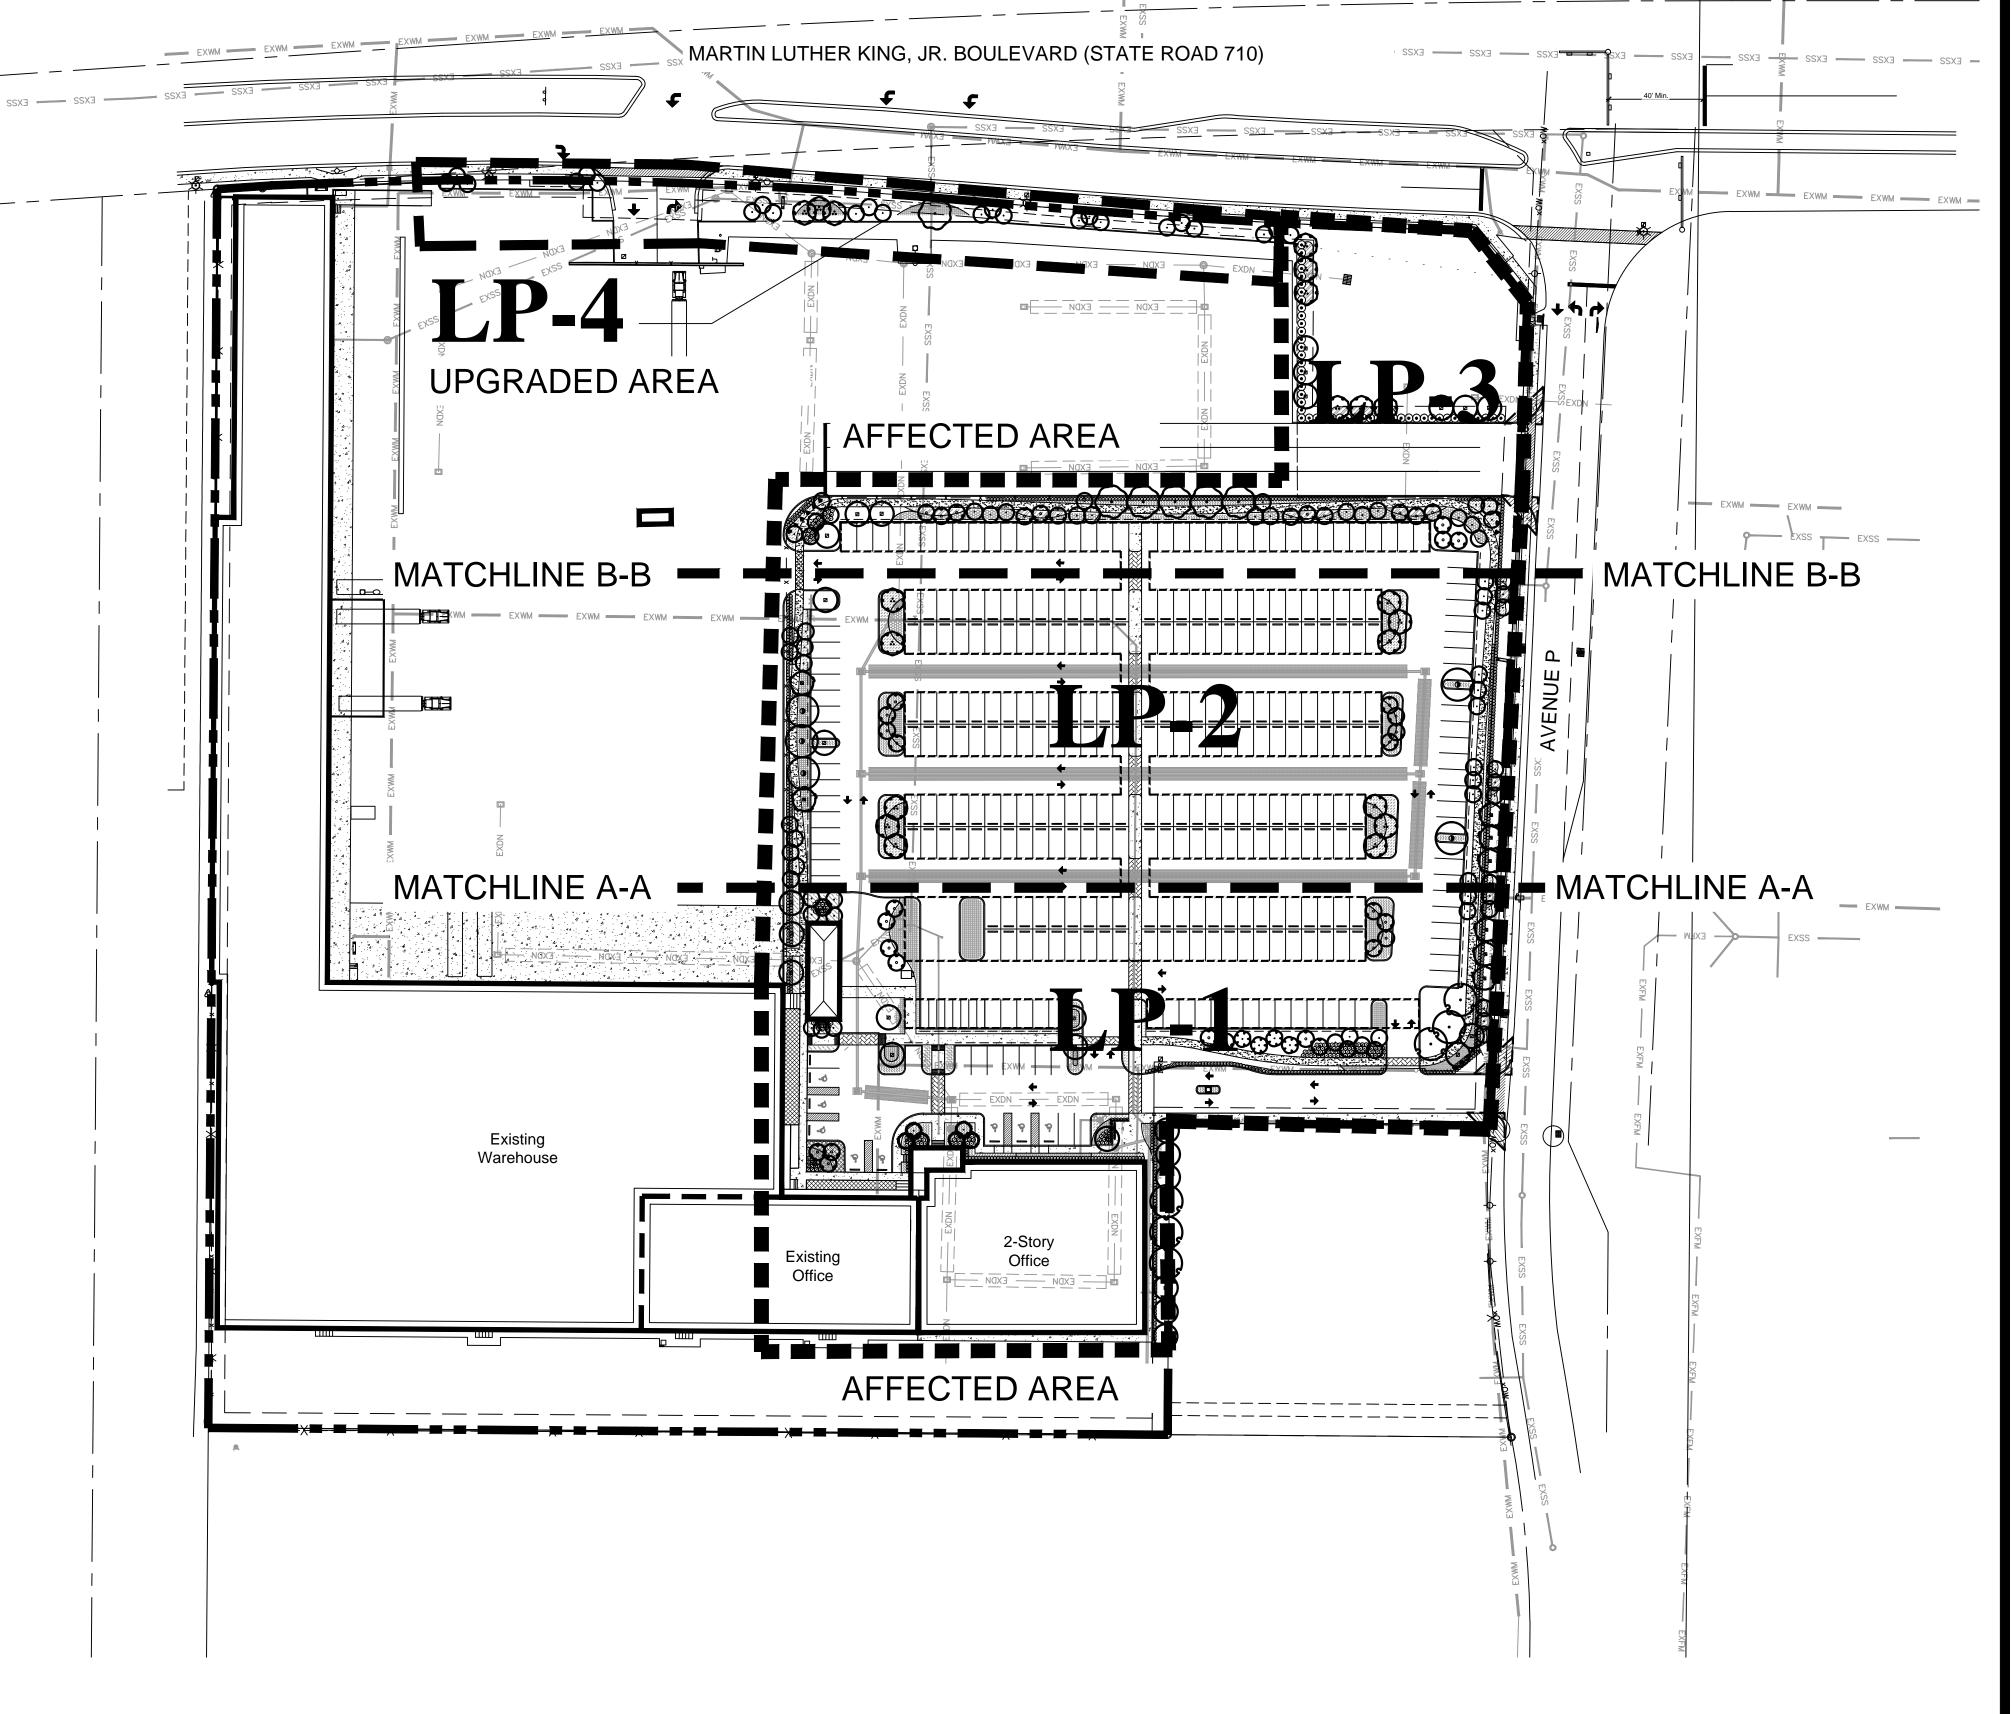



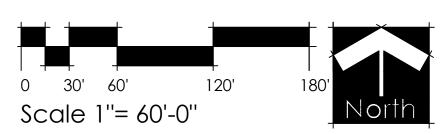

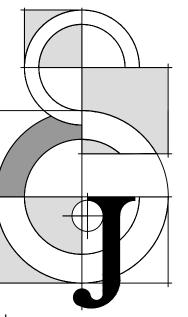

June 15, 2016 CC Mtg

Website: www.jesla.com License No.: LC26000232

5/21/14 1'' = 60'-0'' Design By: Drawn By: Checked By:

REVISIONS / SUBMISSIONS 09/30/14 Staff Comments

10/03/14 Fencing Revision

01/13/15 MYC Spec 10/14/15 FPL Pad/Easment Rev.

03/17/16 Revise per Civil


05/10/16 Submittal


ORIGINAL RAISED SEAL OF A FLORIDA LICENSED LANDSCAPE ARCHITECT.

Printed name

FLORIDA REGISTRATION NO. LA 0001638

Phase 2A Landscape Index

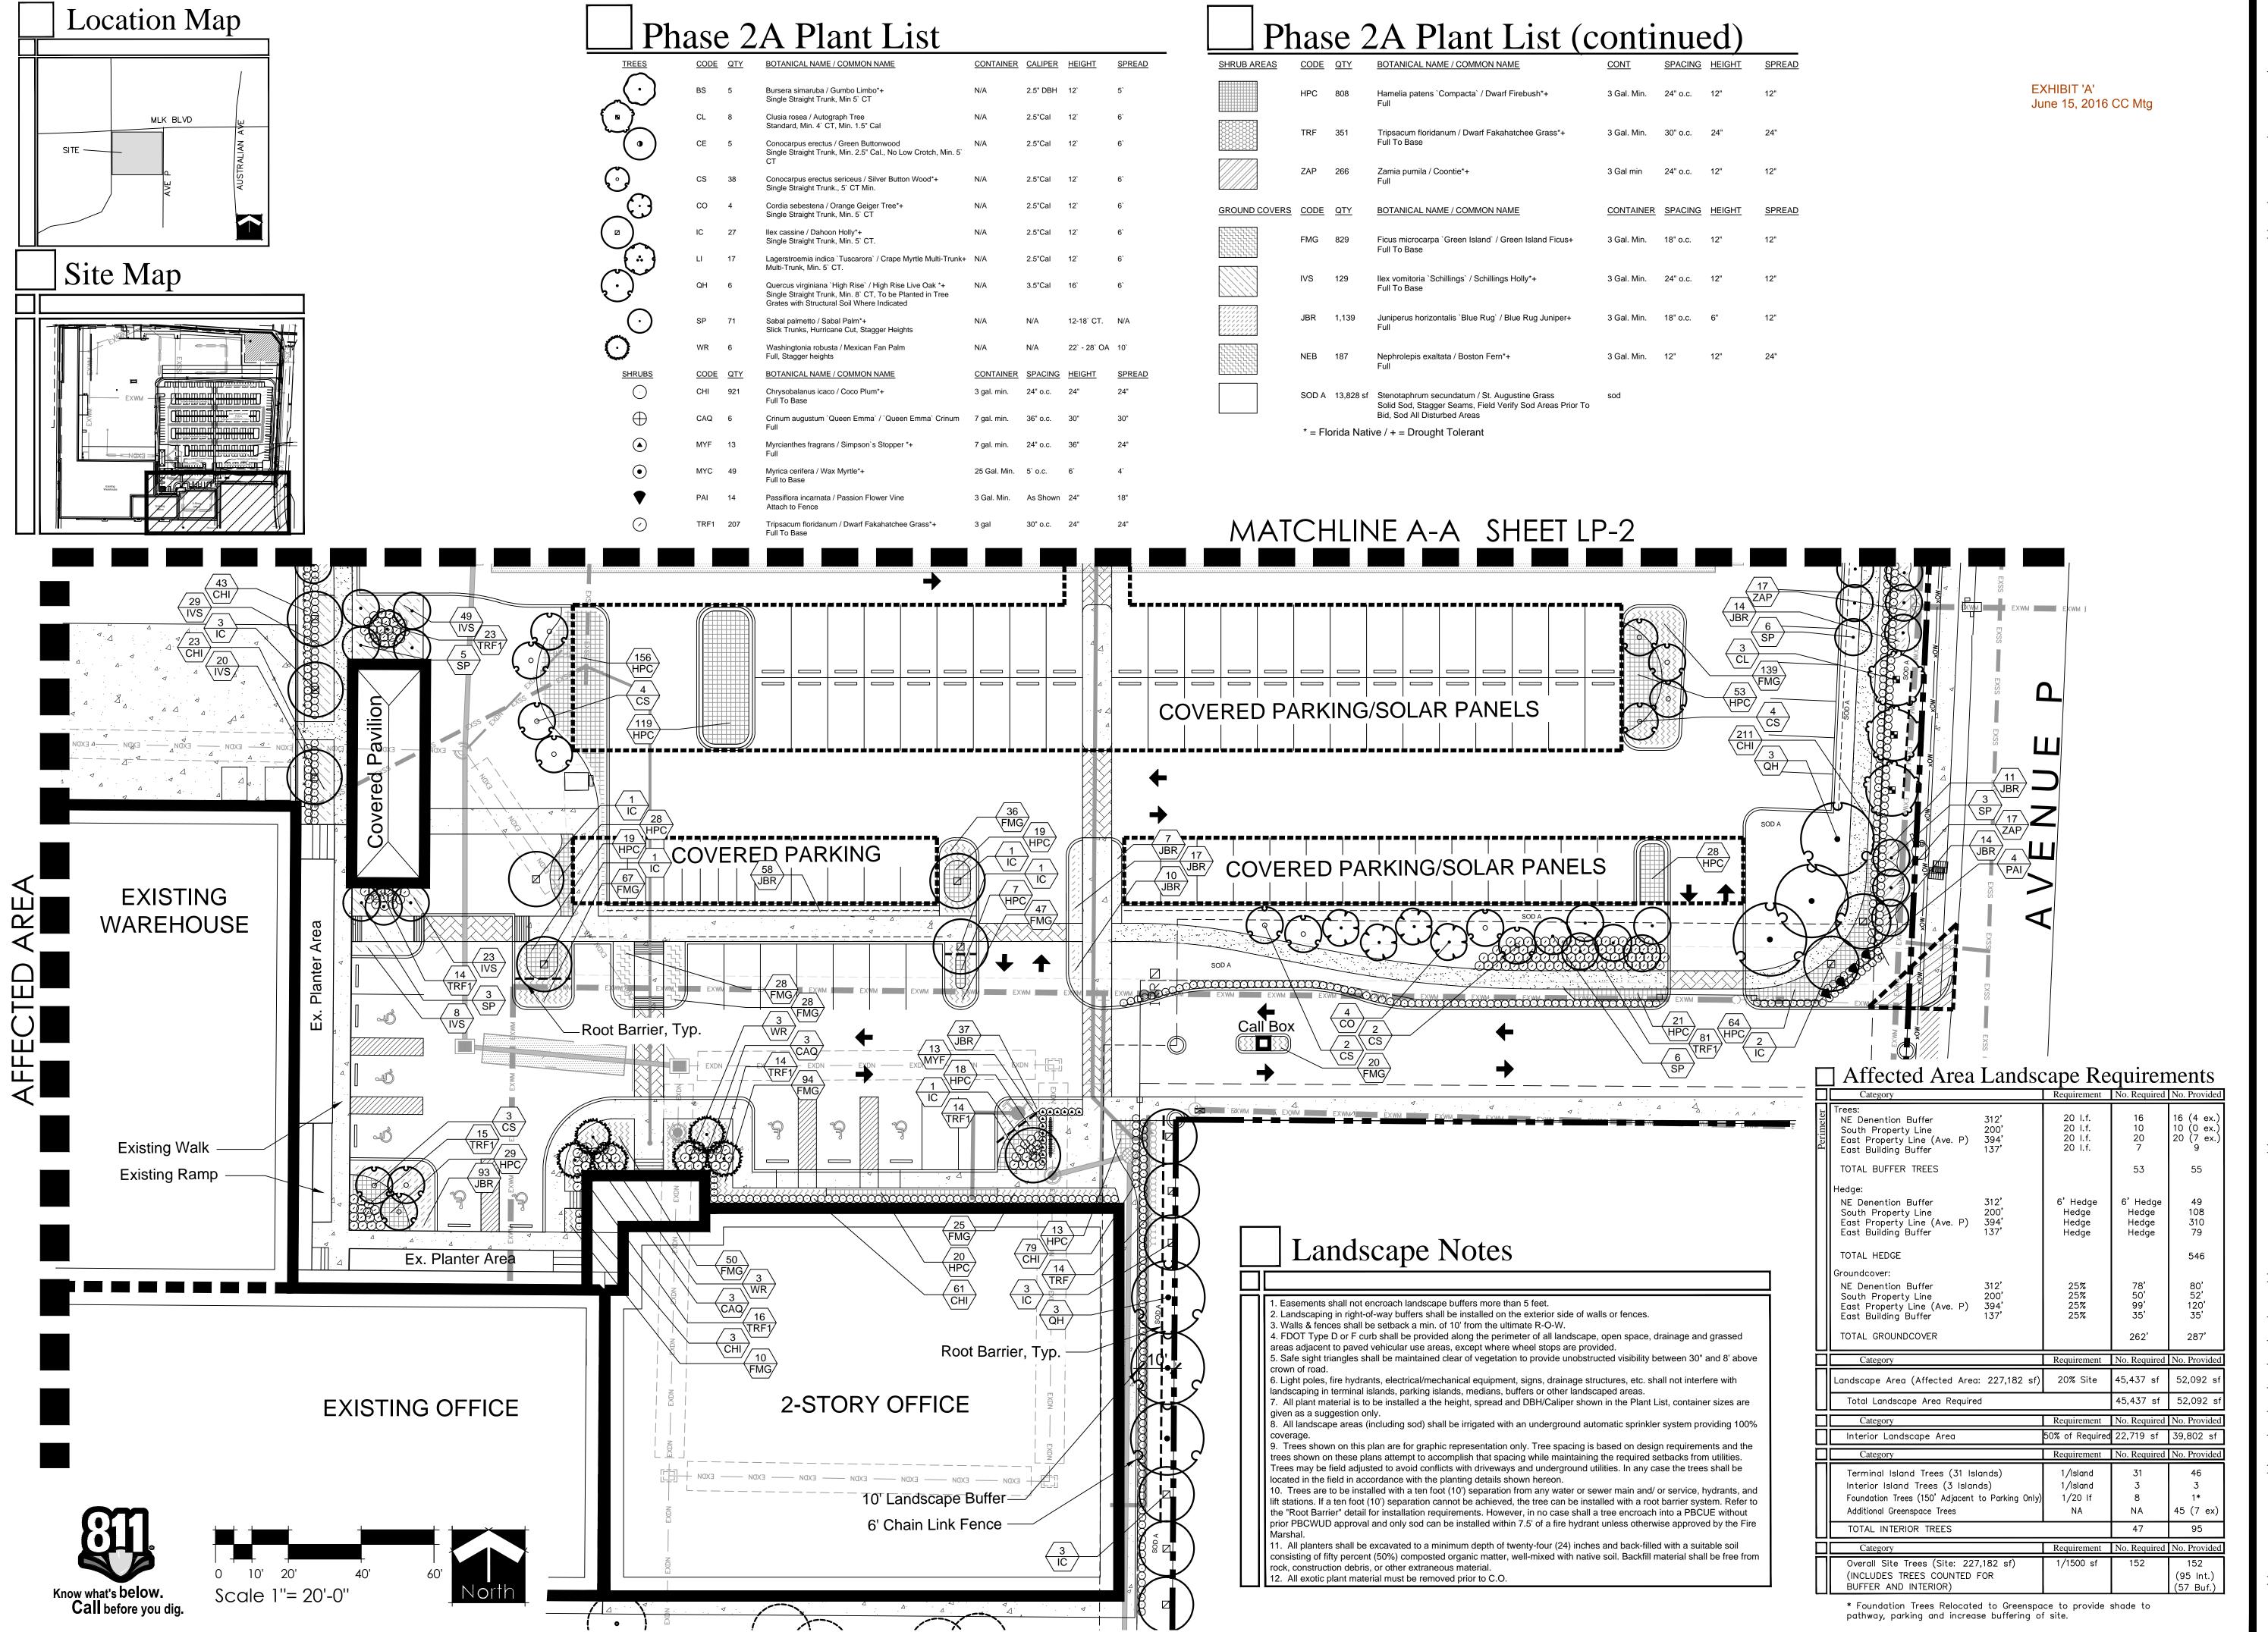

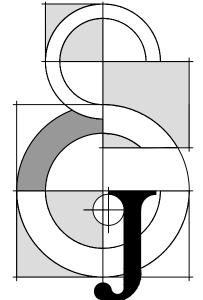


Date:	5/21/14
Scale:	1'' = 20'-0''
Design By:	JES
Drawn By:	BMC
Checked By:	Jes
File No.	688.01
Job No.	14-08

 $^{ extsf{ t}}$ revisions / submissions

703/14 Fencing Revision 713/15 MYC Spec 714/15 FPL Pad/Easment Rev. 710/15 Entry Revisions

Phase 2A Landscape Plan

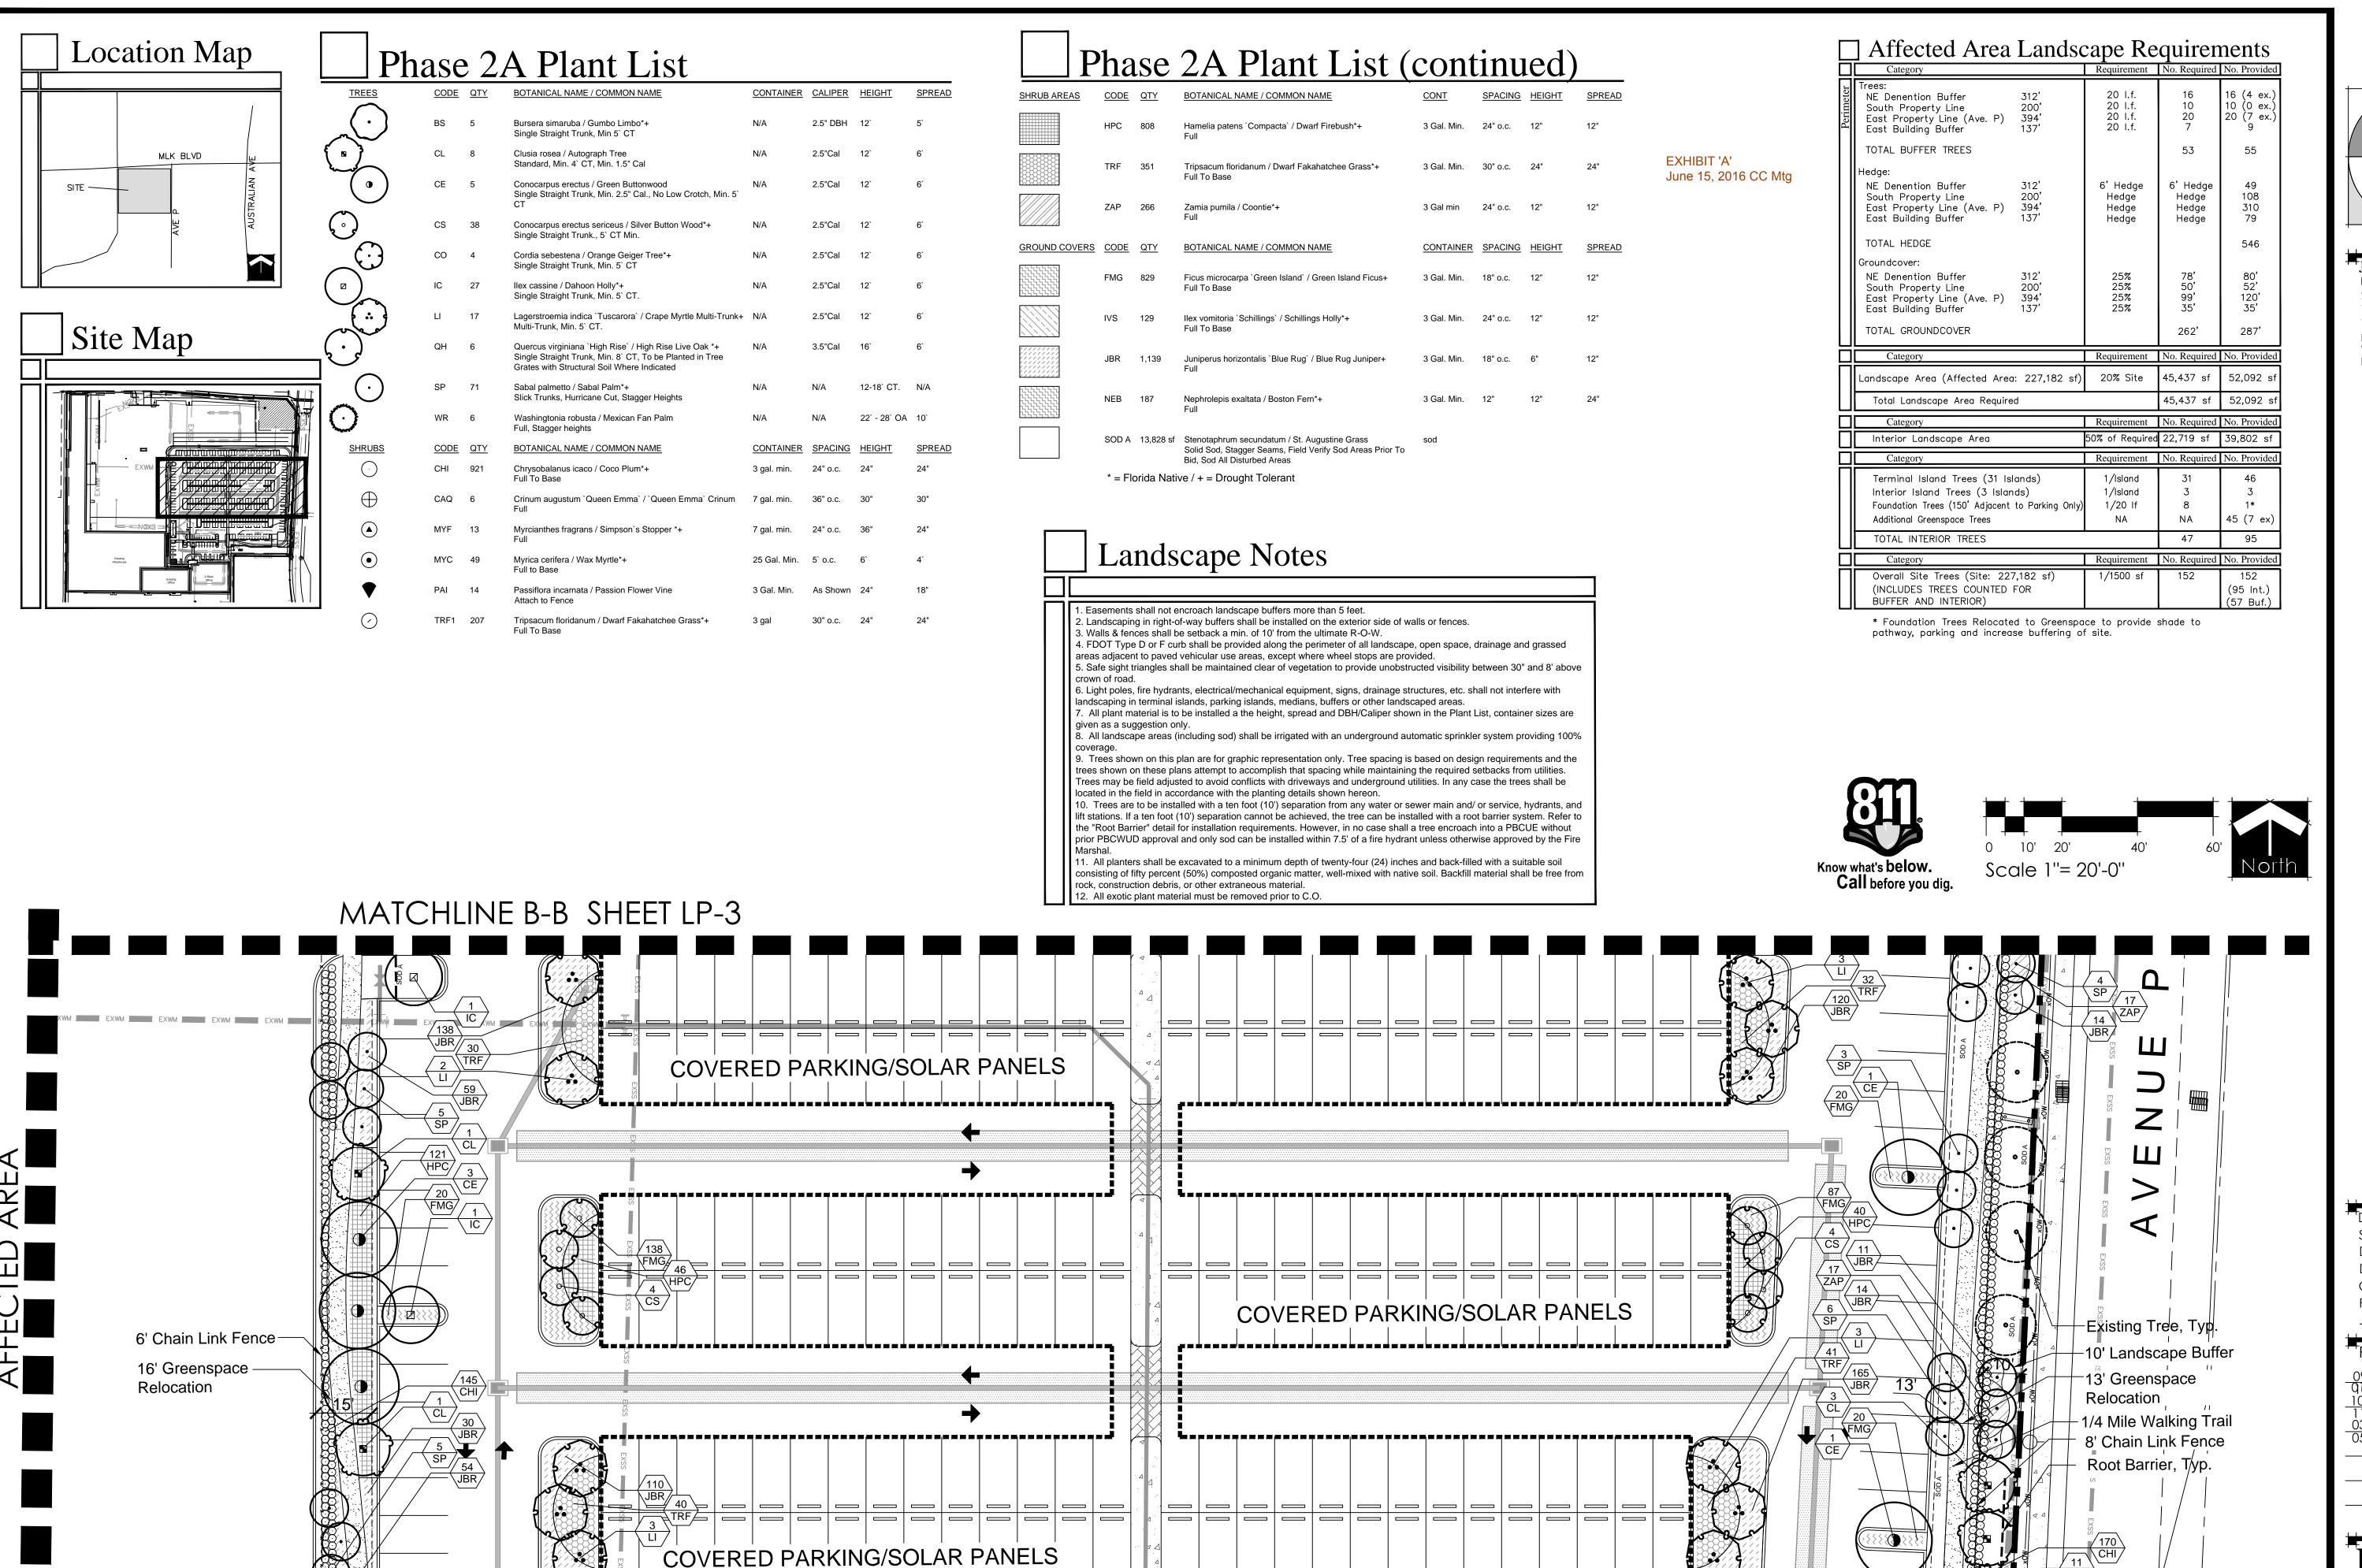

MATCHLINE A-A SHEET LP-1

Jon E. Schmidt and Associates Landscape Architecture & Site Planning 2247 Palm Beach Lakes Blvd.- Suite 101 West Palm Beach, Florida 33409 Tel. (561) 684-6141 • Fax. (561) 684-6142 E-mail: Jschmidt@jesla.com Website: www.jesla.com License No.: LC26000232


Beach,

1.1	
Date:	5/21/14
Scale:	1" = 20'-0"
Design By:	JES
Drawn By:	ВМС
Checked By:	Jes
File No.	688.01
Job No.	14-08

 $^{ extsf{T}}$ revisions / submission

09/30/14 Staff Comments
0 b/03/154 Person Person
10/14/15 FPL Pad/Easment Rev.
11/10/15 Entry Revisions
03/17/16 Revise per Civil
05/10/16 Submittal

Phase 2A Landscape Plan

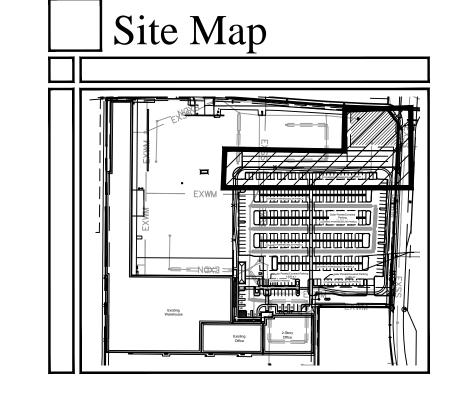

] Affected Area	Landso			
	Category		Requirement	No. Required	No. Provide
Perimeter	Trees: NE Denention Buffer South Property Line East Property Line (Ave. P) East Building Buffer TOTAL BUFFER TREES	312' 200' 394' 137'	20 l.f. 20 l.f. 20 l.f. 20 l.f.	16 10 20 7	16 (4 ex. 10 (0 ex. 20 (7 ex 9
	Hedge: NE Denention Buffer South Property Line East Property Line (Ave. P) East Building Buffer	312' 200' 394' 137'	6' Hedge Hedge Hedge Hedge	6' Hedge Hedge Hedge Hedge	49 108 310 79

TOTAL HEDGE

NE Denention Buffer

TOTAL GROUNDCOVER

South Property Line 200' East Property Line (Ave. P) 394' East Building Buffer 137'

Groundcover:

Affected Area Landscap	e Requ	iireme	nts (cont.)
Category	Requirement	No. Required	No. Provided

-	Category	Requirement	Site 45,437 sf 52,092 s 45,437 sf 52,092 s ement No. Required No. Provide Required 22,719 sf 39,802 sf ement No. Required No. Provide and 31 46 and 3 3 O If 8 1* A NA 45 (7 ex 47 95 ement No. Required No. Provide No. Sequired No. Provide	
	Landscape Area (Affected Area: 227,182 sf)	45,437 sf	52,092 s	
	Total Landscape Area Required		45,437 sf	52,092 s
	Category	Requirement	No. Required	No. Provide
	Interior Landscape Area	50% of Required	22,719 sf	39,802 sf
Landscape A Total Land Category Interior Lo Category Terminal I Interior Isl Foundation Additional C TOTAL INT Category Overall Sit (INCLUDES	Category	Requirement	No. Required	No. Provide
П	Terminal Island Trees (31 Islands)	1/Island	31	46
- 1 1	Interior Island Trees (3 Islands)	1/Island	3	3
	Foundation Trees (150' Adjacent to Parking Only)	1/20 If	8	1*
	Additional Greenspace Trees	NA	NA	45 (7 ex)
Ш	TOTAL INTERIOR TREES		47	95
Category Interior Landsc Category Interior Landsc Category Terminal Island Interior Island Foundation Trees Additional Greens TOTAL INTERIO Category Overall Site Tr. (INCLUDES TRE	Category	Requirement	No. Required	No. Provide
П	Overall Site Trees (Site: 227,182 sf)	1/1500 sf	152	152
	(INCLUDES TREES COUNTED FOR			(95 Int.)
	BUFFER AND INTERIOR)			(57 Buf.)

* Founda	tion T	rees F	Relocated	to	Greens	pac	e to	provide	sho
pathway,	parkin	g and	d increase	bι	ffering	of	site.	•	

Landscape Notes

Easements shall not encroach landscape buffers more than 5 feet. 2. Landscaping in right-of-way buffers shall be installed on the exterior side of walls or fences.

3. Walls & fences shall be setback a min. of 10' from the ultimate R-O-W. 4. FDOT Type D or F curb shall be provided along the perimeter of all landscape, open space, drainage and grassed

EXHIBIT 'A'

June 15, 2016 CC Mtg

areas adjacent to paved vehicular use areas, except where wheel stops are provided. 5. Safe sight triangles shall be maintained clear of vegetation to provide unobstructed visibility between 30" and 8' above crown of road.

6. Light poles, fire hydrants, electrical/mechanical equipment, signs, drainage structures, etc. shall not interfere with landscaping in terminal islands, parking islands, medians, buffers or other landscaped areas. 7. All plant material is to be installed a the height, spread and DBH/Caliper shown in the Plant List, container sizes are

given as a suggestion only. 8. All landscape areas (including sod) shall be irrigated with an underground automatic sprinkler system providing 100% 9. Trees shown on this plan are for graphic representation only. Tree spacing is based on design requirements and the

trees shown on these plans attempt to accomplish that spacing while maintaining the required setbacks from utilities. Trees may be field adjusted to avoid conflicts with driveways and underground utilities. In any case the trees shall be located in the field in accordance with the planting details shown hereon.

10. Trees are to be installed with a ten foot (10') separation from any water or sewer main and/ or service, hydrants, and

lift stations. If a ten foot (10') separation cannot be achieved, the tree can be installed with a root barrier system. Refer to the "Root Barrier" detail for installation requirements. However, in no case shall a tree encroach into a PBCUE without prior PBCWUD approval and only sod can be installed within 7.5' of a fire hydrant unless otherwise approved by the Fire

11. All planters shall be excavated to a minimum depth of twenty-four (24) inches and back-filled with a suitable soil

consisting of fifty percent (50%) composted organic matter, well-mixed with native soil. Backfill material shall be free from

rock, construction debris, or other extraneous material. 12. All exotic plant material must be removed prior to C.O.

Phase 2A Plant List

TREES	CODE	<u>QTY</u>	BOTANICAL NAME / COMMON NAME	CONTAINER	CALIPER	<u>HEIGHT</u>	SPREAD
\odot	BS	5	Bursera simaruba / Gumbo Limbo*+ Single Straight Trunk, Min 5` CT	N/A	2.5" DBH	12`	5`
(s	CL	8	Clusia rosea / Autograph Tree Standard, Min. 4` CT, Min. 1.5" Cal	N/A	2.5"Cal	12`	6`
•	CE	5	Conocarpus erectus / Green Buttonwood Single Straight Trunk, Min. 2.5" Cal., No Low Crotch, Min. 5` CT	N/A	2.5"Cal	12`	6`
	CS	38	Conocarpus erectus sericeus / Silver Button Wood*+ Single Straight Trunk., 5' CT Min.	N/A	2.5"Cal	12`	6`
$\bigcirc \bigcirc$	со	4	Cordia sebestena / Orange Geiger Tree*+ Single Straight Trunk, Min. 5' CT	N/A	2.5"Cal	12`	6`
	IC	27	Ilex cassine / Dahoon Holly*+ Single Straight Trunk, Min. 5` CT.	N/A	2.5"Cal	12`	6`
	LI	17	Lagerstroemia indica `Tuscarora` / Crape Myrtle Multi-Trunk+Multi-Trunk, Min. 5` CT.	N/A	2.5"Cal	12`	6`
	QH	6	Quercus virginiana `High Rise` / High Rise Live Oak *+ Single Straight Trunk, Min. 8` CT, To be Planted in Tree Grates with Structural Soil Where Indicated	N/A	3.5"Cal	16`	6`
\odot	SP	71	Sabal palmetto / Sabal Palm*+ Slick Trunks, Hurricane Cut, Stagger Heights	N/A	N/A	12-18` CT.	N/A
0	WR	6	Washingtonia robusta / Mexican Fan Palm Full, Stagger heights	N/A	N/A	22` - 28` OA	10`
<u>SHRUBS</u>	CODE	<u>QTY</u>	BOTANICAL NAME / COMMON NAME	CONTAINER	SPACING	<u>HEIGHT</u>	SPREAD
\odot	CHI	921	Chrysobalanus icaco / Coco Plum*+ Full To Base	3 gal. min.	24" o.c.	24"	24"
\oplus	CAQ	6	Crinum augustum `Queen Emma` / `Queen Emma` Crinum Full	7 gal. min.	36" o.c.	30"	30"
(A)	MYF	13	Myrcianthes fragrans / Simpson`s Stopper *+ Full	7 gal. min.	24" o.c.	36"	24"
•	MYC	49	Myrica cerifera / Wax Myrtle*+ Full to Base	25 Gal. Min.	5` o.c.	6`	4`
•	PAI	14	Passiflora incarnata / Passion Flower Vine Attach to Fence	3 Gal. Min.	As Shown	24"	18"
\bigcirc	TRF1	207	Tripsacum floridanum / Dwarf Fakahatchee Grass*+ Full To Base	3 gal	30" o.c.	24"	24"


Phase 2A Plant List (continued)

546

120' 35'

287'

SHRUB AREAS	CODE	QTY	BOTANICAL NAME / COMMON NAME	CONT	SPACING	HEIGHT	SPREAD
	HPC	808	Hamelia patens `Compacta` / Dwarf Firebush*+ Full	3 Gal. Min.	24" o.c.	12"	12"
	TRF	351	Tripsacum floridanum / Dwarf Fakahatchee Grass*+ Full To Base	3 Gal. Min.	30" o.c.	24"	24"
	ZAP	266	Zamia pumila / Coontie*+ Full	3 Gal min	24" o.c.	12"	12"
GROUND COVERS	CODE	QTY	BOTANICAL NAME / COMMON NAME	CONTAINER	SPACING	<u>HEIGHT</u>	SPREAD
	FMG	829	Ficus microcarpa `Green Island` / Green Island Ficus+Full To Base	3 Gal. Min.	18" o.c.	12"	12"
	IVS	129	Ilex vomitoria `Schillings` / Schillings Holly*+ Full To Base	3 Gal. Min.	24" o.c.	12"	12"
· · · · · · · · · · · · · · · · · · ·	JBR	1,139	Juniperus horizontalis `Blue Rug` / Blue Rug Juniper+Full	3 Gal. Min.	18" o.c.	6"	12"
	NEB	187	Nephrolepis exaltata / Boston Fern*+ Full	3 Gal. Min.	12"	12"	24"
	SOD A	13,828 sf	Stenotaphrum secundatum / St. Augustine Grass Solid Sod, Stagger Seams, Field Verify Sod Areas Prior To Bid, Sod All Disturbed Areas	sod			
	* = Florida Native / + = Drought Tolerant						

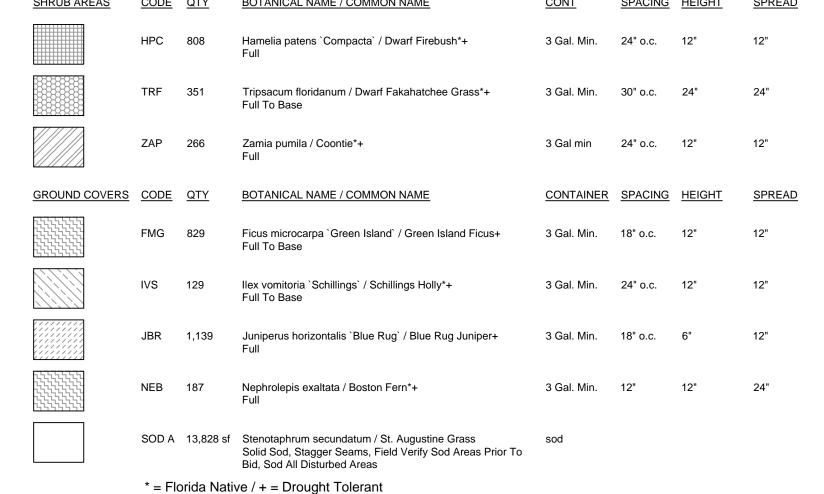


262'

25% 25% 25% 25%


MLK Existing Tree, Typ. Existing 2.7' Wall Selectively Remove End of Existing Wall Existing Landscape to Install Sidewalk Existing 8' Chain Link Fence Extension **Existing Detention** ⁻10' Landscape Buffer

AFFECTED AREA

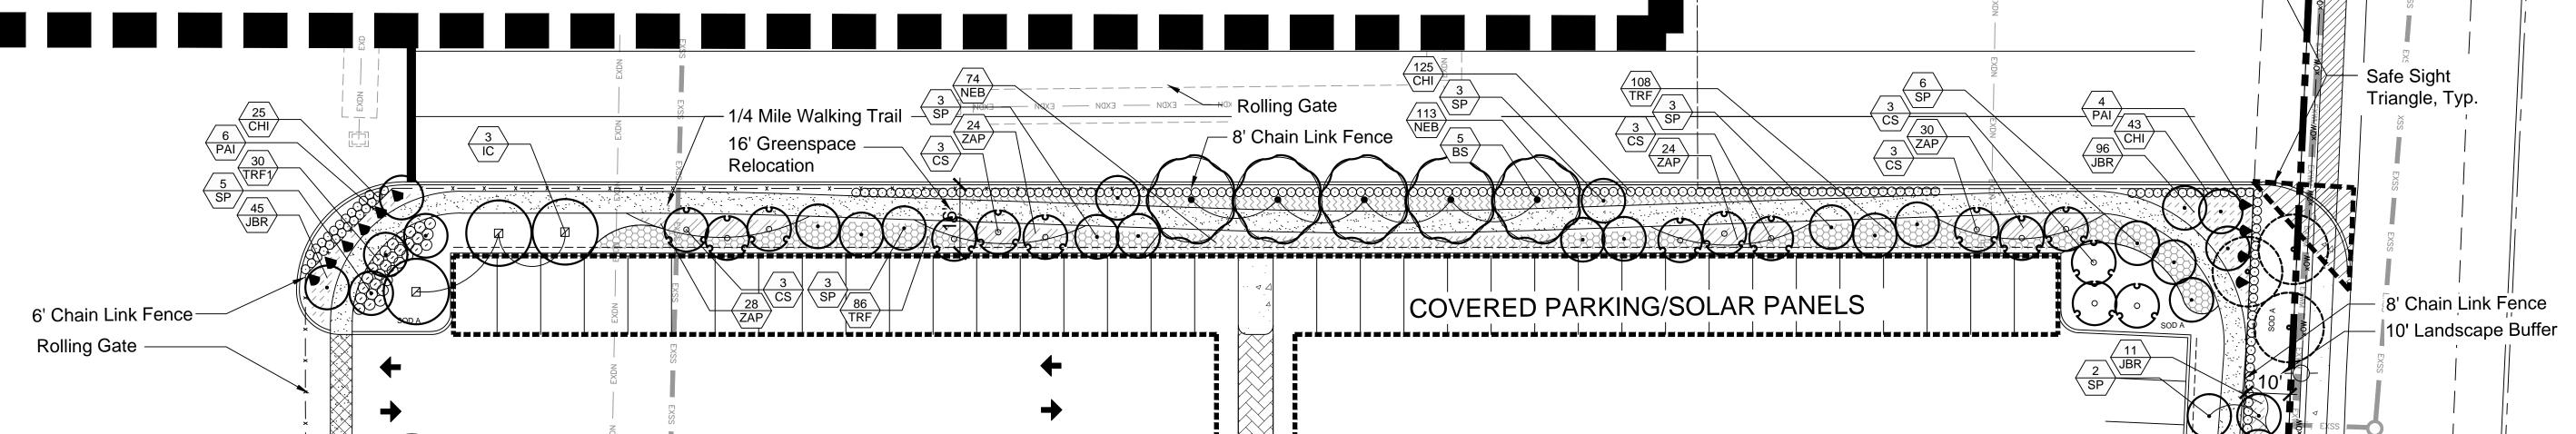

MATCHLINE B-B SHEET LP-2



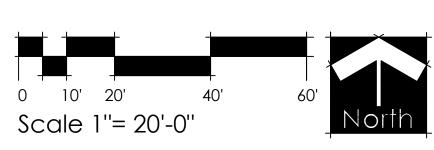

Phase 2A Landscape Plan

Jon E. Schmidt and Associates Landscape Architecture & Site Planning 2247 Palm Beach Lakes Blvd.- Suite 101

West Palm Beach, Florida 33409

E-mail: Jschmidt@jesla.com


Website: www.jesla.com

License No.: LC26000232

Tel. (561) 684-6141 • Fax. (561) 684-6142

5/21/14 1'' = 20'-0'' Scale: Drawn By: Checked By:

14-08

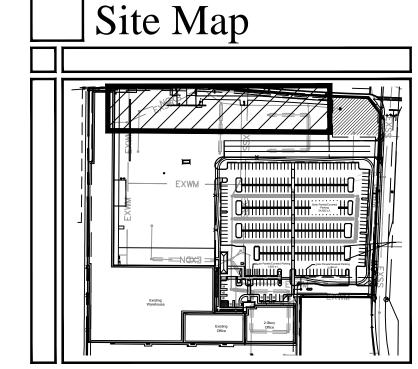

Landscape Notes

- Easements shall not encroach landscape buffers more than 5 feet.
 Landscaping in right-of-way buffers shall be installed on the exterior side of walls or fences.

 Walls 8 for an about the particular of 40 from the ultimate R.O.W.
- Walls & fences shall be setback a min. of 10' from the ultimate R-O-W.
 FDOT Type D or F curb shall be provided along the perimeter of all landscape, open space, drainage and grassed areas adjacent to paved vehicular use areas, except where wheel stops are provided.
- 5. Safe sight triangles shall be maintained clear of vegetation to provide unobstructed visibility between 30" and 8' above crown of road.
 6. Light poles, fire hydrants, electrical/mechanical equipment, signs, drainage structures, etc. shall not interfere with landscaping in terminal islands, parking islands, medians, buffers or other landscaped areas.
- All plant material is to be installed a the height, spread and DBH/Caliper shown in the Plant List, container sizes are given as a suggestion only.
 All landscape areas (including sod) shall be irrigated with an underground automatic sprinkler system providing 100%
- 8. All landscape areas (including sod) shall be irrigated with an underground automatic sprinkler system providing 100% coverage.
 9. Trees shown on this plan are for graphic representation only. Tree spacing is based on design requirements and the trees shown on these plans attempt to accomplish that spacing while maintaining the required setbacks from utilities.

Frees may be field adjusted to avoid conflicts with driveways and underground utilities. In any case the trees shall be

- located in the field in accordance with the planting details shown hereon.

 10. Trees are to be installed with a ten foot (10') separation from any water or sewer main and/ or service, hydrants, and lift stations. If a ten foot (10') separation cannot be achieved, the tree can be installed with a root barrier system. Refer to the "Root Barrier" detail for installation requirements. However, in no case shall a tree encroach into a PBCUE without prior PBCWUD approval and only sod can be installed within 7.5' of a fire hydrant unless otherwise approved by the Fire
- 11. All planters shall be excavated to a minimum depth of twenty-four (24) inches and back-filled with a suitable soil consisting of fifty percent (50%) composted organic matter, well-mixed with native soil. Backfill material shall be free from rock, construction debris, or other extraneous material.

 12. All exotic plant material must be removed prior to C.O.

___ Upgraded Area Plant List

	TREES	CODE	<u>QTY</u>	BOTANICAL NAME / COMMON NAME	CONTAINER	<u>CALIPER</u>	<u>HEIGHT</u>	<u>SPREAD</u>
		BS	1	Bursera simaruba / Gumbo Limbo*+ Single Straight Trunk, Min 5` CT	N/A	2.5" DBH	12`	5`
f	}	LI	3	Lagerstroemia indica `Tuscarora` / Crape Myrtle Multi-Trunk+ Multi-Trunk, Min. 5` CT.	N/A	2.5"Cal	12`	6`
	\odot	SP	24	Sabal palmetto / Sabal Palm*+ Slick Trunks, Hurricane Cut, Stagger Heights	N/A	N/A	12-18` CT.	N/A
	SHRUB AREAS	CODE	<u>QTY</u>	BOTANICAL NAME / COMMON NAME	CONT	SPACING	<u>HEIGHT</u>	SPREAD
		HPC	113	Hamelia patens `Compacta` / Dwarf Firebush*+ Full	3 Gal. Min.	24" o.c.	12"	12"

Affected Area Landscape Requirements

Category Requirement No. Required No. Provided

EXHIBIT 'A'

June 15, 2016 CC Mtg


	Category	Requirement	No. Required	No. Provide
Perimeter	Trees: NE Denention Buffer 312' South Property Line 200' East Property Line (Ave. P) 394' East Building Buffer 137'	20 l.f. 20 l.f. 20 l.f. 20 l.f.	16 10 20 7	16 (4 ex 10 (0 ex 20 (7 ex 9
	TOTAL BUFFER TREES		53	55
	Hedge: NE Denention Buffer 312' South Property Line 200' East Property Line (Ave. P) 394' East Building Buffer 137'	6' Hedge Hedge Hedge Hedge	6' Hedge Hedge Hedge Hedge	49 108 310 79
	TOTAL HEDGE			546
	Groundcover: NE Denention Buffer 312' South Property Line 200' East Property Line (Ave. P) 394' East Building Buffer 137'	25% 25% 25% 25%	78' 50' 99' 35'	80' 52' 120' 35'
	TOTAL GROUNDCOVER		262'	287'
\exists i	Category	Requirement	No. Required	No. Provide
	Landscape Area (Affected Area: 227,182 sf)	20% Site	45,437 sf	52,092
	Total Landscape Area Required		45,437 sf	52,092
	Category	Requirement	No. Required	No. Provide
	Interior Landscape Area	50% of Required	22,719 sf	39,802 s
	Category	Requirement	No. Required	No. Provide
	Terminal Island Trees (31 Islands) Interior Island Trees (3 Islands) Foundation Trees (150' Adjacent to Parking Only) Additional Greenspace Trees	1/Island 1/Island 1/20 If NA	31 3 8 NA	46 3 1* 45 (7 ex
	TOTAL INTERIOR TREES		47	95
	Category	Requirement	No. Required	No. Provide
	Overall Site Trees (Site: 227,182 sf) (INCLUDES TREES COUNTED FOR BUFFER AND INTERIOR)	1/1500 sf	152	152 (95 Int.) (57 Buf.)

* Foundation Trees Relocated to Greenspace to provide shade to pathway, parking and increase buffering of site.


Upgraded Area Notes


• Upgraded area improvements are not included in the affected area landscape requirements, and are additional to the numbers seen in the chart.

UPGRADED AREA

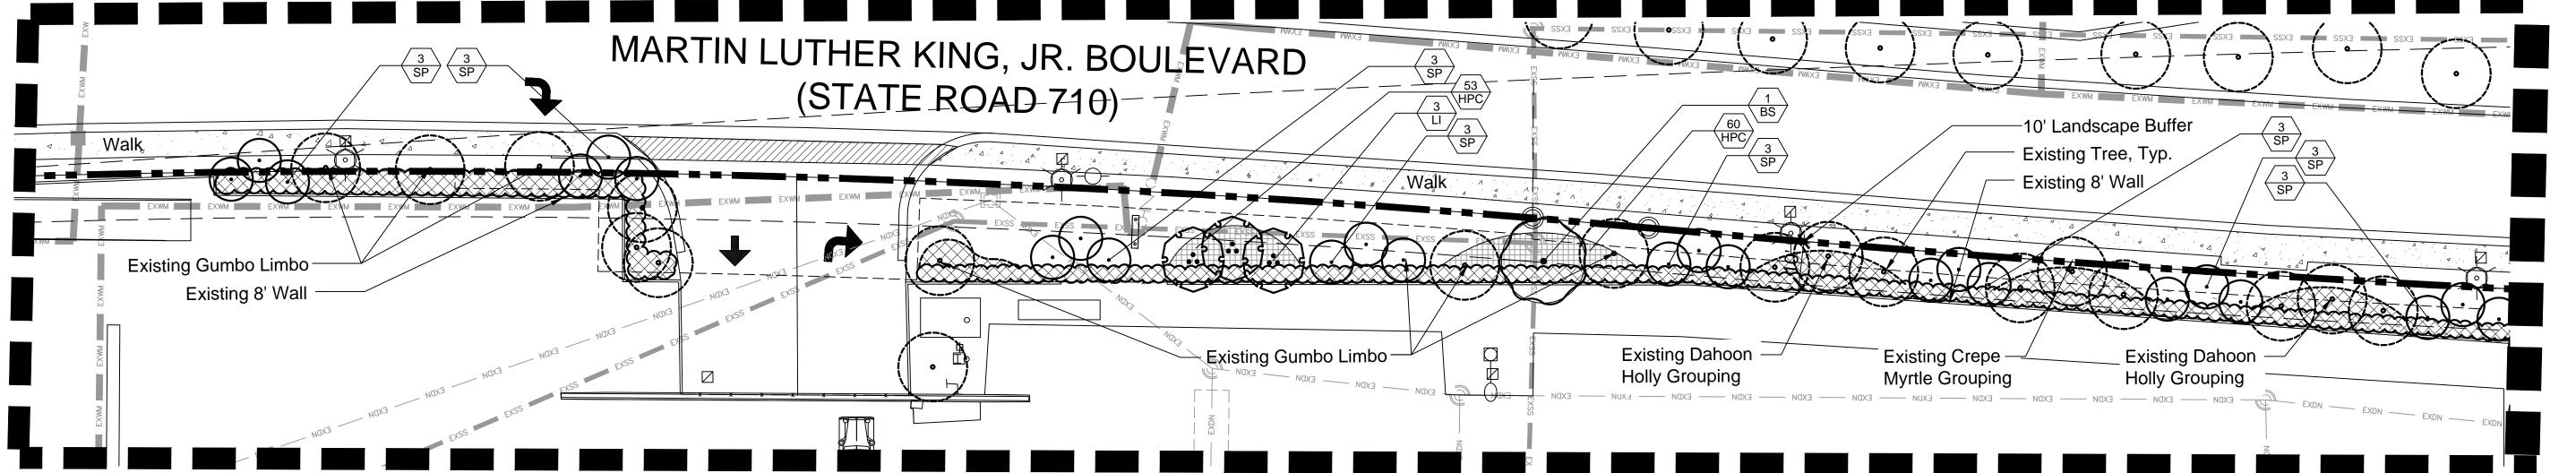

UPGRADED AREA

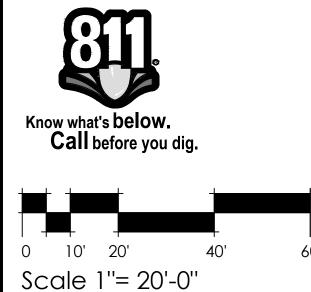

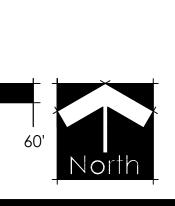

Date: 5/21/14
Scale: 1" = 20'-0"
Design By: JES
Drawn By: BMC
Checked By: Jes

Jon E. Schmidt and Associates
Landscape Architecture & Site Planning
2247 Palm Beach Lakes Blvd.- Suite 101

Tel. (561) 684-6141 • Fax. (561) 684-6142

West Palm Beach, Florida 33409

E-mail: Jschmidt@jesla.com Website: www.jesla.com License No.: LC26000232

REVISIONS / SUBMISSIONS

14-08

10/03/14 Stati Comments 10/03/14 Fencing Revision 01/13/15 MYC Spec 10/14/15 FPL Pad/Easment Re 11/10/15 Entry Revisions

Job No.

10/14/15 FPL Pad/Easment Re 11/10/15 Entry Revisions 03/17/16 Revise per Civil 05/10/16 Submittal

Phase 2A Landscape Plan

LP-4 of 6

- 1.01 WORK INCLUDED
 - Extent of planting work is shown on drawings and in schedules. Subgrade Elevations: Excavation, filling and grading required to establish elevations 4" lower than elevations and contours shown on drawings are not
 - specified in this Section. C. Finish Grade Elevations: 1 inch below top of pathway edging.

1.02 QUALITY ASSURANCE

- A. Subcontract landscape work to a single firm specializing in landscape work. B. Source Quality Control:
 - 1. General: Ship landscape materials with certificates of inspection required by governing authorities. Comply with regulations applicable to landscape materials.
 - 2. Do not make substitutions. If specified landscape material is not obtainable, submit to Landscape Architect proof of non-availability and proposal for use of equivalent material. When authorized, adjustment of contract amount will be made.
 - Analysis and Standards: Package standard products with manufacturer's certified analysis. For other materials, provide analysis by recognized laboratory made in accordance with methods established by the Association of Official Agricultural Chemists, wherever applicable.
 - 4. Trees, Palms and Shrubs: Provide trees, palms and shrubs grown in a recognized nursery in accordance with good horticultural practice. Provide healthy, vigorous stock free of disease, insects, eggs, larvae, and defects such as decay, knots, sun-scald, injuries, abrasions disfigurement. Provide trees, palms and shrubs for grade needed as outlined under Grades and Standards for Nursery Plants, State Plant Board of Florida, unless otherwise noted.
 - a. Sizes: Provide trees and shrubs of sizes shown or specified. Trees, palms and shrubs of larger size may be used if acceptable to Landscape Architect, and if sizes of roots or balls are increased proportionately.
- C. Inspection: Landscape Architect reserves right to inspect trees, palms and shrubs either at place of growth or at site before planting, for compliance with requirements for name, variety, size and quality.

1.03 SUBMITTALS

- A. Certification: Submit certificates of inspections as required by governmental authorities, and manufacturer's or vendor's certified analysis for soil amendments and fertilizer materials. Submit other data substantiating that materials comply with specified requirements
- B. Submit seed vendor's certified statement for each grass seed mixture required, stating botanical and common name, percentage by weight, and percentage of purity, germination, and weed seed for each grass seed species. Planting Schedule:
- Submit planting schedule showing schedule dates for each type of planting in each area of site. Maintenance Instructions:
- Submit typewritten procedures for maintenance of landscape work.

1.04 DELIVERY, STORAGE AND HANDLING

- A. Packaged Materials: Deliver packaged materials in original containers showing weight analysis and name of manufacturer. Protect materials from deterioration during delivery, and while stored at site.
- Sod: Time delivery so that sod will be placed within 24 hours after stripping. Protect sod against drying and breaking of rolled strips. C. Trees, palms and shrubs: Provide freshly dug trees, palms and shrubs. Do not
- prune prior to delivery. Do not bend or bind—tie trees or shrubs in such a manner to damage bark, break branches or destroy natural shape. Provide protective covering during delivery. D. Deliver trees, palms and shrubs after preparations for planting have been
- completed and plant immediately. If planting is delayed more than 6 hours after delivery, set trees and shrubs in shade, protect from weather and mechanical damage, and keep roots moist.
- E. Do not remove container grown stock from containers until planting time

1.05 JOB CONDITIONS A. Proceed with and complete landscape work as rapidly as portions of site become

- B. Utilities: Determine location of underground utilities and perform work in a manner which will avoid possible damage. Hand excavate, as required. Maintain grade stakes set by others until removal is mutually agreed upon by parties
- Excavation: When conditions detrimental to plant growth are encountered, such as rubble fill, adverse drainage conditions, or obstructions, notify Landscape
- Architect before planting. D. Planting Schedule: Where applicable, prepare a proposed planting schedule. Schedule dates to establish a logical sequence for completing each type of landscape work to avoid damage to other landscape work and work performed by other disciplines. Correlate with specified maintenance periods to provide
- only as approved in writing, after documentation of reasons for delay. Coordination with Lawns: Plant trees, palms and shrubs after final grades are established and prior to planting of lawns, unless otherwise acceptable to Landscape Architect. If planting of trees, palms and shrubs occurs after lawn work, protect lawn areas and promptly repair damage to lawns resulting from planting operations.

maintenance from date of substantial completion. Once accepted, revise dates

1.06 SPECIAL PROJECT WARRANTY

- Warrant lawns through specified maintenance period, and until final acceptance. The required period is for one full year following installation of lawn areas. B. Warrant trees for a period of one year after date of substantial completion against defects death and unsatisfactory growth, except for defects resulting from neglect by Owner, abuse or damage by others, or unusual phenomena or
- incidents which are beyond Landscape Contractor's control. Warrant shrubs for 1 full year after date of substantial completion. Remove and replace trees, shrubs or other plants found to be dead or in unhealthy condition during warranty period. Make replacements during growth season following end of warranty period. Replace trees and shrubs which are in doubtful condition at end of warranty period; unless, in opinion of the Landscape Architect, it is advisable to extend warranty period for a full growing season or for
- 1. Another inspection will be conducted at end of extended warranty period, to determine acceptance or rejection. Only one replacement will be required at end of warranty period, except for losses or replacements due to failure to comply with specified requirements.

PART 2 PRODUCTS

- A. If topsoil is not available on site it must be furnished as specified. Throughout all parts of site where finish grades and contour lines differ from existing contour lines, bring to finish grade contours shown on "Grading Plan."
- B. Topsoil shall be friable fertile soil with representative characteristics of area soils. It should be free of heavy clay, silt, stone, extraneous lime, plant roots and other foreign matter greater than 1 1/2" in diameter. It shall not contain noxious plant growth (such as bermuda or nut grass). It shall test in neutral Ph range of 5.0 to 6.75 and contain no toxic substances that can be deemed to impede plant growth. The contractor shall be prepared to have soil lab-tested at his expense by the Landscape Architect. Topsoil shall comply with the following quantative

Organic Matter 3 - 5% Silt 10 - 30% 0.05 to 0.002 MM Sand 25 - 75% 0.2 to 0.05 MM Clay 5 - 25% 0.002 MM and below	COMPONENTS	VOLUME MEASURE	PARTICLE SIZE
5.37 0.002 WWW difd below	Silť	10 - 30%	

2.02 SOIL AMENDMENTS If necessary to bring soil into above specified limits:

and free flowing.

- A. Lime: Natural limestone (Dolomite) containing not less than 85% of total carbonates, ground so that not less than 90% passes a 10-mesh sieve and not
- less than 50% passes a 100-mesh sieve. B. Peat Humus or Peat Moss: Texture, moisture and pH range suitable for intended
- Humus Soil Conditioner: Consisting of yard trimmings and biosolids co-compost. Commercial Fertilizer: Complete fertilizer of neutral character, with 40% - 50% of the total nitrogen in a water insoluble form. It shall be uniform in composition, dry

- 1. For trees, palms and shrubs, provide fertilizer with not less than 6%
- available phosphoric acid, 6% nitrogen and 6% soluble potash. For lawns, provide fertilizer with not less than 6% phosphoric acid, and 6% potassium, and percentage of nitrogen required to provide not less than 1 lb. of actual nitrogen per 1000 square feet of lawn area. Provide nitrogen in a form that will be available to lawn during initial period of

2.03 PLANT MATERIAL

- A. Plant list is part of this specification section. B. Quality: Trees, palms, shrubs and other plants shall conform to the standards for Florida No. 1 or better as given in the latest edition of Grades and Standards for
- Nursery Plants, State Plant Board of Florida. C. Deciduous Trees: Provide trees of height and caliper listed or shown and with branching configuration for No. 1 graded trees in Grades and Standard for Nursery Plants for type and species required. Provide single stem trees except where special forms are shown or listed. Ball condition variable.
- D. Coniferous and Broadleafed Evergreens: Provide evergreens of size shown or listed. Dimensions indicate minimum height and spread. Provide specified quality evergreens with well-balanced form complying with requirements for other size relationships to the primary dimension shown.

2.04 GRASS MATERIALS

A. Grass Seed: Provide fresh, clean, new-crop seed complying with established tolerance for purity and germination. Provide seed of grass species, proportions and minimum percentages of purity, germination, and maximum percentage of weed seed, as specified. Attach a schedule of requirements. B. Sod: Provide strongly rooted sod free of weeds and undesirable native grasses,

2.05 MISCELLANEOUS LANDSCAPE MATERIALS

A. Ground Cover: Provide plants established and well-rooted in removable containers or internal peat pots and with not less than minimum number and length of runners specified.

capable of growth and development when planted.

- B. Anti-Erosion Mulch: Provide clean, dry, mulching hay or straw of coastal bermuda, pangola or bahia grass. Only undeteriorated mulch which can be readily cut into the soil shall be used. Mulch: Melaleuca or equal.
- D. Stakes and Guys: When required provide stakes and deadmen of sound new hardwood, treated softwood, or redwood, free of knot holes and other defects. Provide wire ties and guys of 2—strand, twisted, pliable galvanized iron wire not lighter than 12 ga. with zinc-coated turnbuckles. Provide not less than 1/2" hose, cut to required lengths to protect tree trunks from damage by wires.

PART 3 EXECUTION

3.01 LAYOUT

A. Layout individual trees and shrub locations and areas for multiple plantings. Stake locations and outline areas and secure Landscape Architect's acceptance before start of planting work. Make adjustments as maybe required.

3.02 PREPARATION OF PLANTING SOIL

- A. Before mixing, clean topsoil of roots, plants, sods, stones, clay lumps, and other extraneous materials harmful or toxic to plant growth. B. Mix specified soil amendments and fertilizers with topsoil at rates specified. Delay mixing of fertilizer if planting will not follow placing of planting soil within a few
- C. For planting beds, mix planting soil either prior to planting or apply on surface of topsoil and mix thoroughly before planting.
- Mix lime with dry soil prior to mixing of fertilizer.
- Prevent lime from contacting roots of acid—loving plants. D. Remove all shellrock encountered and backfill with clean sand or sand/soil mix.
- 3.03 PREPARATION FOR PLANTING AREAS (To include Lawn and Planting Bed Areas)

site soil prior to backfilling of the planting holes around the rootballs

A. Spread a layer of 2 to 3 inches of humus soil conditioner over the entire planting area. Planting areas shall include all new sod areas, shrub areas and tree areas. These areas shall be as large as 3 times the diameter of the beds of the plants, except where confined by hardscape features such as paved parking areas, paved walk ways, structures, etc. Overlapping areas shall be considered to be one large planting area for the entire mass. The humus soil conditioner shall then be uniformly disked, tilled or aerified into the existing soil to a depth of 6 to 8 inches with the following exception: no rototilling shall occur closer to the trunks of established plants than one half the distance to the dripline of the existing plant canopy. All plants, including hedges and ground cover shall be planted in individually dug holes

and the material dug from the holes shall then be further mixed with the prepared

3.04 PREPARATION FOR PLANTING LAWNS

- A. Preparation of Unchanged Grades: Where lawns are to be planted in areas that have not been altered or disturbed by excavating, grading, or stripping operations, prepare soil for lawn planting as follows: Till to a depth of not less than 6"; apply soil amendments and initial fertilizers; remove high areas and fill in depressions; till soil to a homogenous mixture of fine texture, free of lumps, clods, stones, roots and other extraneous matter.
 - 1. Prior to preparation of unchanged areas, remove existing grass, vegetation and turf. Dispose of such material outside of Owner's property; do not turn over into soil being prepared for lawns.
- B. Elsewhere: Loosen subgrade of lawn areas to a minimum depth of 4". Remove stones over 1 1/2" in any dimension and sticks, roots, rubbish and other extraneous matter. Limit preparation to areas which will be planted promptly after
- 1. Spread planting soil mixture to minimum depth required to meet lines, grades and elevations shown, after light rolling and natural settlement.
- Place approximately 1/2 of total amount of planting soil required. Work into top of loosened subgrade to create a transition layer and then place remainder of planting soil.
- 3. Allow for sod thickness in areas to be sodded.
- C. Grade lawn areas to smooth, even surface with loose, uniformly fine texture. Roll and rake and remove ridges and fill depressions, as required to meet finish grades. Limit fine grading to areas which can be planted immediately after
- D. Moisten prepared lawn areas before planting if soil is dry. Water thoroughly and allow surface moisture to dry before planting lawns. Do not create a muddy soil
- E. Restore lawn areas to specified condition if eroded or otherwise disturbed after fine grading and prior to planting.

3.05 PREPARATION OF PLANTING BEDS

- A. Loosen subgrade of planting bed areas to a minimum depth of 12" using a cultimulcher or similar equipment Remove stones over 1 1/2" in any dimension, and sticks, stones, rubbish and other extraneous matter. Spread planting soil mixture to minimum depth required to meet lines, grades and elevations shown, after light rolling and natural settlement. Place approximately 1/2 of total amount of planting soil required. Work into top of loosened subgrade to create a transition layer, then place remainder of the planting soil. Add soil amendment.
- Excavation for Tress and Shrubs: Excavate pits, beds and trenched with vertical sides and with bottom of excavation slightly raised at center to provide proper drainage. Loosen hard subsoil in bottom of excavation.
- 1. For balled and burlapped (B & B trees and shrubs), make excavations at least half again as wide as the ball diameter and equal to the ball depth.
- 2. For container grown stocks, excavate as specified for balled and burlapped stock, adjusted to size of container width and depth.
- Dispose of subsoil removed from landscape excavations. Do not mix with planting soil or use as backfill. Fill excavations for trees and shrubs with water and allow to percolate out before planting.

3.06 PLANTING TREES, PALMS AND SHRUBS

- A. Lay out individual trees, palm and shrub locations and areas for multiple plantings where required. Stake locations and outline areas and secure Landscape Architect's acceptance before start of planting work. Make adjustments as may be required.
- B. Set balled and burlapped (B&B) stock on layer of compacted planting soil mixture, plumb and center of pit or trench with top of ball at same elevation as adjacent finished landscape grades. Remove burlap from sides of balls; retain on bottoms. When set, place additional backfill around base and sides of ball, and work each layer to settle backfill and eliminate voids and air pockets. When excavation is approximately 2/3 full, water thoroughly before placing remainder of backfill. Repeat watering until no more is absorbed. Water again after placing final layer

- C. Set container grown stock as specified for balled and burlapped stock, except cut cans on 2 sides with an approved can cutter; remove bottoms of wooden boxes after partial backfilling so as not to damage root balls.
- Dish top of backfill to allow for mulching. Mulch pits, trenches and planting areas. Provide not less than following thickness of mulch and work into top of backfill and finish level with adjacent finish grades: Provide 3" thickness of mulch.
- Guy and stake trees immediately after planting , as indicated.

- All pruning shall be done on the site before planting as directed by Landscape Architect. Pruning shall follow modern horticultural practices (Grades and Standards for Nursery Plants) and shall be done with approved tools designed for the purpose intended. Lopping, topping, or shearing of trees or shrubs will be grounds for rejecting the plants as unsuitable and not meeting requirements. Damaged, scarred, frayed, split, or skinned branches, limbs or roots shall be pruned back to line wood nearest to the next sound outside lateral bud, branch, limb or root. The terminal leader or bud in all trees or shrubs shall be left intact and not removed unless damaged.
- Prune, thin out and shape trees and shrubs. Prune trees to retain required height and spread. Unless otherwise directed by Landscape Architect, do not cut tree leaders, and remove only injured or dead branches from flowering trees, if any. Prune shrubs to retain natural character.

3.08 SODDING NEW LAWNS

- Lay sod within 24 hours from time of stripping. Lay sod to form a solid mass with tightly fitted joints. Butt ends and sides of sod strips; do not overlap. Stagger strips to offset joints in adjacent courses. Work from boards to avoid damage to subgrade or sod. Tamp or roll tightly to ensure contact with subgrade. Work sifted soil into minor cracks between pieces to sod;
- remove excess to avoid smothering of adjacent grass. C. Water sod thoroughly with a fine spray immediately after planting.

3.09 MAINTENANCE

- Begin maintenance immediately after planting.
- Maintain trees, palms, shrubs and other plants until final acceptance but in no case less than following period: 30 days after substantial completion of planting. C. Maintain trees, palms, shrubs and other plants by pruning, cultivating and weeding as required for healthy growth. Restore planting saucers. tighten and repair stake and guy supports and reset trees and shrubs to proper grades or vertical position as required. Restore or replace damaged wrappings. Spray as
- required to keep trees and shrubs free of insects and diseases. Remove and replace excessively pruned or misformed stock resulting from
- Maintain lawns for not less than the period stated below, and longer as required to establish an acceptable lawn.
- Sodded lawns, not less than 30 days after substantial completion. 2. Seeded lawns, not less than 60 days after substantial completion.
- F. Maintain lawns by watering fertilizing, weeding, mowing, trimming, and other operations such as rolling, regrading and replanting as required to establish a
- smooth, acceptable lawn, free of eroded or bare areas. Landscape Contractor is responsible for watering all sod and plant materials from day of installation through final acceptance even if irrigation is not in place, unless
- this responsibility is assumed in writing by another party. H. Landscape Contractor is to maintain the site weed—free untill acceptance by the Owner.

3.10 CLEANUP AND PROTECTION A. During landscape work, keep pavement clean and work area in an orderly

Protect landscape work and materials from damage due to landscape operations, operations by other contractors and trades and trespassers. Maintain protection during installation and maintenance periods. Treat, repair or replace damaged landscape work as directed.

3.11 INSPECTION AND ACCEPTANCE

- A. When landscape work is completed, including maintenance, Landscape Architect will, upon request, make an inspection to determine acceptability. Landscape work may be inspected for acceptance in parts agreeable to Landscape Architect, provided work offered for inspection is complete, including maintenance.
- Seeded lawns will be acceptable provided requirements, including maintenance, have been complied with, and healthy, uniform close stand of specified grass is established, free of weeds, bare spots and surface irregularities (95% coverage required for acceptance).
- Sodded lawns will be acceptable provided requirements, including maintenance, have been complied with, and healthy, well-rooted, even-colored, viable lawn is established, free of weeds, open joints and bare areas (95% coverage required for acceptance). Where inspected landscape work does not comply with requirements, replace rejected work and continue specified maintenance until reinspected by Landscape Architect and found to be acceptable. Remove rejected plants and materials promptly from project site.

- A. An automatic irrigation system providing 100% coverage with 50% overlap
- is to be provided. A rain sensor is required on all Irrigation Systems.
- C. Provide an as built drawing of the irrigation system to the Landscape Architect.

LANDSCAPE AND ROOT BARRIER NOTE:

Trees shown on this plan are for graphic reprsentation only. Tree spacing is based on design requirements and the trees shown on this plans attempt to accomplish that spacing while maintaining the required setbacks from utilities. Trees may be field adjusted to avoid conflicts with driveways and underground utilities. In any case the trees shall be located in the filed in accordance with the planting details shown hereon.

Additionally, trees are to be installed with a ten foot (10') separation from any water or sewer main and/or service, hydrants, and lift stations. If a ten foot (10') separation cannot be achieved, the tree can be installed with a root barrier system. Refer to the "Root Barrier" detail for installation requirements.

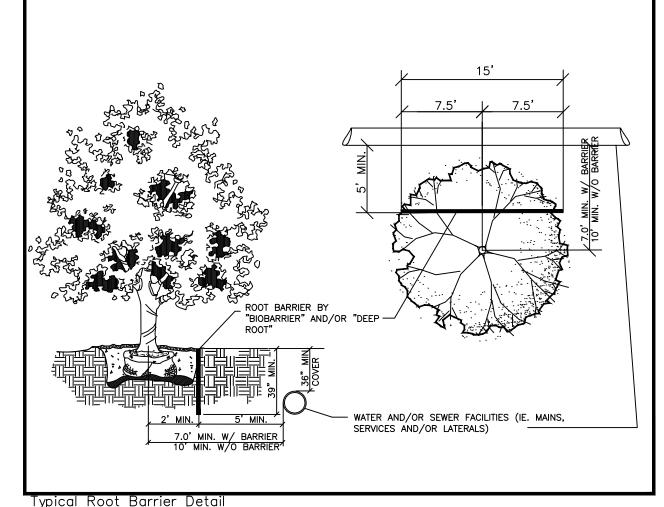


EXHIBIT 'A'

June 15, 2016 CC Mtg


LANDSCAPE NOTES

- 1. All proposed material shall be Florida No. 1 or better as set forth in "Grades & Standards for Nursery Plants," Florida Dept. of Agriculture. 2nd Edition 2/98.
- No deviations will be permitted. 2. By submitting a bid, the landscape contractor is responsible for providing the material specified on the plans. No substitutions will be accepted without prior written approval
- and acceptance by the Owner or his representative, or Landscape Architect.
- Materials to be hand-selected at the discretion of the Owner or his representative, or Landscape Architect. 4. All work shall proceed in a professional manner in accordance with standard
- nursery and installation practices. Quantities on plant list are for convenience only. Landscape Contractor is
- responsible for all plants shown on planting plans. When discrepancies occur between plant list and planting plans, the plans are to override the plant list in all cases. Contractor is responsible for confirming sod quantities and certifying such to the Owner or his representative.
- Contractor is responsible for locating all underground utilities prior to digging. Notify the Owner or his representative, or the Landscape Architect immediately regarding discrepancies or conflicts.
- Landscape Contractor to notify the Owner or his representative, or Landscape
- Architect at least three (3) working days prior to beginning any stage of work. Owner or Landscape Architect to be immediately notified of any discrepancies
- 9. The Owner or his representative, or Landscape Architect reserve the right to field adjust plant material on-site to avoid conflicts or discrepancies not anticipated in the planning process.
- 10. Existing plant material to be removed, except as noted.
- TREES & PALMS All trees, new and relocated, to be staked and guyed as detailed. No double or multi-trunk trees unless otherwise specified.
- Face of trees and palms to be located a minimum of 2'-0" off all sidewalks/bike paths or other paved surfaces, unless otherwise notated on plans.
- Root suckers on Live Oaks are not acceptable. All trees falling within grassed areas to have a 3" mulch ring with no more tḥan 1" of mulcḥ ḍirectly adgacent to the trunk of the tree. Min. 3' radius mulch
- PLANTING BEDS
- Groundcover and shrubs to be layed out in a uniform and consistent pattern. All planting beds to receive 3" deep shredded mulch per specifications.
- Landscape Contractor is responsible for verifying that clean top soil, meeting the attached specifications, exists in each planting bed prior to planting. Contractor shall add or amend top soil if necessary. Tree pits shall be backfilled as noted in attached specifications. Excavate all shrub and groundcover beds as specified and backfill with planting soil per specifications.
- All existing asphalt base material to be removed from planting areas and replaced with clean top soil prior to planting. Final grade within planting areas to be 2" below adjacent paved areas or top of curb.
- Landscape Contractor is responsible for replacing any damaged sod.


All sod areas to receive a 3" top dressing of soil per specifications.

1. All landscape areas (including sod) shall be irrigated with an underground automatic sprinkler system providing 100% coverage, and a rain sensor per attached plans. No landscape installation shall occur until the irrigation system is operational, unless approval is granted by Owner or his representative, or Landscape Architect.

DFTAILS

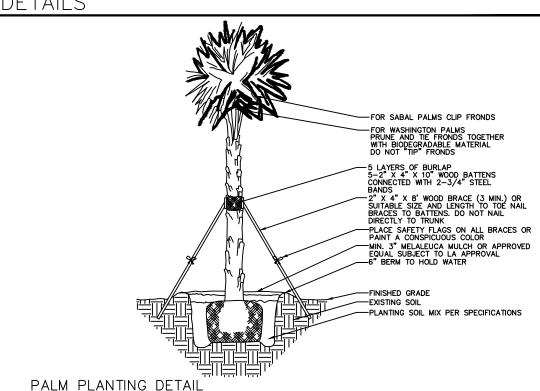

-THIN BRANCHES AND FOLIAGE AS DIRECTED BY LANDSCAPE ARCHITECT. NEVER CUT TERMINAL LEADER

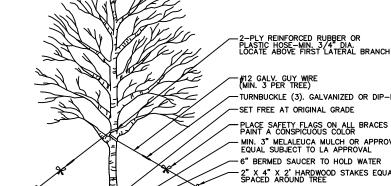


TURNBUCKLE (3). GALVANIZED OR DIP-PAINTED SET FREE AT ORIGINAL GRADE PLACE SAFETY FLAGS ON ALL BRACES OR PAINT A CONSPICUOUS COLOR MIN. 3" MELALEUCA MULCH OR APPROVED EQUAL SUBJECT TO LA APPROVAL ── 6" BERMED SAUCER TO HOLD WATER - 2" X 4" X 2' HARDWOOD STAKES EQUALLY
SPACED AROUND TREE

- REMOVE BURLAP FROM TOP 1/3 OF ROOT BALL

NOTES:
1. DO NOT ALLOW AIR POCKETS TO FORM WHEN BACK FILLING
2. LEAVE 10" OF STAKE ABOVE GRADE FOR REMOVAL

LARGE TREE (OVER 8' HT.) PLANTING DETAIL

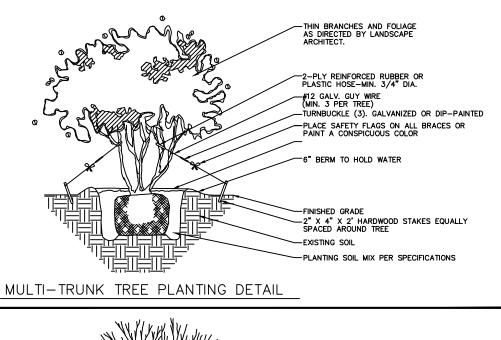

- MIN. 3" MELALEUCA MULCH OR APPROVED EQUAL SUBJECT TO LA APPROVAL - PLANT SO THAT ROOTBALL IS LEVEL WITH FINISHED GRADE - FINISH GRADE EXCAVATE SHRUB AND GROUND COVER
BEDS TO 24" DEPTH AND BACK FILL
WITH PLANTING SOIL.
SEE SPECIFICATIONS FOR PLANTING SOIL MIX.

HRUB AND GROUND COVER DETAIL

Jon E. Schmidt and Associates Landscape Architecture & Site Planning 2247 Palm Beach Lakes Blvd.- Suite 101 West Palm Beach, Florida 33409 Tel. (561) 684-6141 • Fax. (561) 684-6142 E-mail: Jschmidt@jesla.com Website: www.jesla.com License No.: LC26000232

ach

5/21/14 'Date: 1" = 20'-0" Scale: JES Design By: BMCDrawn By: Checked By: 688.01 File No. 14-08 Job No.


TREVISIONS / SUBMISSIONS


7/16 Revise per Civil

09/30/14 Staff Comments 0/03/14 Fencing Revision /13/15 MYC Spec /14/15 FPL Pad/Easment Rev. /10/15 Entry Revisions

Phase 2A

Specs

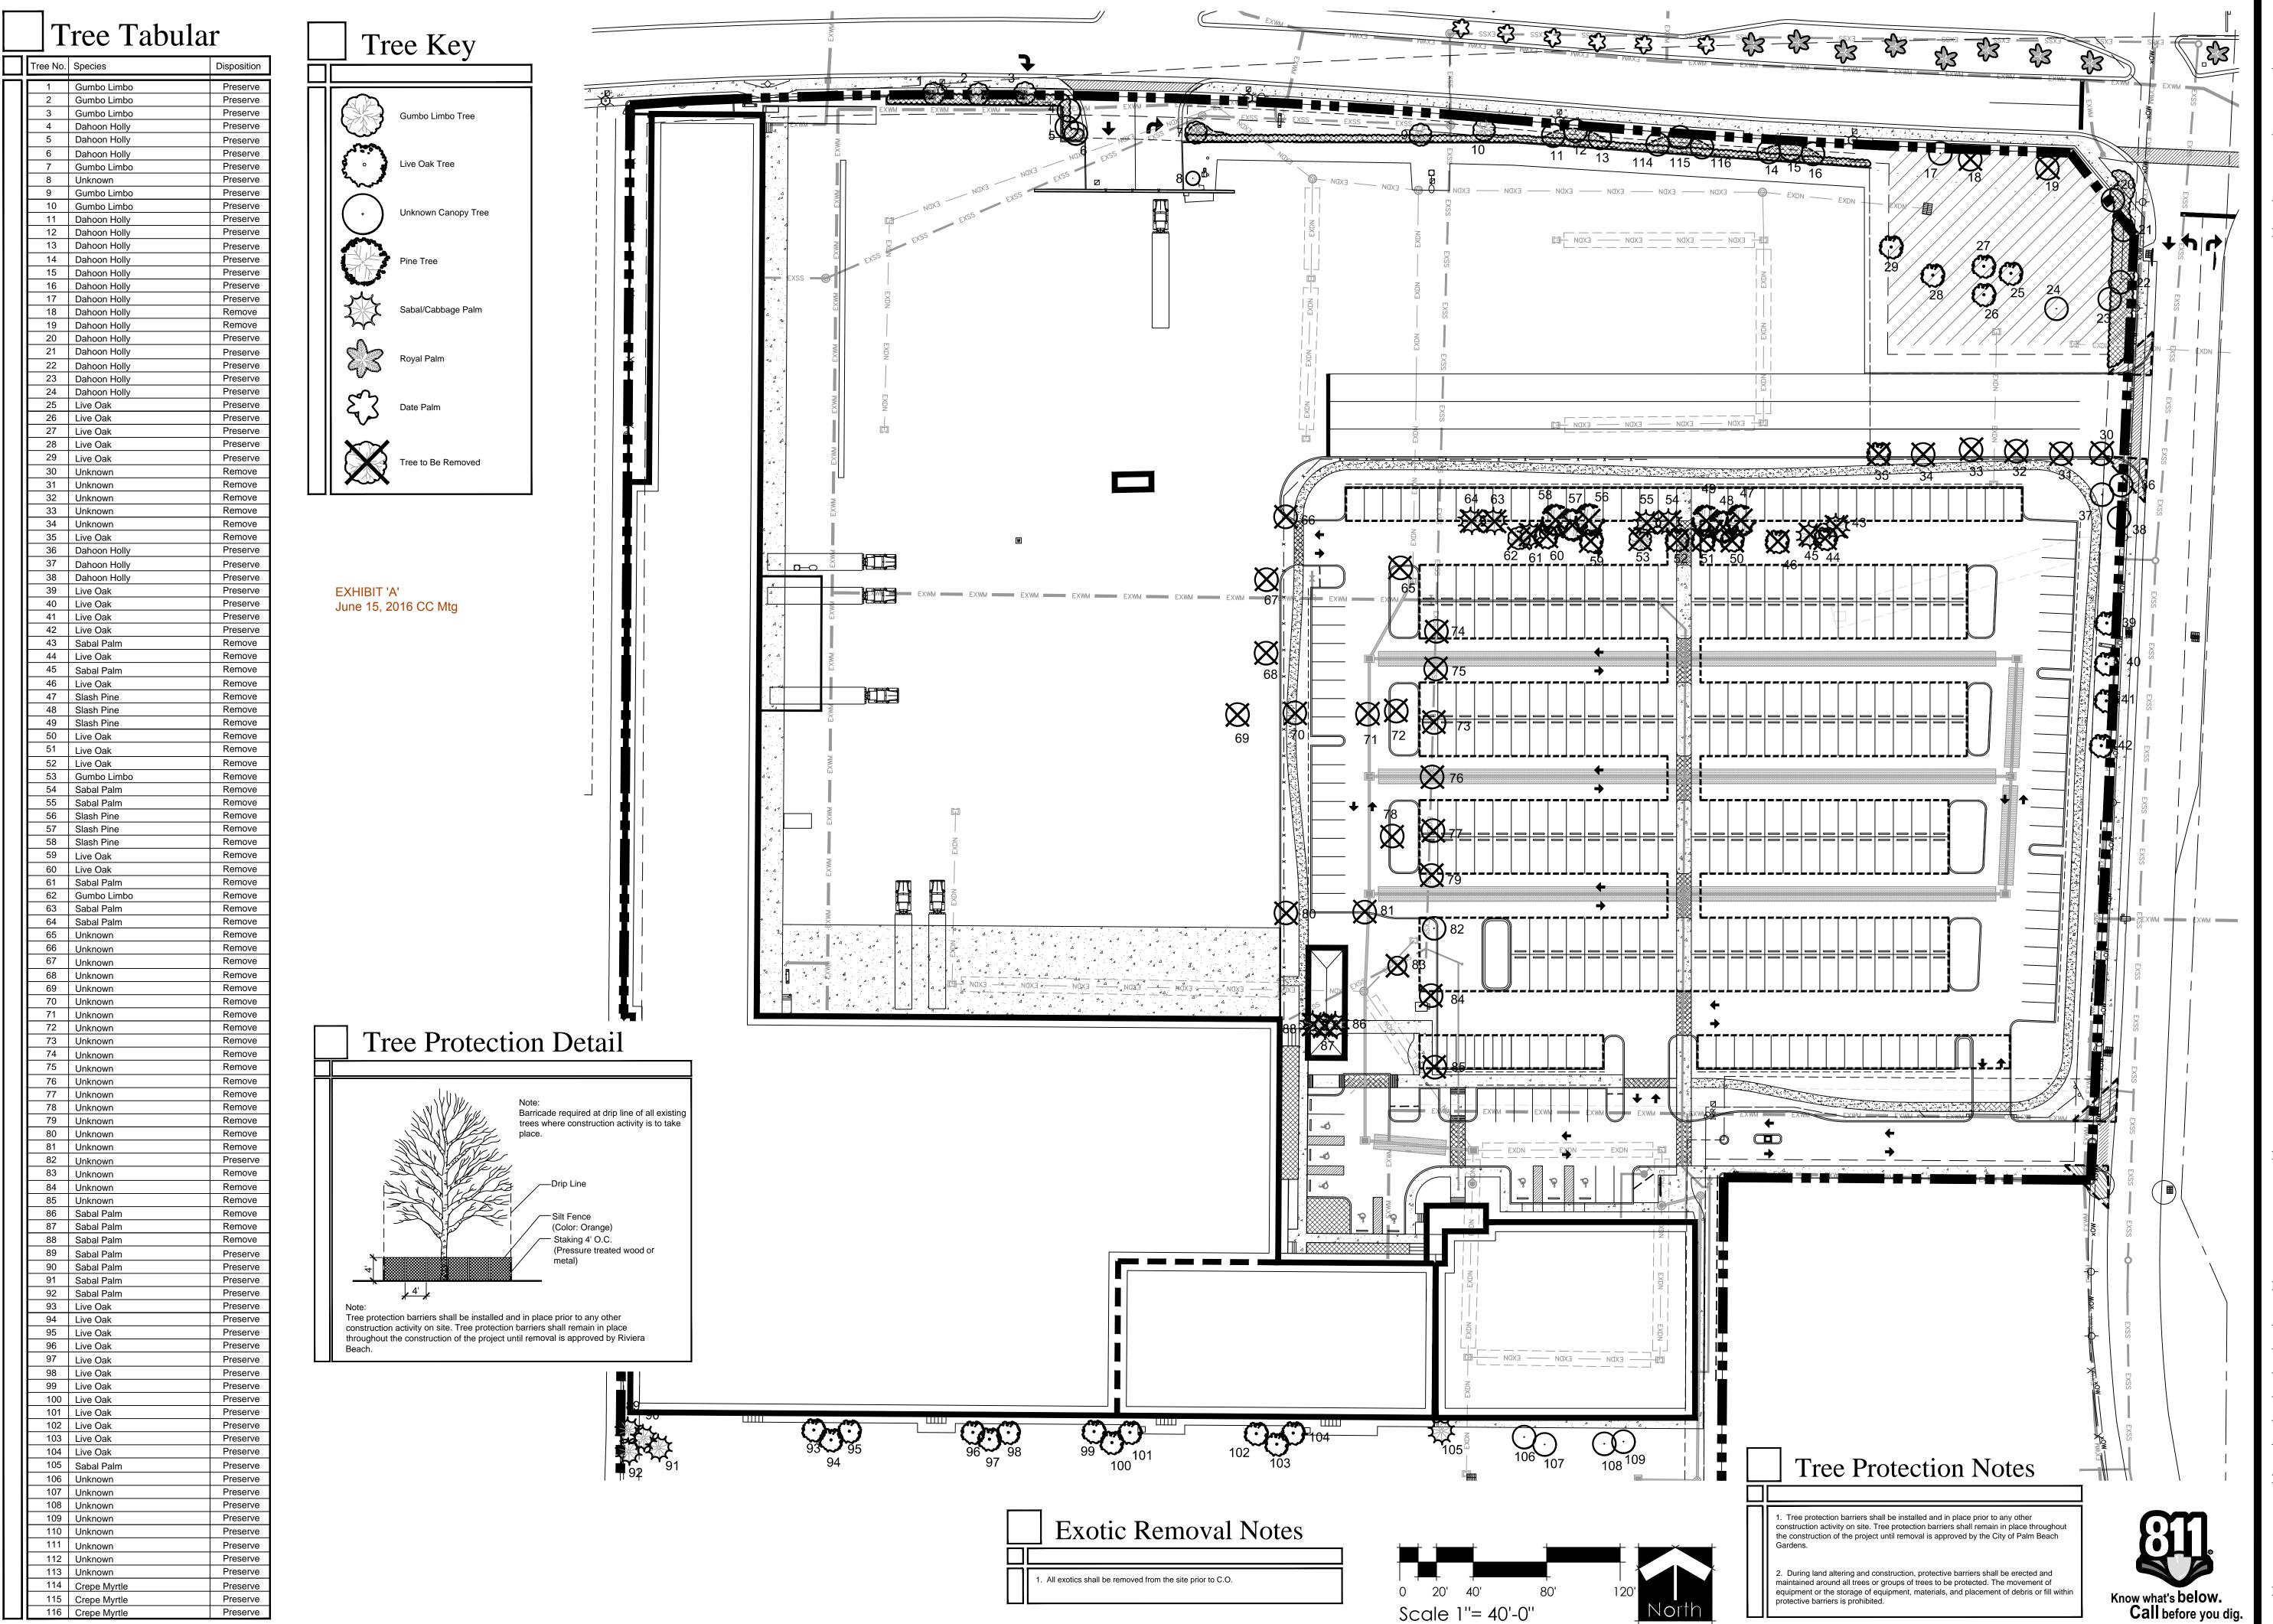

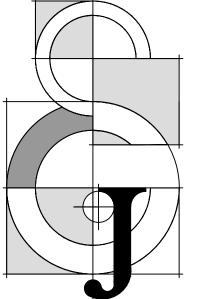

Tropical Shipping Riviera Facility

Date:	09/26/14
Scale:	1'' = 40'-0''
Design By:	JES
Drawn By:	BMC
Checked By:	Jes
File No.	688.01
Job No.	14-08

REVISIONS / SUBMISSIONS

10/03/14 Fencing Revision
10/14/15 FPL Pad/Easment Rev.

11/10/15 Entry Revisions


O/ 10 EITH Y ICC VISIONS

03/17/16 Revise per Civil

05/10/16 Submittal

Tree Disposition Plan

LP-6 of 6

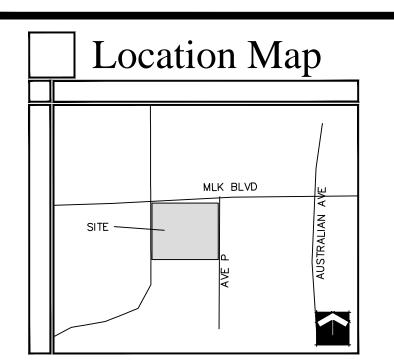

Parking Greenspace Relocation	on
-------------------------------	----

	Farking Greenspace	Kelocau
	Description	Area
COUL	6' Divider medians between parking aisles	8,590 s.f.
	Varied width greenspace pushed to outside of parking area	14,214 s.f.

Site Data

Application Number Name of Project Proposed Use Future Land Use Designat Tier Zoning District Section, Township, Range Property Control Numbers	56-4 56-4	TBD Tropical Shipping Office and Warehouse IND Urban/Suburban IG 32/42/43 3-42-32-35-000-0020 13-42-32-38-000-0040 13-42-32-38-000-0030
Traffic Analysis Zone	(47.7004
Total Site Area Total Gross Floor Area Proposed Office Existing Office Existing Warehouse	(582,327 s.f.) 30,000 s.f. 14,524 s.f. 101,694 s.f.	13.3684 acres 146,218 s.f
Total Floor Area Ratio Total Building Coverage (Including canopies o	f) 4,276 s.f.	25% 23%
Impervious Area Buildings Pavement/Walks	135,661 s.f. 347,364 s.f.	83%
Pervious Area	99,302 s.f.	17%
Building Height Number of Stories		max. 50' 2
Parking Required Ex. Office— 1 Space/ Prop. Office— 1 Spac Ex. Warehouse—1 Spa	e/300 s.f. @ 30,00	00 s.f. = 100
Proposed Parking General Parking= 31		321 SPACES
Motorcycle Parking= Handicap Spaces Required Handicap Spaces Proposed Loading Required (15' x 5 Loading Provided	l d	8 8 3 Loading Yard 3+

Development Regulations


		IG PROPERTY DEVELOPMENT REQUIREMENTS										
	ZONING DISTRICT	MINIMU SIZE	M LOT DIME WIDTH	NSIONS DEPTH	MAX. FAR	MINIMUM PERV. AREA	MAX. BLDG. COVER	MAX. BLDG. HEIGHT	FRONT	SETBACKS/S SIDE INTERIOR	EPARATIONS SIDE CORNER	REAR
CODE	IG	1.0 AC.			N/A	N/A	45%	50'	40'	15'	N/A	20'
PROP.	IG	13.37 AC.			N/A	N/A	23%	40'	632'	15'	N/A	63'


Notes

OBASE INFORMATION FOR THIS PROJECT WAS OBTAINED FROM A BOUNDARY SURVEY PREPARED BY CALVIN, GIORDANO & ASSOCIATES, INC. DATED 4/22/14

Development Team

1	
OWNER:	TROPICAL SHIPPING USA LLC 5 EAST 11TH STREET RIVIERA BEACH, FLORIDA 33404 (561) 881–3900
SURVEYOR:	CALVIN GIORDANO & ASSOCIATES 560 VILLAGE BLVD. SUITE 340 WEST PALM BEACH, FL 33409 (561) 684-6161
CIVIL ENGINEER:	REIKENIS & ASSOCIATES LLC 13081 SE GREEN TURTLE WAY TEQUESTA, FL 33469 (561) 818-5381
ARCHITECT:	LCA ARCHITECTURE, INC. 1975 SANSBURY'S WAY SUITE 108 WEST PALM BEACH, FLORIDA 33411 (561) 493—4787
TRAFFIC ENGINEER:	SIMMONS & WHITE 5601 CORPORATE WAY WEST PALM BEACH, FLORIDA 33407 (561) 478-7848
PLANNER/ LANDSCAPE ARCHITECT:	JON E. SCHMIDT AND ASSOCIATES, INC. 2247 PALM BEACH LAKES BOULEVARD SUITE 101 WEST PALM BEACH, FLORIDA 33409 (561) 684-6141

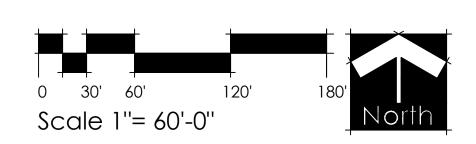

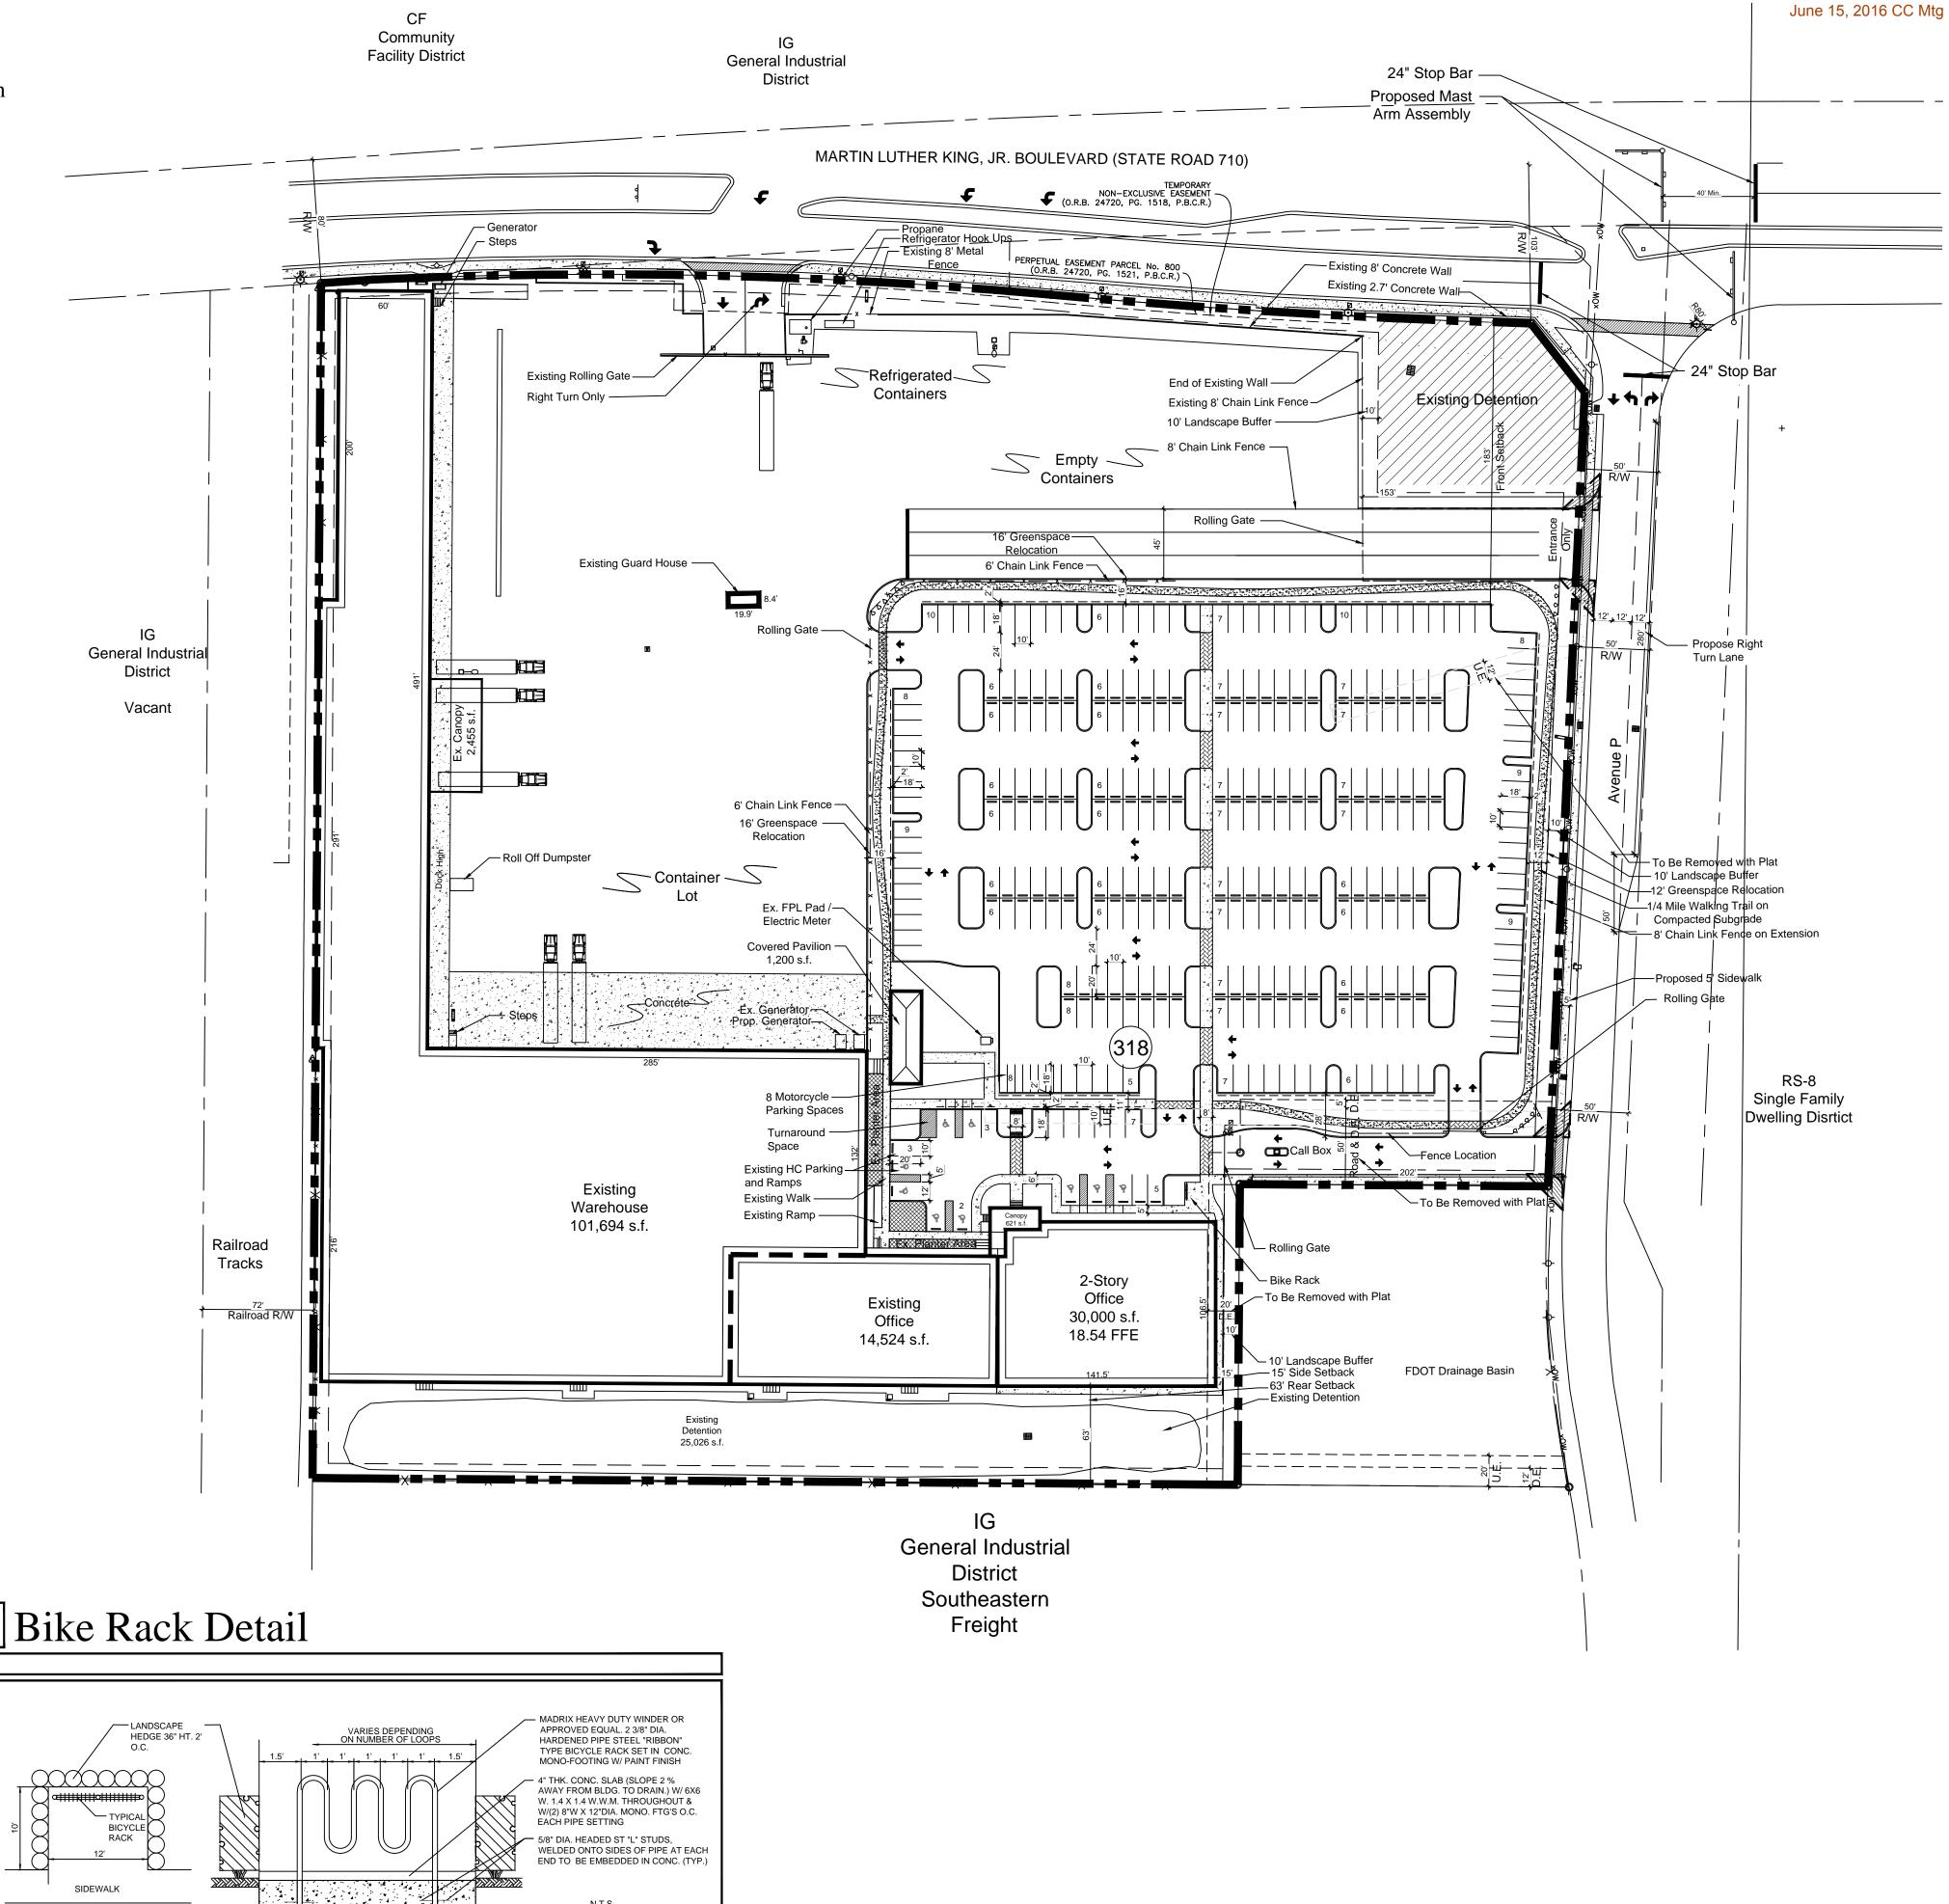

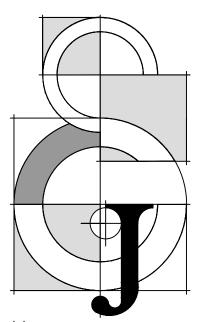


EXHIBIT 'A'

Jon E. Schmidt and Associates
Landscape Architecture & Site Planning
2247 Palm Beach Lakes Blvd.- Suite 101
West Palm Beach, Florida 33409
Tel. (561) 684-6141 • Fax. (561) 684-6142
E-mail: Jschmidt@jesla.com
Website: www.jesla.com
License No.: LC26000232

Tropical Shipping Riviera Facility


4-1	
Date:	05/21/14
Scale:	1'' = 60'-0''
Design By:	JES
Drawn By:	BMC
Checked By:	Jes
File No.	688.01
Job No.	14-08
11	


REVISIONS / SUBMISSIONS


07/15/14 Footprint Expansion
09/12/14 Footprint Expansion
09/30/14 Staff Comments
10/03/14 Fencing Revision 11/05/14 Trucks Removed
10/13/15 Ex. FPL Pad
10/13/15 Sidewalk Rev. 10/30/15 Entry Revisions.
10/30/15 Entry Revisions.
11/18/15 HC Parking Revisions
12/10/15 Remove Solar Canopies
03/18/T6 SP Amendment
05/1 <u>0</u> /16 Submittal

Phase 2B Site Plan

SP-1 of

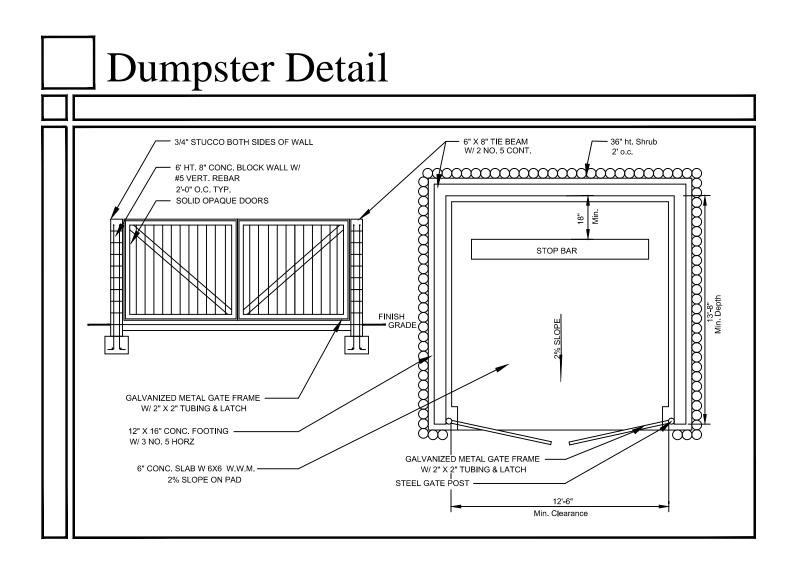

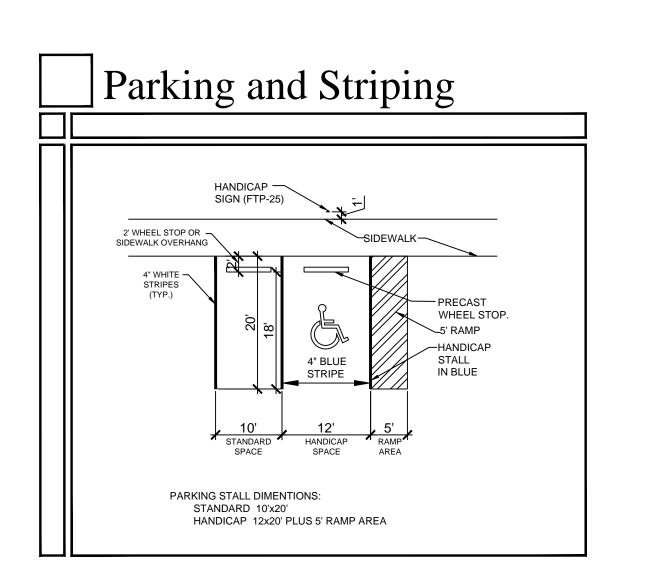

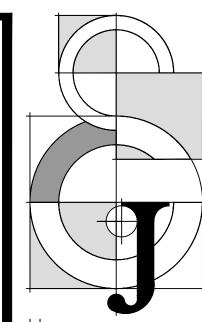

Date:	05/21/14
Scale:	NTS
Design By:	JES
Drawn By:	BMC
Checked By:	Jes
File No.	688.01
Job No.	14-08


REVISIONS / SUBMISSIONS

09/30/14 Staff Comments

03/18/16 SP Amendment

05/10/16 Submittal

Phase 2B Regulating Plan

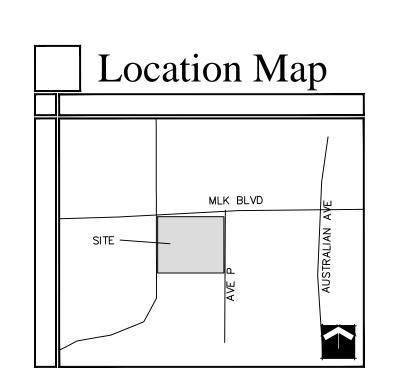

Phase 2B Tropical Shipping

ALI-1 Phase 2B Landscape Index

ALP-1 Phase 2B Foundation Landscape Plan


ALP-2 Phase 2B Parking Lot Landscape Plan

ALP-3 Phase 2B North End Landscape Plan


ALP-4 Upgraded Area Landscape Plan

ALP-5 Landscape Specifications

ALP-6 Tree Disposition Plan

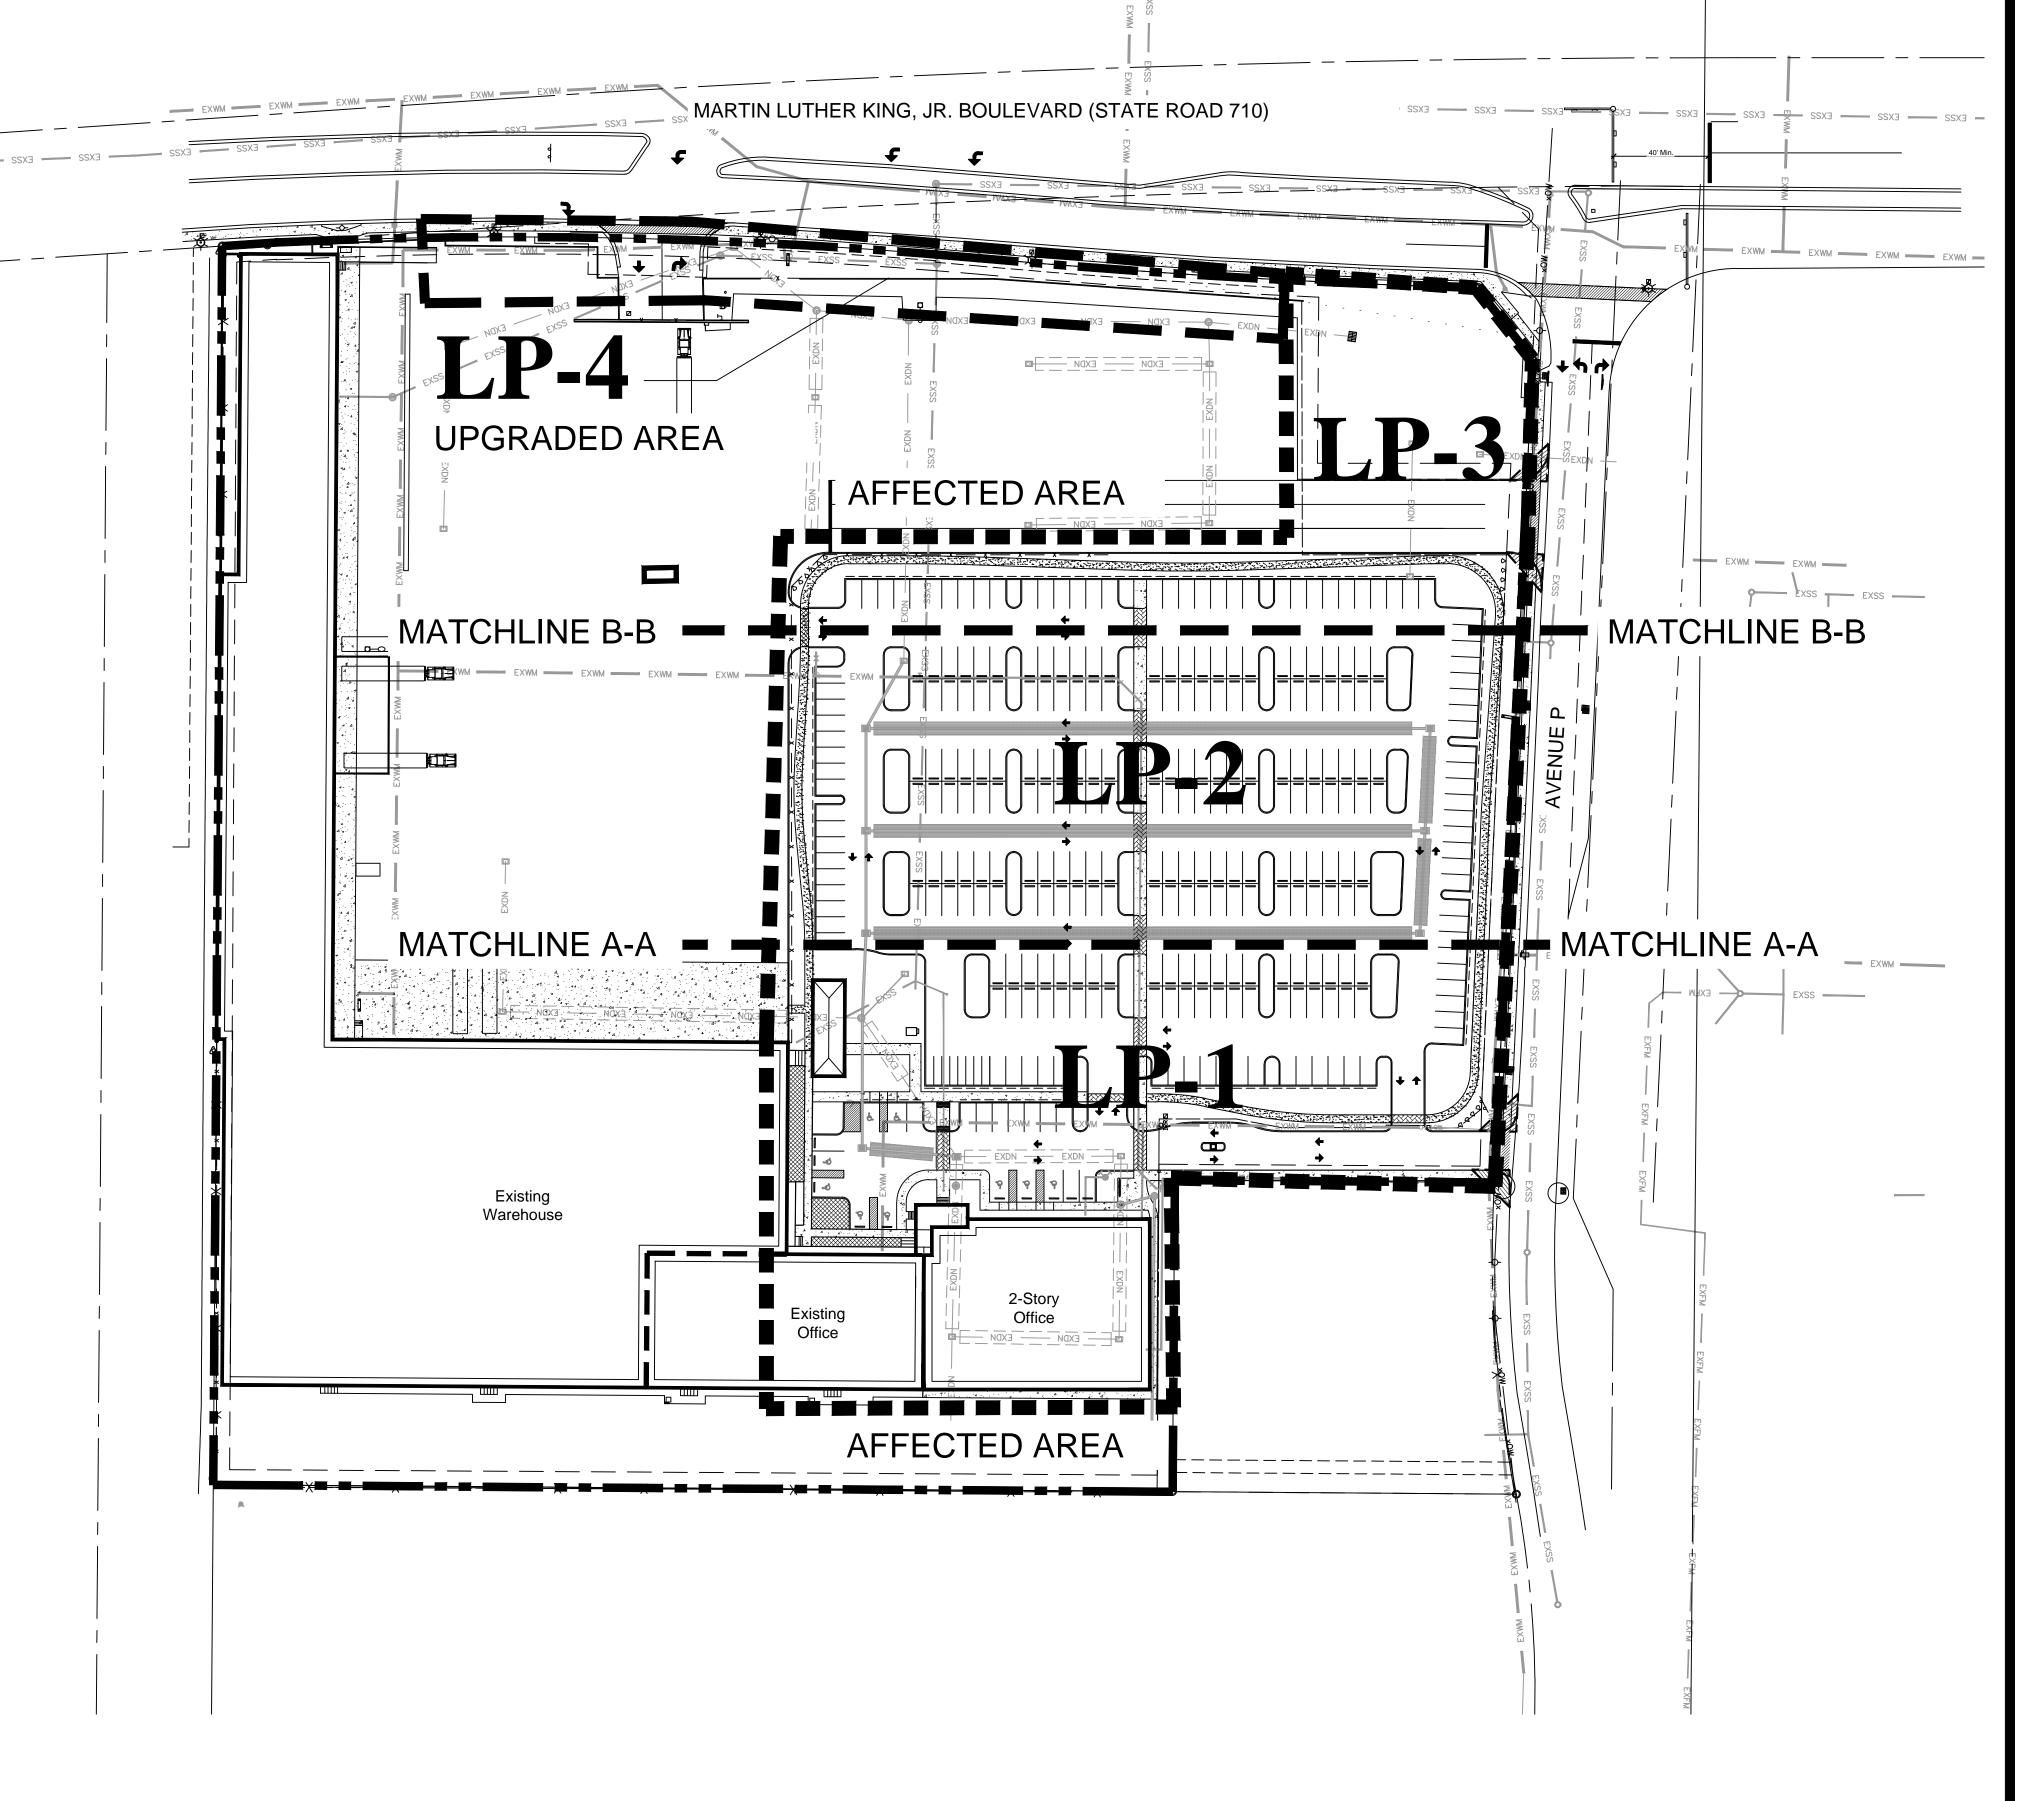



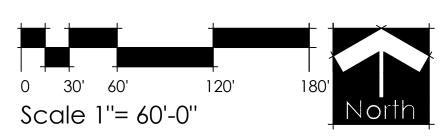

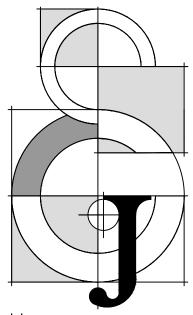


EXHIBIT 'A' June 15, 2016 CC Mtg

Ton E. Schmidt and Associated and Scape Architecture & Site Planning 2247 Palm Beach Lakes Blvd.- Suite 10 West Palm Beach, Florida 33409 [el. (561) 684-6141 • Fax. (561) 684-614 [e-mail: Jschmidt@jesla.com Website: www.jesla.com

Tropical Shipping Riviera Facility

Date: 5/21/14
Scale: 1" = 60'-0"
Design By: JES
Drawn By: BMC
Checked By: Jes
File No. 688.01
Job No. 14-08

revisions / submissions

09/30/14 Staff Comments
10/03/14 Fencing Revision
01/13/15 MYC Spec
10/14/15 FPL Pad/Easment Re

10/14/15 FPL Pad/Easment Rev. 01/18/16 Alternative Plan Create 03/17/16 Revise per Civil Plan 05/10/16 Submittal

NOT VALID WITHOUT THE SIGNATURE AI ORIGINAL RAISED SEAL OF A FLORIDA LICENSED LANDSCAPE ARCHITECT.


Printed name

Phase 2B


Landscape Index

LI-1

 αf

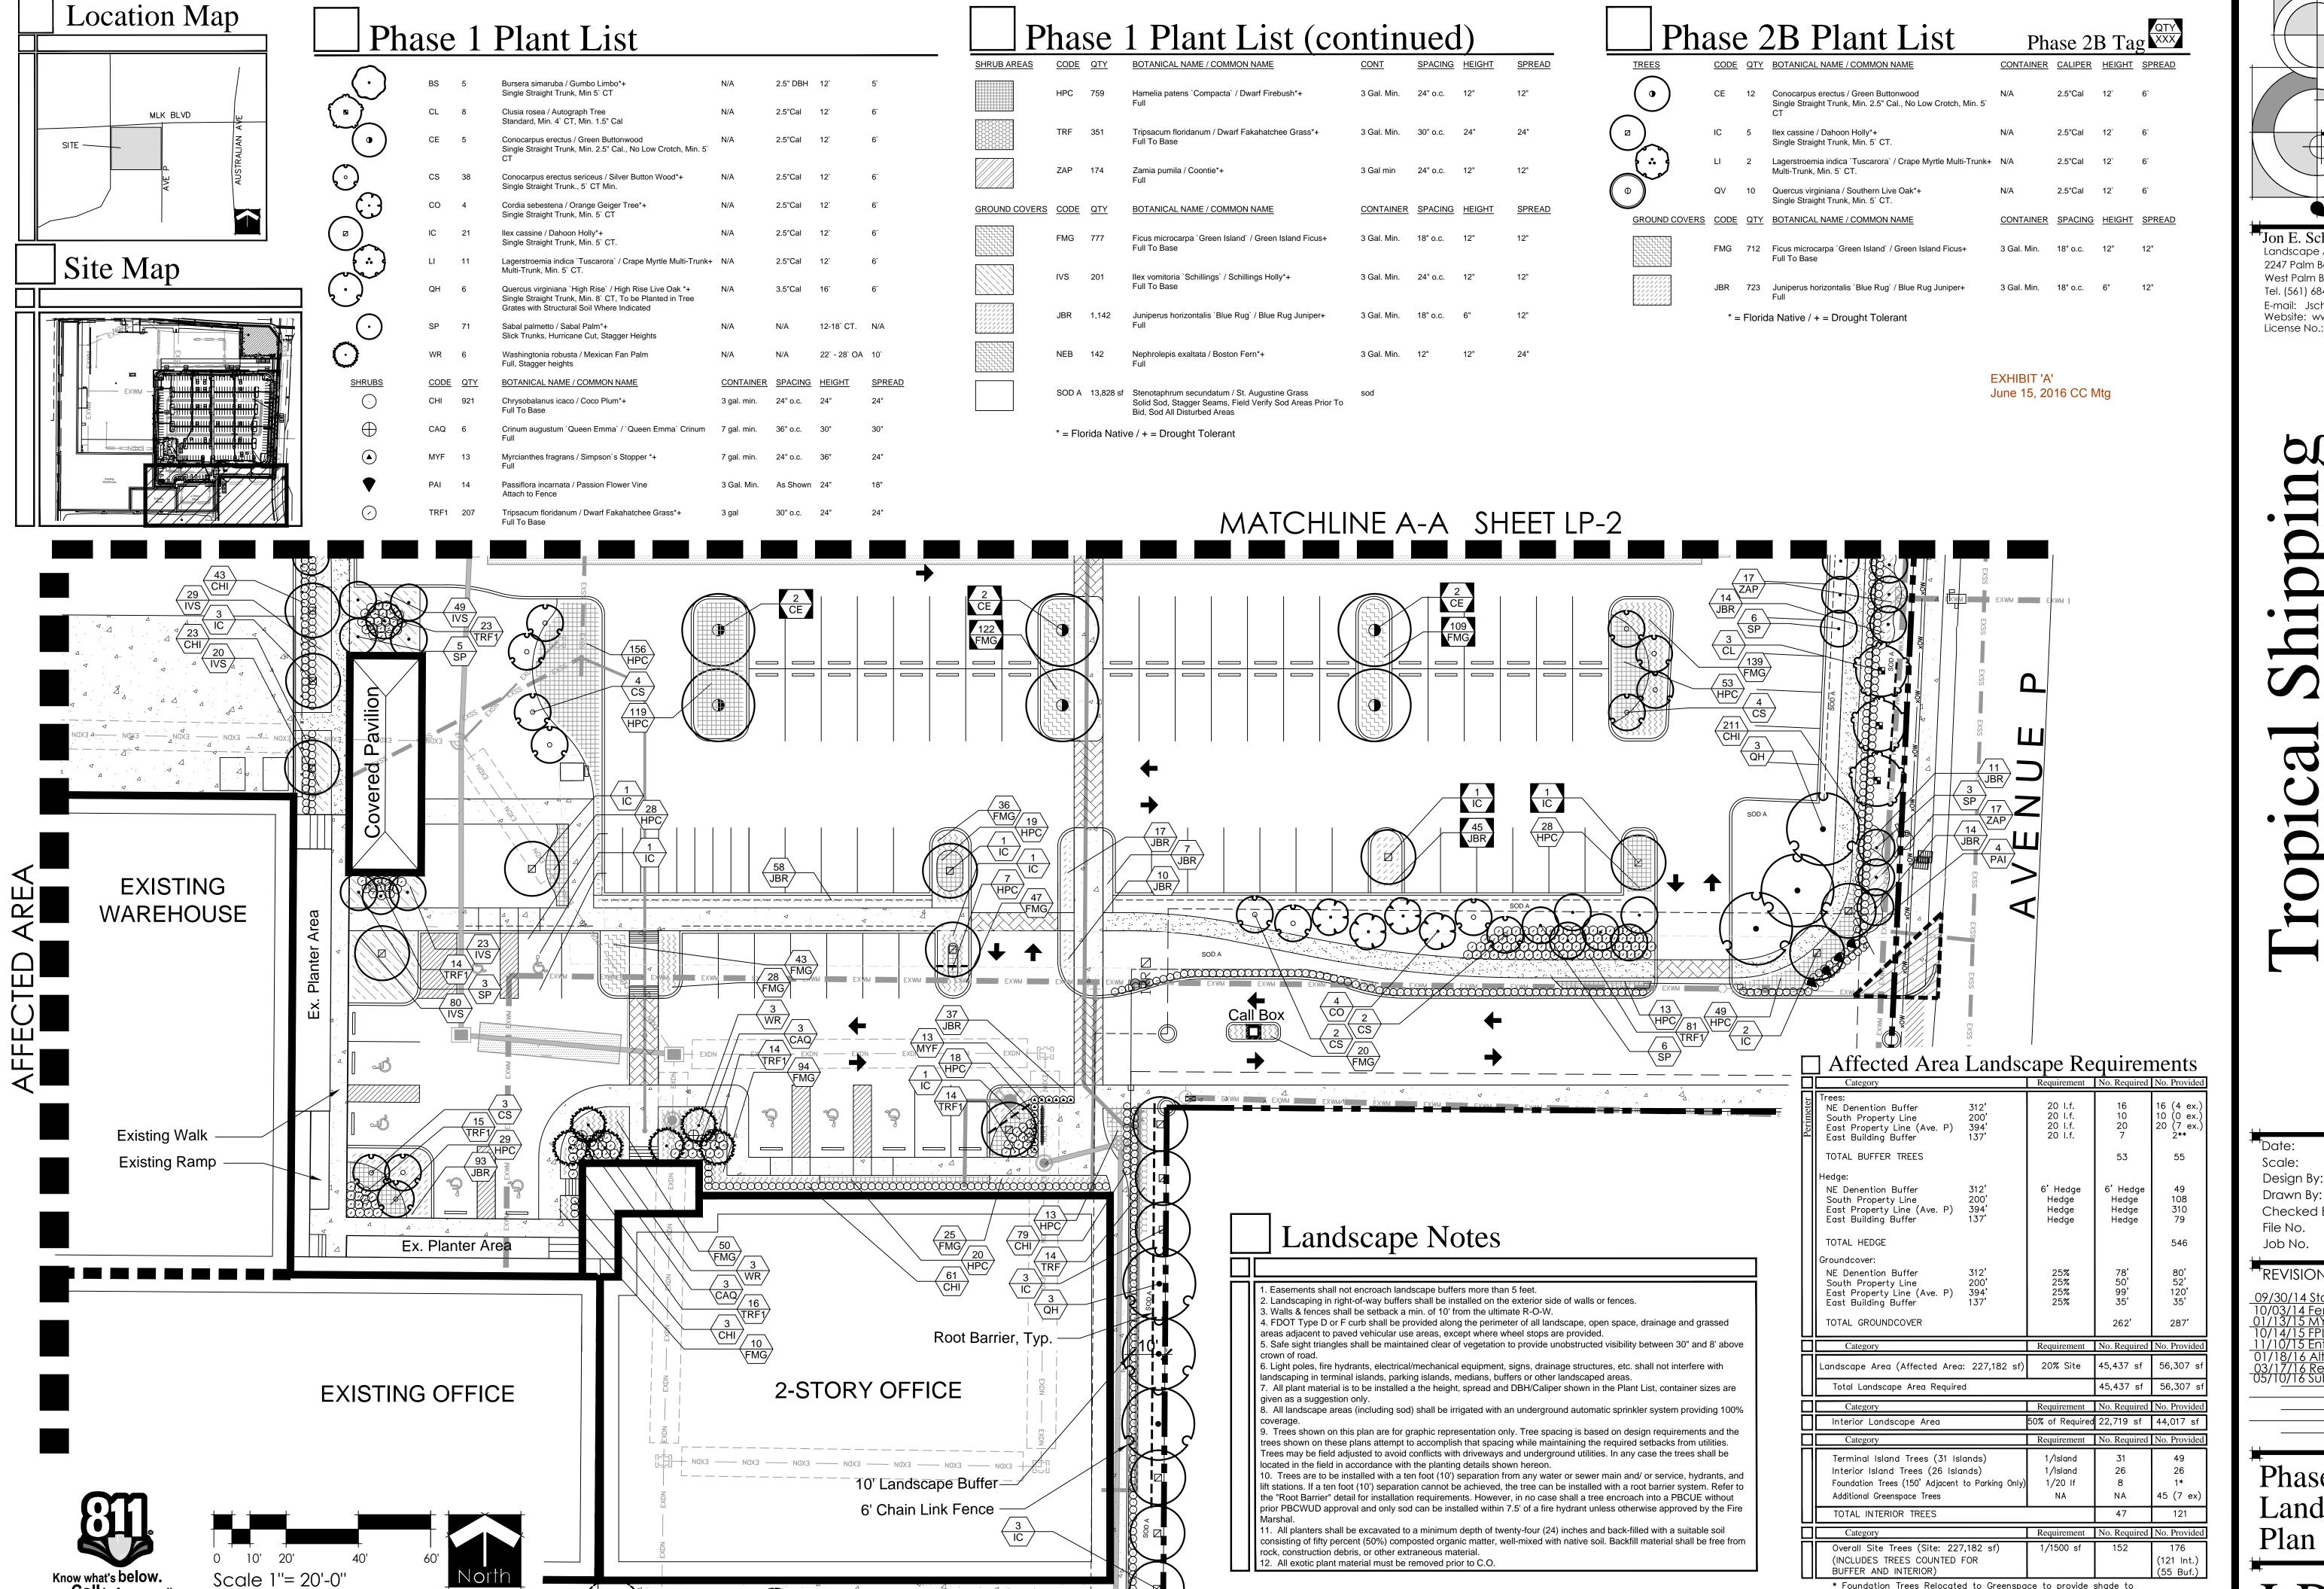

Call before you dig.

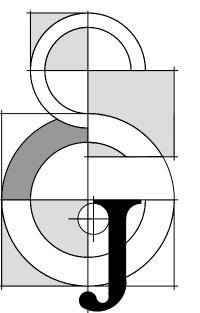

Jon E. Schmidt and Associates Landscape Architecture & Site Planning 2247 Palm Beach Lakes Blvd.- Suite 101 West Palm Beach, Florida 33409 Tel. (561) 684-6141 • Fax. (561) 684-6142 E-mail: Jschmidt@jesla.com Website: www.jesla.com License No.: LC26000232

Date:	5/21/14
Scale:	1" = 20'-0"
Design By:	JES
Drawn By:	ВМС
Checked By:	Jes
File No.	688.01
Job No.	14-08

$^{ extsf{ t}}$ revisions / submissions

703/14 Fencing Revision 713/15 MYC Spec 714/15 FPL Pad/Easment Rev. 710/15 Entry Revisions


01/1<u>8/16 Alternative Plan Created</u> 03/17/16 Revise per Civil Plan 05/10/16 Submitfal


Phase 2B Landscape

* Foundation Trees Relocated to Greenspace to provide shade to

pathway, parking and increase buffering of site.

** Fire Main within Buffer

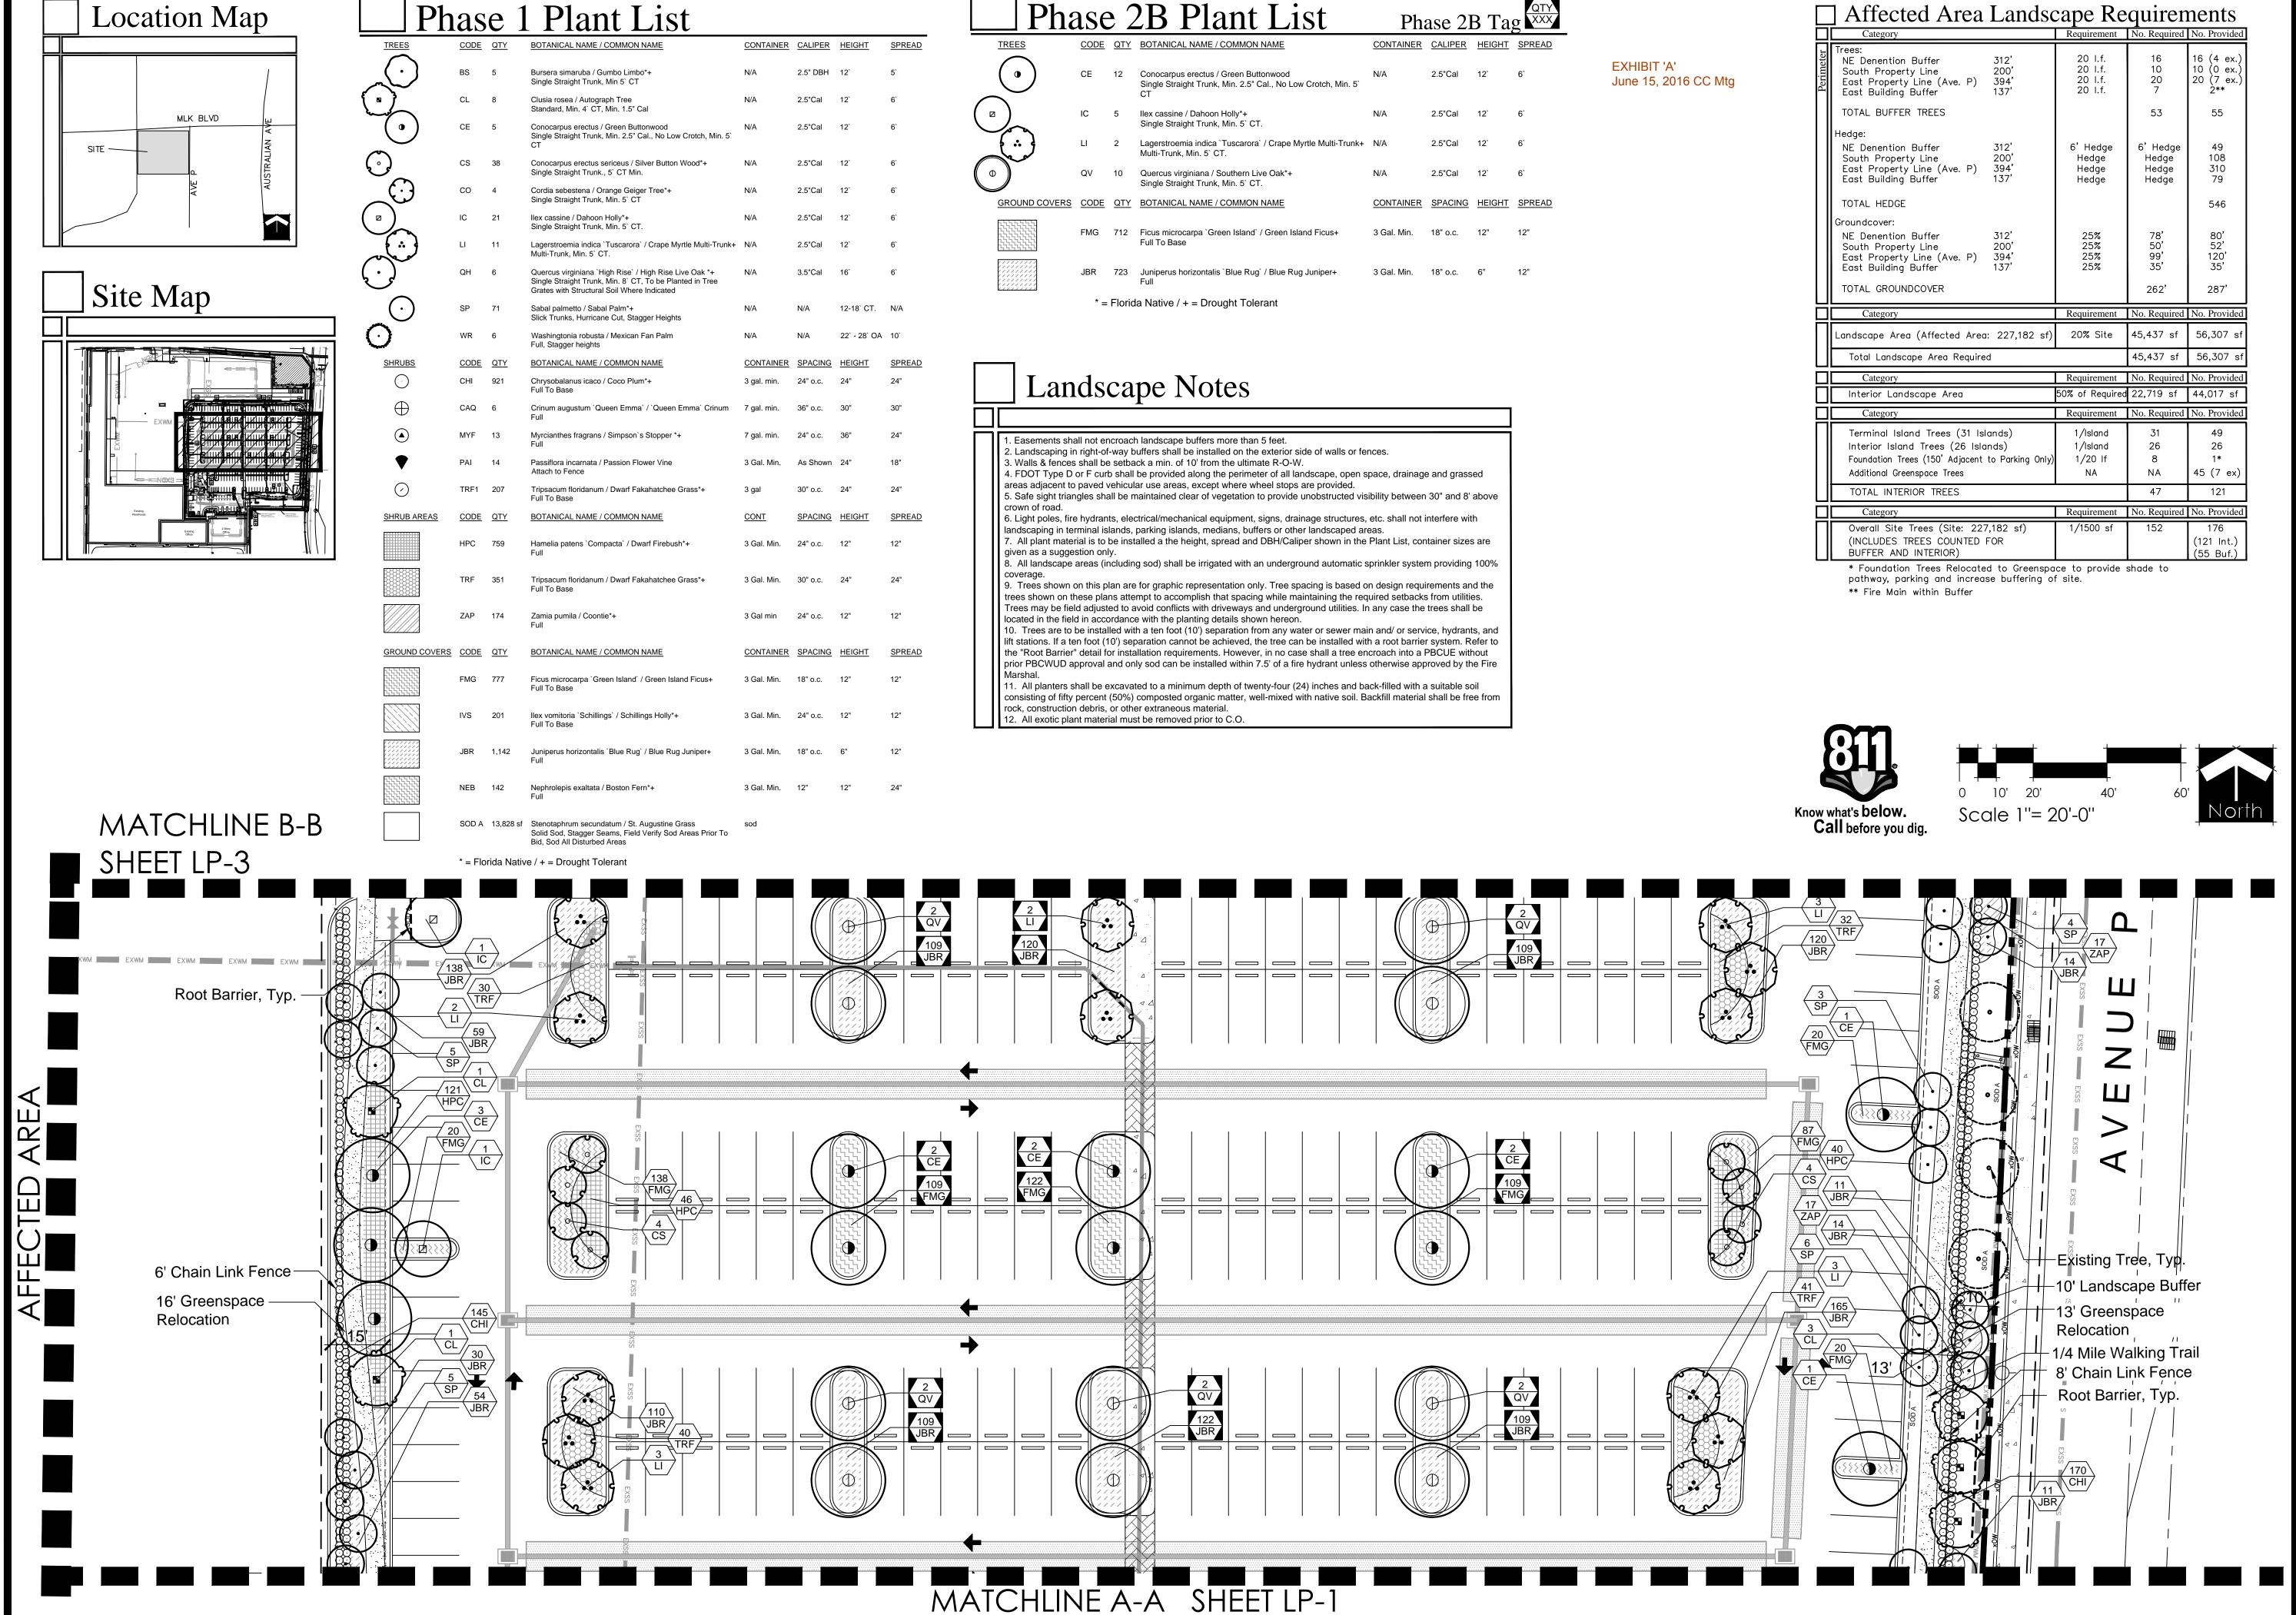

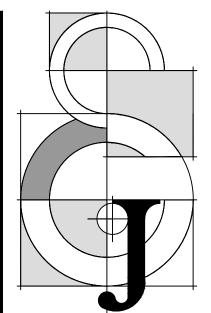


Beach,

-	
Date:	5/21/14
Scale:	1" = 20'-0"
Design By:	JES
Drawn By:	BMC
Checked By:	Jes
File No.	688.01
Job No.	14-08

 $^{ extsf{T}}$ revisions / submissions

09/30/14 Staff Comments
10/03/14 Fencing Revision
01/13/15 MYC Spec
10/14/15 FPL Pad/Easment Rev.
11/10/15 Entry Revisions
01/18/16 Alternative Plan Created
03/17/16 Revise per Civil Plan
05/10/16 Submittal

Phase 2B Landscape Plan

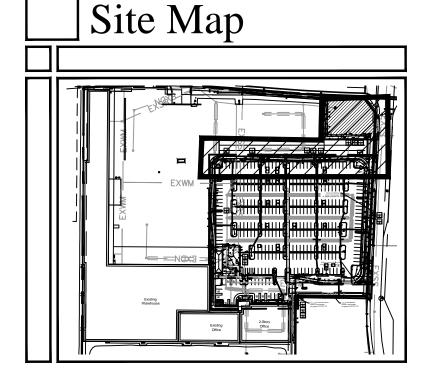

	Category		Requirement	No. Required	No. Provide
Perimeter	Trees: NE Denention Buffer South Property Line East Property Line (Ave. P) East Building Buffer TOTAL BUFFER TREES	312' 200' 394' 137'	20 l.f. 20 l.f. 20 l.f. 20 l.f.	16 10 20 7	16 (4 ex. 10 (0 ex. 20 (7 ex. 2**
	Hedge:				
	NE Denention Buffer South Property Line East Property Line (Ave. P) East Building Buffer	312' 200' 394' 137'	6' Hedge Hedge Hedge Hedge	6' Hedge Hedge Hedge Hedge	49 108 310 79
	TOTAL HEDGE				546
ı	Groundcover:				
	NE Denention Buffer South Property Line East Property Line (Ave. P) East Building Buffer	312' 200' 394' 137'	25% 25% 25% 25%	78' 50' 99' 35'	80' 52' 120' 35'

TOTAL GROUNDCOVER

1	ffected Area Landscap	e Requ	iireme	nts (co	ont.)	ſ
	Category	Requirement	No. Required	No. Provided		
П						L

	Landscape Area (Affected Area: 227,182 sf)	20% Site	45,437 sf	56,307 sf
	Total Landscape Area Required		45,437 sf	56,307 st
	Category	Requirement	No. Required	No. Provided
	Interior Landscape Area	50% of Required	22,719 sf	44,017 sf
	Category	Requirement	No. Required	No. Provided
	Terminal Island Trees (31 Islands) Interior Island Trees (26 Islands) Foundation Trees (150' Adjacent to Parking Only) Additional Greenspace Trees	1/Island 1/Island 1/20 If NA	31 26 8 NA	49 26 1* 45 (7 ex)
L	TOTAL INTERIOR TREES		47	121
	Category	Requirement	No. Required	No. Provided
	Overall Site Trees (Site: 227,182 sf) (INCLUDES TREES COUNTED FOR BUFFER AND INTERIOR)	1/1500 sf	152	176 (121 Int.) (55 Buf.)
	* Foundation Trees Relocated to Greenspa	ice to provide	shade to	


* Foundation Trees Relocated to Greenspace to provide shade t
pathway, parking and increase buffering of site.
** Fire Main within Buffer


June 15, 2016 CC Mtg Landscape Notes

EXHIBIT 'A'

- 1. Easements shall not encroach landscape buffers more than 5 feet. 2. Landscaping in right-of-way buffers shall be installed on the exterior side of walls or fences. 3. Walls & fences shall be setback a min. of 10' from the ultimate R-O-W.
- 4. FDOT Type D or F curb shall be provided along the perimeter of all landscape, open space, drainage and grassed areas adjacent to paved vehicular use areas, except where wheel stops are provided.
- 5. Safe sight triangles shall be maintained clear of vegetation to provide unobstructed visibility between 30" and 8' above
- 6. Light poles, fire hydrants, electrical/mechanical equipment, signs, drainage structures, etc. shall not interfere with landscaping in terminal islands, parking islands, medians, buffers or other landscaped areas. 7. All plant material is to be installed a the height, spread and DBH/Caliper shown in the Plant List, container sizes are
- given as a suggestion only. 8. All landscape areas (including sod) shall be irrigated with an underground automatic sprinkler system providing 100%
- 9. Trees shown on this plan are for graphic representation only. Tree spacing is based on design requirements and the
- trees shown on these plans attempt to accomplish that spacing while maintaining the required setbacks from utilities. Trees may be field adjusted to avoid conflicts with driveways and underground utilities. In any case the trees shall be located in the field in accordance with the planting details shown hereon.
- 10. Trees are to be installed with a ten foot (10') separation from any water or sewer main and/ or service, hydrants, and lift stations. If a ten foot (10') separation cannot be achieved, the tree can be installed with a root barrier system. Refer to the "Root Barrier" detail for installation requirements. However, in no case shall a tree encroach into a PBCUE without
- prior PBCWUD approval and only sod can be installed within 7.5' of a fire hydrant unless otherwise approved by the Fire 11. All planters shall be excavated to a minimum depth of twenty-four (24) inches and back-filled with a suitable soil
- consisting of fifty percent (50%) composted organic matter, well-mixed with native soil. Backfill material shall be free from

rock, construction debris, or other extraneous material. 12. All exotic plant material must be removed prior to C.O.

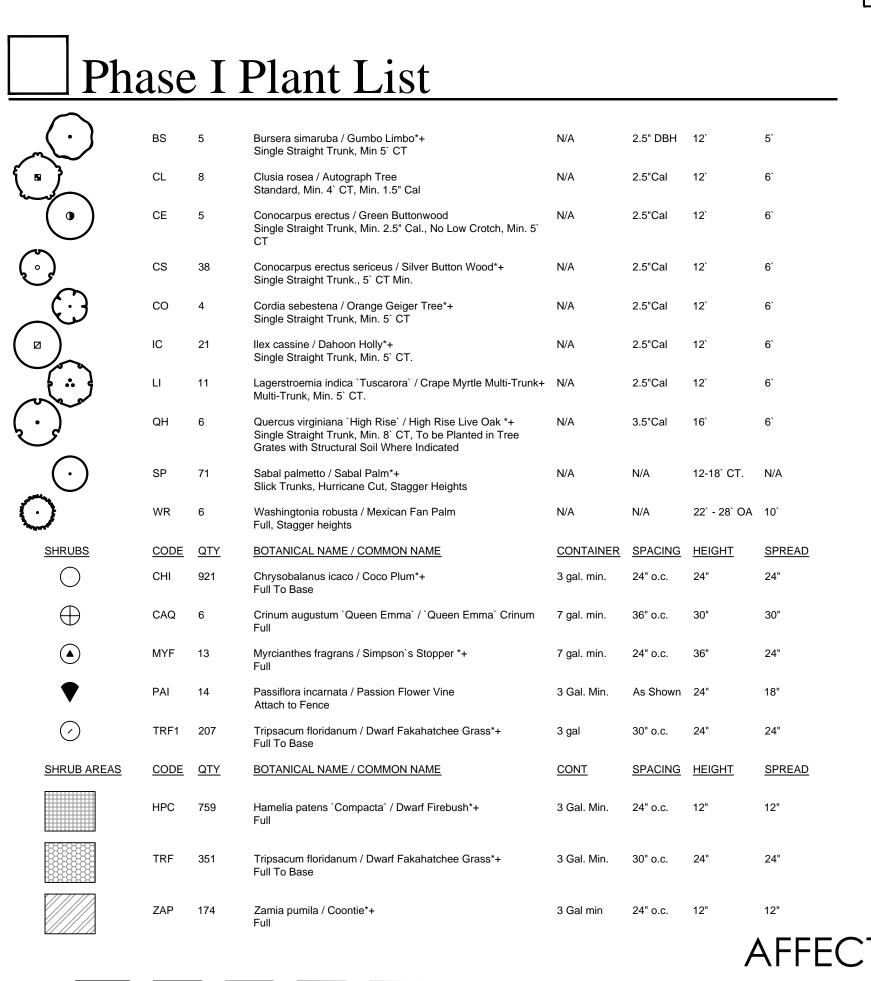


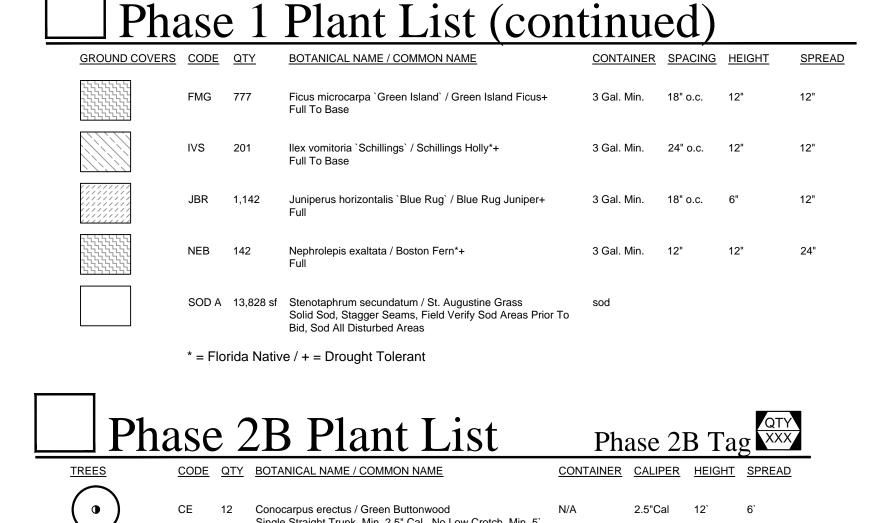


262'

287'

Pha	ase	2	2B Plant List	Pha	ase 21	В Та	$g^{\frac{QTY}{XXX}}$
TREES	CODE	QTY	BOTANICAL NAME / COMMON NAME	CONTAINER	CALIPER	<u>HEIGHT</u>	SPREAD
•	CE	12	Conocarpus erectus / Green Buttonwood Single Straight Trunk, Min. 2.5" Cal., No Low Crotch, Min. 5` CT	N/A	2.5"Cal	12`	6`
	IC	5	Ilex cassine / Dahoon Holly*+ Single Straight Trunk, Min. 5` CT.	N/A	2.5"Cal	12`	6`
	LI	2	Lagerstroemia indica `Tuscarora` / Crape Myrtle Multi-Trunk+ Multi-Trunk, Min. 5` CT.	N/A	2.5"Cal	12`	6`
\bigcirc	QV	10	Quercus virginiana / Southern Live Oak*+ Single Straight Trunk, Min. 5` CT.	N/A	2.5"Cal	12`	6`
GROUND COVERS	CODE	<u>QTY</u>	BOTANICAL NAME / COMMON NAME	CONTAINER	SPACING	<u>HEIGHT</u>	SPREAD
	FMG	712	Ficus microcarpa `Green Island` / Green Island Ficus+Full To Base	3 Gal. Min.	18" o.c.	12"	12"
· · · · · · · · · · · · · · · · · · ·	JBR	723	Juniperus horizontalis `Blue Rug` / Blue Rug Juniper+Full	3 Gal. Min.	18" o.c.	6"	12"
	* =	Floric	la Native / + = Drought Tolerant				

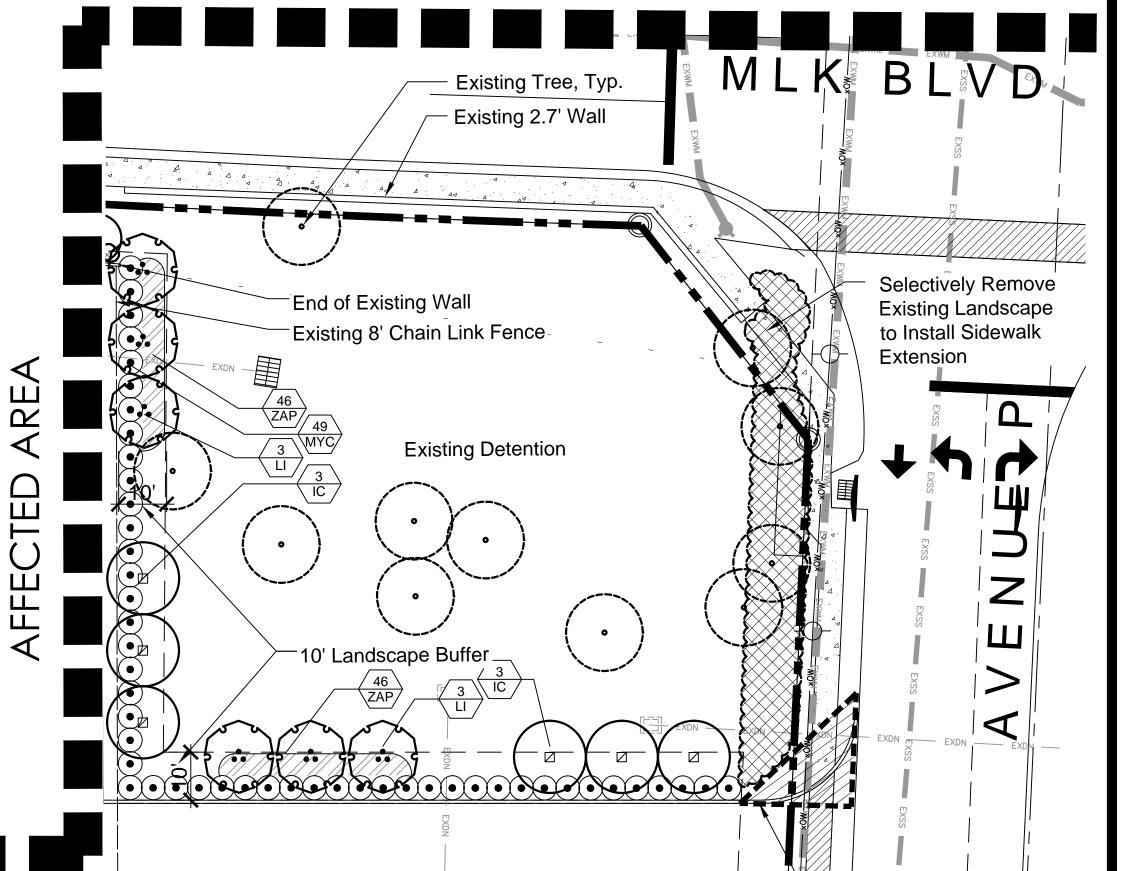


	AFFE	CTED AREA
EXD		EX XSS

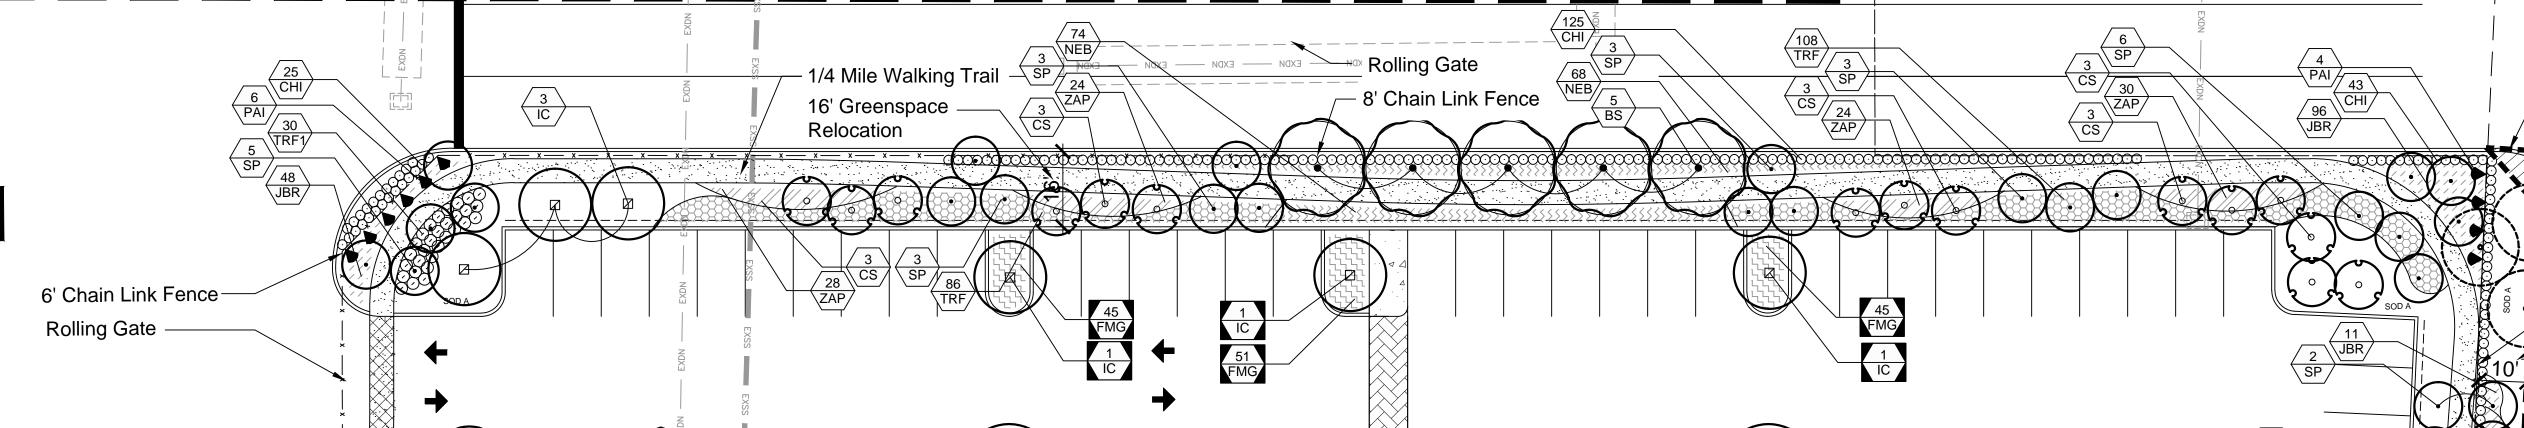

MATCHLINE B-B SHEET LP-2



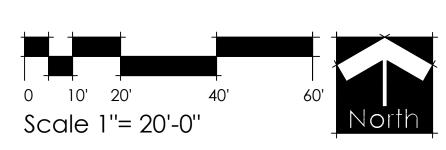

Phase 2B Landscape Plan

Jon E. Schmidt and Associates Landscape Architecture & Site Planning 2247 Palm Beach Lakes Blvd.- Suite 101 West Palm Beach, Florida 33409 Tel. (561) 684-6141 • Fax. (561) 684-6142 E-mail: Jschmidt@jesla.com Website: www.jesla.com License No.: LC26000232

1.1	
Date:	5/21/14
Scale:	1" = 20'-0"
Design By:	JES
Drawn By:	BMC
Checked By:	Jes
File No.	688.01
Job No.	14-08

Triangle, Typ.


8' Chain Link Fence

10' Landscape Buffer

 $^{ extsf{T}}$ revisions / submissions

09/30/14 Staff Comments

0/03/14 Fencing Revision
1/13/15 MYC Spec
0/14/15 FPL Pad/Easment Rev.
1/10/15 Entry Revisions
01/18/16 Alternative Plan Created
3/17/16 Revise per Civil Plan
5/10/16 Submittal

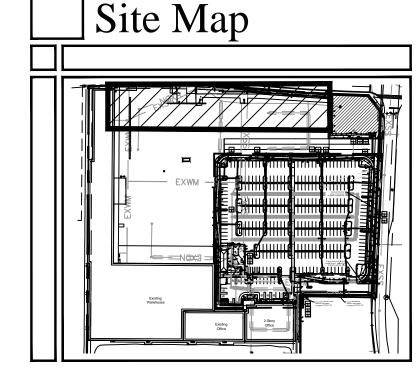

Landscape Notes

. All exotic plant material must be removed prior to C.O.

- . Easements shall not encroach landscape buffers more than 5 feet. 2. Landscaping in right-of-way buffers shall be installed on the exterior side of walls or fences. 3. Walls & fences shall be setback a min. of 10' from the ultimate R-O-W.
- 4. FDOT Type D or F curb shall be provided along the perimeter of all landscape, open space, drainage and grassed areas adjacent to paved vehicular use areas, except where wheel stops are provided. 5. Safe sight triangles shall be maintained clear of vegetation to provide unobstructed visibility between 30" and 8' above
- 6. Light poles, fire hydrants, electrical/mechanical equipment, signs, drainage structures, etc. shall not interfere with landscaping in terminal islands, parking islands, medians, buffers or other landscaped areas. 7. All plant material is to be installed a the height, spread and DBH/Caliper shown in the Plant List, container sizes are
- given as a suggestion only. 8. All landscape areas (including sod) shall be irrigated with an underground automatic sprinkler system providing 100%). Trees shown on this plan are for graphic representation only. Tree spacing is based on design requirements and the
- trees shown on these plans attempt to accomplish that spacing while maintaining the required setbacks from utilities. Frees may be field adjusted to avoid conflicts with driveways and underground utilities. In any case the trees shall be ocated in the field in accordance with the planting details shown hereon. 10. Trees are to be installed with a ten foot (10') separation from any water or sewer main and/ or service, hydrants, and lift stations. If a ten foot (10') separation cannot be achieved, the tree can be installed with a root barrier system. Refer to
- prior PBCWUD approval and only sod can be installed within 7.5' of a fire hydrant unless otherwise approved by the Fire 11. All planters shall be excavated to a minimum depth of twenty-four (24) inches and back-filled with a suitable soil consisting of fifty percent (50%) composted organic matter, well-mixed with native soil. Backfill material shall be free from rock, construction debris, or other extraneous material.

the "Root Barrier" detail for installation requirements. However, in no case shall a tree encroach into a PBCUE without

___ Upgraded Area Plant List

TREES	CODE	<u>QTY</u>	BOTANICAL NAME / COMMON NAME	CONTAINER	CALIPER	<u>HEIGHT</u>	SPREAD
	BS	1	Bursera simaruba / Gumbo Limbo*+ Single Straight Trunk, Min 5` CT	N/A	2.5" DBH	12`	5`
<i>{ }</i>	LI	3	Lagerstroemia indica `Tuscarora` / Crape Myrtle Multi-Trunk+ Multi-Trunk, Min. 5` CT.	N/A	2.5"Cal	12`	6`
\odot	SP	24	Sabal palmetto / Sabal Palm*+ Slick Trunks, Hurricane Cut, Stagger Heights	N/A	N/A	12-18` CT.	N/A
SHRUB AREAS	CODE	<u>QTY</u>	BOTANICAL NAME / COMMON NAME	CONT	SPACING	<u>HEIGHT</u>	SPREAD
	HPC	113	Hamelia patens `Compacta` / Dwarf Firebush*+ Full	3 Gal. Min.	24" o.c.	12"	12"

EXHIBIT 'A' June 15, 2016 CC Mtg

Ц	Category	Requirement	No. Required	No. Provide
Perimeter	Trees: NE Denention Buffer 312' South Property Line 200' East Property Line (Ave. P) 394' East Building Buffer 137'	20 l.f. 20 l.f. 20 l.f. 20 l.f.	16 10 20 7	16 (4 ex. 10 (0 ex. 20 (7 ex. 2**
	TOTAL BUFFER TREES		53	55
	Hedge: NE Denention Buffer 312' South Property Line 200' East Property Line (Ave. P) 394' East Building Buffer 137'	6' Hedge Hedge Hedge Hedge	6' Hedge Hedge Hedge Hedge	49 108 310 79
	TOTAL HEDGE			546
	Groundcover: NE Denention Buffer 312' South Property Line 200' East Property Line (Ave. P) 394' East Building Buffer 137'	25% 25% 25% 25%	78' 50' 99' 35'	80' 52' 120' 35'
	TOTAL GROUNDCOVER		262'	287'
口	Category	Requirement	No. Required	No. Provide
П	Landscape Area (Affected Area: 227,182 sf)	20% Site	45,437 sf	56,307 s
			45,437 sf	56,307
	Total Landscape Area Required		-	
	Total Landscape Area Required Category	Requirement	No. Required	No. Provide
	Category	Requirement 50% of Required		
	Category			44,017 sf

BUFFER AND INTERIOR) * Foundation Trees Relocated to Greenspace to provide shade to pathway, parking and increase buffering of site.

Interior Island Trees (26 Islands)

Additional Greenspace Trees

TOTAL INTERIOR TREES

Category

Foundation Trees (150' Adjacent to Parking Only)

Overall Site Trees (Site: 227,182 sf)

(INCLUDES TREES COUNTED FOR

Upgraded Area Notes

• Upgraded area improvements are not included in the affected area landscape requirements, and are additional to the numbers seen in the chart.

1/Island

1/20 If

1/1500 sf


26

Requirement No. Required No. Provided


45 (7 ex)


(121 Int.)

UPGRADED AREA

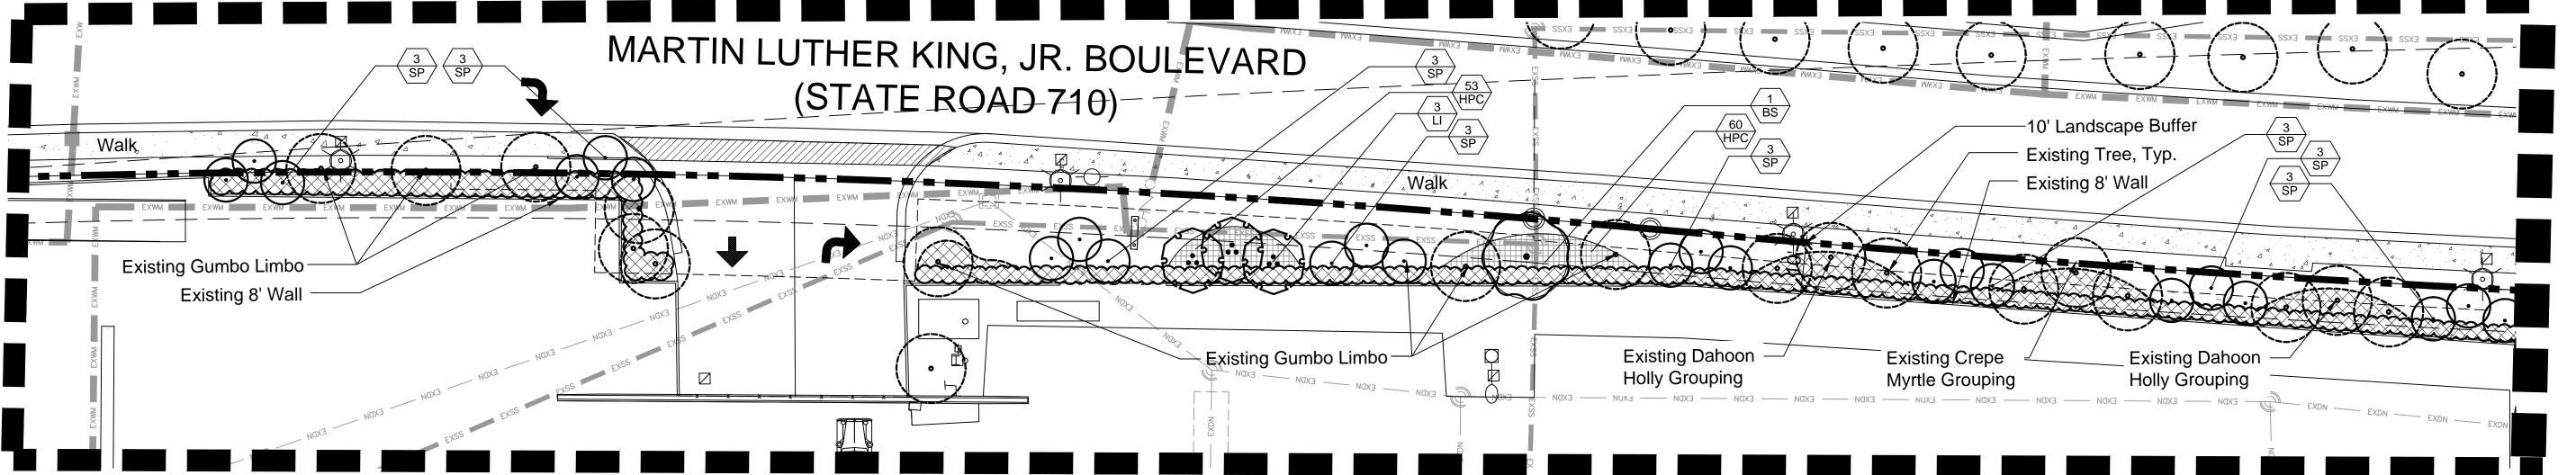

UPGRADED AREA

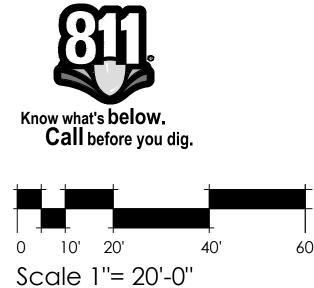

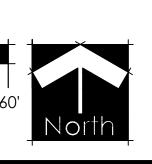

Jon E. Schmidt and Associates Landscape Architecture & Site Planning 2247 Palm Beach Lakes Blvd.- Suite 101

Tel. (561) 684-6141 • Fax. (561) 684-6142

West Palm Beach, Florida 33409

E-mail: Jschmidt@jesla.com Website: www.jesla.com License No.: LC26000232

5/21/14 1'' = 20'-0'' Scale: Design By: BMCDrawn By: Checked By: 14-08 Job No.

REVISIONS / SUBMISSIONS

09/30/14 Staff Comments
10/03/14 Fencing Revision
01/13/15 MYC Spec
10/14/15 FPL Pad/Easment Rev.
11/10/15 Entry Revisions
01/18/16 Alternative Plan Created
03/17/16 Revise per Civil Plan
05/10/16 Submittal

Phase 2B Landscape Plan

^{**} Fire Main within Buffer

- 1.01 WORK INCLUDED
 - Extent of planting work is shown on drawings and in schedules. Subgrade Elevations: Excavation, filling and grading required to establish elevations 4" lower than elevations and contours shown on drawings are not
- specified in this Section. C. Finish Grade Elevations: 1 inch below top of pathway edging.

1.02 QUALITY ASSURANCE

- A. Subcontract landscape work to a single firm specializing in landscape work. B. Source Quality Control:
 - 1. General: Ship landscape materials with certificates of inspection required by governing authorities. Comply with regulations applicable to landscape materials.
 - 2. Do not make substitutions. If specified landscape material is not obtainable, submit to Landscape Architect proof of non-availability and proposal for use of equivalent material. When authorized, adjustment of contract amount will be made.
 - Analysis and Standards: Package standard products with manufacturer's certified analysis. For other materials, provide analysis by recognized laboratory made in accordance with methods established by the Association of Official Agricultural Chemists, wherever applicable.
 - 4. Trees, Palms and Shrubs: Provide trees, palms and shrubs grown in a recognized nursery in accordance with good horticultural practice. Provide healthy, vigorous stock free of disease, insects, eggs, larvae, and defects such as decay, knots, sun-scald, injuries, abrasions disfigurement. Provide trees, palms and shrubs for grade needed as outlined under Grades and Standards for Nursery Plants, State Plant Board of Florida, unless otherwise noted.
 - a. Sizes: Provide trees and shrubs of sizes shown or specified. Trees, palms and shrubs of larger size may be used if acceptable to Landscape Architect, and if sizes of roots or balls are increased proportionately.
- C. Inspection: Landscape Architect reserves right to inspect trees, palms and shrubs either at place of growth or at site before planting, for compliance with requirements for name, variety, size and quality.

1.03 SUBMITTALS

- A. Certification: Submit certificates of inspections as required by governmental authorities, and manufacturer's or vendor's certified analysis for soil amendments and fertilizer materials. Submit other data substantiating that materials comply with specified requirements
- B. Submit seed vendor's certified statement for each grass seed mixture required, stating botanical and common name, percentage by weight, and percentage of purity, germination, and weed seed for each grass seed species. Planting Schedule:
- Submit planting schedule showing schedule dates for each type of planting in each area of site. Maintenance Instructions:
- Submit typewritten procedures for maintenance of landscape work.

1.04 DELIVERY, STORAGE AND HANDLING

- A. Packaged Materials: Deliver packaged materials in original containers showing weight analysis and name of manufacturer. Protect materials from deterioration during delivery, and while stored at site.
- Sod: Time delivery so that sod will be placed within 24 hours after stripping. Protect sod against drying and breaking of rolled strips. C. Trees, palms and shrubs: Provide freshly dug trees, palms and shrubs. Do not
- prune prior to delivery. Do not bend or bind—tie trees or shrubs in such a manner to damage bark, break branches or destroy natural shape. Provide protective covering during delivery. D. Deliver trees, palms and shrubs after preparations for planting have been
- completed and plant immediately. If planting is delayed more than 6 hours after delivery, set trees and shrubs in shade, protect from weather and mechanical damage, and keep roots moist.
- E. Do not remove container grown stock from containers until planting time

1.05 JOB CONDITIONS A. Proceed with and complete landscape work as rapidly as portions of site become

- B. Utilities: Determine location of underground utilities and perform work in a manner which will avoid possible damage. Hand excavate, as required. Maintain grade stakes set by others until removal is mutually agreed upon by parties
- Excavation: When conditions detrimental to plant growth are encountered, such as rubble fill, adverse drainage conditions, or obstructions, notify Landscape Architect before planting.
- D. Planting Schedule: Where applicable, prepare a proposed planting schedule. Schedule dates to establish a logical sequence for completing each type of landscape work to avoid damage to other landscape work and work performed by other disciplines. Correlate with specified maintenance periods to provide maintenance from date of substantial completion. Once accepted, revise dates
- only as approved in writing, after documentation of reasons for delay. Coordination with Lawns: Plant trees, palms and shrubs after final grades are established and prior to planting of lawns, unless otherwise acceptable to Landscape Architect. If planting of trees, palms and shrubs occurs after lawn work, protect lawn areas and promptly repair damage to lawns resulting from planting operations.

1.06 SPECIAL PROJECT WARRANTY

- Warrant lawns through specified maintenance period, and until final acceptance. The required period is for one full year following installation of lawn areas. B. Warrant trees for a period of one year after date of substantial completion against defects death and unsatisfactory growth, except for defects resulting from neglect by Owner, abuse or damage by others, or unusual phenomena or
- incidents which are beyond Landscape Contractor's control. Warrant shrubs for 1 full year after date of substantial completion. Remove and replace trees, shrubs or other plants found to be dead or in unhealthy condition during warranty period. Make replacements during growth season following end of warranty period. Replace trees and shrubs which are in doubtful condition at end of warranty period; unless, in opinion of the Landscape Architect, it is advisable to extend warranty period for a full growing season or for
- 1. Another inspection will be conducted at end of extended warranty period, to determine acceptance or rejection. Only one replacement will be required at end of warranty period, except for losses or replacements due to failure to comply with specified requirements.

PART 2 PRODUCTS

A. If topsoil is not available on site it must be furnished as specified. Throughout all parts of site where finish grades and contour lines differ from existing contour lines, bring to finish grade contours shown on "Grading Plan."

B. Topsoil shall be friable fertile soil with representative characteristics of area soils. It should be free of heavy clay, silt, stone, extraneous lime, plant roots and other foreign matter greater than 1 1/2" in diameter. It shall not contain noxious plant growth (such as bermuda or nut grass). It shall test in neutral Ph range of 5.0 to 6.75 and contain no toxic substances that can be deemed to impede plant growth. The contractor shall be prepared to have soil lab-tested at his expense by the Landscape Architect. Topsoil shall comply with the following quantative

COMPONENTS	VOLUME MEASURE	PARTICLE SIZE
Organic Matter Silt	3 - 5% 10 - 30%	0.05 to 0.002 MM
Sand Clay	25 - 75% 5 - 25%	0.2 to 0.05 MM 0.002 MM and below

2.02 SOIL AMENDMENTS If necessary to bring soil into above specified limits:

- A. Lime: Natural limestone (Dolomite) containing not less than 85% of total carbonates, ground so that not less than 90% passes a 10-mesh sieve and not
- less than 50% passes a 100-mesh sieve. B. Peat Humus or Peat Moss: Texture, moisture and pH range suitable for intended
- Humus Soil Conditioner: Consisting of yard trimmings and biosolids co-compost. Commercial Fertilizer: Complete fertilizer of neutral character, with 40% - 50% of the total nitrogen in a water insoluble form. It shall be uniform in composition, dry and free flowing.

- 1. For trees, palms and shrubs, provide fertilizer with not less than 6%
- available phosphoric acid, 6% nitrogen and 6% soluble potash. For lawns, provide fertilizer with not less than 6% phosphoric acid, and 6% potassium, and percentage of nitrogen required to provide not less than 1 lb. of actual nitrogen per 1000 square feet of lawn area. Provide nitrogen in a form that will be available to lawn during initial period of

2.03 PLANT MATERIAL

- A. Plant list is part of this specification section. B. Quality: Trees, palms, shrubs and other plants shall conform to the standards for Florida No. 1 or better as given in the latest edition of Grades and Standards for
- Nursery Plants, State Plant Board of Florida. C. Deciduous Trees: Provide trees of height and caliper listed or shown and with branching configuration for No. 1 graded trees in Grades and Standard for Nursery Plants for type and species required. Provide single stem trees except where special forms are shown or listed. Ball condition variable.
- D. Coniferous and Broadleafed Evergreens: Provide evergreens of size shown or listed. Dimensions indicate minimum height and spread. Provide specified quality evergreens with well-balanced form complying with requirements for other size relationships to the primary dimension shown.

2.04 GRASS MATERIALS

A. Grass Seed: Provide fresh, clean, new-crop seed complying with established tolerance for purity and germination. Provide seed of grass species, proportions and minimum percentages of purity, germination, and maximum percentage of weed seed, as specified. Attach a schedule of requirements. B. Sod: Provide strongly rooted sod free of weeds and undesirable native grasses.

2.05 MISCELLANEOUS LANDSCAPE MATERIALS

A. Ground Cover: Provide plants established and well-rooted in removable containers or internal peat pots and with not less than minimum number and length of runners specified.

capable of growth and development when planted.

- B. Anti-Erosion Mulch: Provide clean, dry, mulching hay or straw of coastal bermuda, pangola or bahia grass. Only undeteriorated mulch which can be readily cut into the soil shall be used. Mulch: Melaleuca or equal.
- D. Stakes and Guys: When required provide stakes and deadmen of sound new hardwood, treated softwood, or redwood, free of knot holes and other defects. Provide wire ties and guys of 2—strand, twisted, pliable galvanized iron wire not lighter than 12 ga. with zinc-coated turnbuckles. Provide not less than 1/2" hose, cut to required lengths to protect tree trunks from damage by wires.

PART 3 EXECUTION

3.01 LAYOUT

A. Layout individual trees and shrub locations and areas for multiple plantings. Stake locations and outline areas and secure Landscape Architect's acceptance before start of planting work. Make adjustments as maybe required.

3.02 PREPARATION OF PLANTING SOIL

- A. Before mixing, clean topsoil of roots, plants, sods, stones, clay lumps, and other extraneous materials harmful or toxic to plant growth. B. Mix specified soil amendments and fertilizers with topsoil at rates specified. Delay mixing of fertilizer if planting will not follow placing of planting soil within a few
- C. For planting beds, mix planting soil either prior to planting or apply on surface of topsoil and mix thoroughly before planting.
- Mix lime with dry soil prior to mixing of fertilizer.
- Prevent lime from contacting roots of acid—loving plants. D. Remove all shellrock encountered and backfill with clean sand or sand/soil mix.
- 3.03 PREPARATION FOR PLANTING AREAS (To include Lawn and Planting Bed Areas)
 - A. Spread a layer of 2 to 3 inches of humus soil conditioner over the entire planting area. Planting areas shall include all new sod areas, shrub areas and tree areas. These areas shall be as large as 3 times the diameter of the beds of the plants, except where confined by hardscape features such as paved parking areas, paved walk ways, structures, etc. Overlapping areas shall be considered to be one large planting area for the entire mass. The humus soil conditioner shall then be uniformly disked, tilled or aerified into the existing soil to a depth of 6 to 8 inches with the following exception: no rototilling shall occur closer to the trunks of established plants than one half the distance to the dripline of the existing plant canopy. All plants, including hedges and ground cover shall be planted in individually dug holes and the material dug from the holes shall then be further mixed with the prepared

3.04 PREPARATION FOR PLANTING LAWNS

- A. Preparation of Unchanged Grades: Where lawns are to be planted in areas that have not been altered or disturbed by excavating, grading, or stripping operations, prepare soil for lawn planting as follows: Till to a depth of not less than 6"; apply soil amendments and initial fertilizers; remove high areas and fill in depressions; till soil to a homogenous mixture of fine texture, free of lumps, clods, stones, roots and other extraneous matter.
 - 1. Prior to preparation of unchanged areas, remove existing grass, vegetation and turf. Dispose of such material outside of Owner's property; do not turn over into soil being prepared for lawns.

site soil prior to backfilling of the planting holes around the rootballs

- B. Elsewhere: Loosen subgrade of lawn areas to a minimum depth of 4". Remove stones over 1 1/2" in any dimension and sticks, roots, rubbish and other extraneous matter. Limit preparation to areas which will be planted promptly after
- 1. Spread planting soil mixture to minimum depth required to meet lines,
- grades and elevations shown, after light rolling and natural settlement. Place approximately 1/2 of total amount of planting soil required. Work into top of loosened subgrade to create a transition layer and then place remainder of planting soil.
- 3. Allow for sod thickness in areas to be sodded.
- C. Grade lawn areas to smooth, even surface with loose, uniformly fine texture. Roll and rake and remove ridges and fill depressions, as required to meet finish grades. Limit fine grading to areas which can be planted immediately after
- D. Moisten prepared lawn areas before planting if soil is dry. Water thoroughly and allow surface moisture to dry before planting lawns. Do not create a muddy soil
- E. Restore lawn areas to specified condition if eroded or otherwise disturbed after fine grading and prior to planting.

3.05 PREPARATION OF PLANTING BEDS

- A. Loosen subgrade of planting bed areas to a minimum depth of 12" using a cultimulcher or similar equipment Remove stones over 1 1/2" in any dimension, and sticks, stones, rubbish and other extraneous matter. Spread planting soil mixture to minimum depth required to meet lines, grades and elevations shown, after light rolling and natural settlement. Place approximately 1/2 of total amount of planting soil required. Work into top of loosened subgrade to create a transition layer, then place remainder of the planting soil. Add soil amendment.
- B. Excavation for Tress and Shrubs: Excavate pits, beds and trenched with vertical sides and with bottom of excavation slightly raised at center to provide proper drainage. Loosen hard subsoil in bottom of excavation.
- 1. For balled and burlapped (B & B trees and shrubs), make excavations at least half again as wide as the ball diameter and equal to the ball depth.
- 2. For container grown stocks, excavate as specified for balled and burlapped stock, adjusted to size of container width and depth.
- Dispose of subsoil removed from landscape excavations. Do not mix with planting soil or use as backfill. Fill excavations for trees and shrubs with water and allow to percolate out before planting.

3.06 PLANTING TREES, PALMS AND SHRUBS

- A. Lay out individual trees, palm and shrub locations and areas for multiple plantings where required. Stake locations and outline areas and secure Landscape Architect's acceptance before start of planting work. Make adjustments as may be required.
- B. Set balled and burlapped (B&B) stock on layer of compacted planting soil mixture, plumb and center of pit or trench with top of ball at same elevation as adjacent finished landscape grades. Remove burlap from sides of balls; retain on bottoms. When set, place additional backfill around base and sides of ball, and work each layer to settle backfill and eliminate voids and air pockets. When excavation is approximately 2/3 full, water thoroughly before placing remainder of backfill. Repeat watering until no more is absorbed. Water again after placing final layer

- C. Set container grown stock as specified for balled and burlapped stock, except cut cans on 2 sides with an approved can cutter; remove bottoms of wooden boxes after partial backfilling so as not to damage root balls.
- Dish top of backfill to allow for mulching. Mulch pits, trenches and planting areas. Provide not less than following thickness of mulch and work into top of backfill and finish level with adjacent finish grades: Provide 3" thickness of mulch.
- Guy and stake trees immediately after planting , as indicated.

- All pruning shall be done on the site before planting as directed by Landscape Architect. Pruning shall follow modern horticultural practices (Grades and Standards for Nursery Plants) and shall be done with approved tools designed for the purpose intended. Lopping, topping, or shearing of trees or shrubs will be grounds for rejecting the plants as unsuitable and not meeting requirements. Damaged, scarred, frayed, split, or skinned branches, limbs or roots shall be pruned back to line wood nearest to the next sound outside lateral bud, branch, limb or root. The terminal leader or bud in all trees or shrubs shall be left intact
- and not removed unless damaged. Prune, thin out and shape trees and shrubs. Prune trees to retain required height and spread. Unless otherwise directed by Landscape Architect, do not cut tree leaders, and remove only injured or dead branches from flowering trees, if any. Prune shrubs to retain natural character.

3.08 SODDING NEW LAWNS

- Lay sod within 24 hours from time of stripping. Lay sod to form a solid mass with tightly fitted joints. Butt ends and sides of sod strips; do not overlap. Stagger strips to offset joints in adjacent courses. Work from boards to avoid damage to subgrade or sod. Tamp or roll tightly to ensure contact with subgrade. Work sifted soil into minor cracks between pieces to sod;
- remove excess to avoid smothering of adjacent grass. C. Water sod thoroughly with a fine spray immediately after planting.

3.09 MAINTENANCE

- Begin maintenance immediately after planting.
- Maintain trees, palms, shrubs and other plants until final acceptance but in no case less than following period: 30 days after substantial completion of planting. C. Maintain trees, palms, shrubs and other plants by pruning, cultivating and weeding as required for healthy growth. Restore planting saucers. tighten and repair stake and guy supports and reset trees and shrubs to proper grades or

vertical position as required. Restore or replace damaged wrappings. Spray as

- required to keep trees and shrubs free of insects and diseases. Remove and replace excessively pruned or misformed stock resulting from
- Maintain lawns for not less than the period stated below, and longer as required to establish an acceptable lawn.
 - Sodded lawns, not less than 30 days after substantial completion. 2. Seeded lawns, not less than 60 days after substantial completion.
- F. Maintain lawns by watering fertilizing, weeding, mowing, trimming, and other operations such as rolling, regrading and replanting as required to establish a
- smooth, acceptable lawn, free of eroded or bare areas. Landscape Contractor is responsible for watering all sod and plant materials from day of installation through final acceptance even if irrigation is not in place, unless
- this responsibility is assumed in writing by another party. H. Landscape Contractor is to maintain the site weed—free untill acceptance by the Owner.

3.10 CLEANUP AND PROTECTION A. During landscape work, keep pavement clean and work area in an orderly

Protect landscape work and materials from damage due to landscape operations, operations by other contractors and trades and trespassers. Maintain protection during installation and maintenance periods. Treat, repair or replace damaged landscape work as directed.

3.11 INSPECTION AND ACCEPTANCE


- A. When landscape work is completed, including maintenance, Landscape Architect will, upon request, make an inspection to determine acceptability. Landscape work may be inspected for acceptance in parts agreeable to Landscape Architect, provided work offered for inspection is complete, including maintenance.
- Seeded lawns will be acceptable provided requirements, including maintenance, have been complied with, and healthy, uniform close stand of specified grass is established, free of weeds, bare spots and surface irregularities (95% coverage required for acceptance).
- Sodded lawns will be acceptable provided requirements, including maintenance, have been complied with, and healthy, well-rooted, even-colored, viable lawn is established, free of weeds, open joints and bare areas (95% coverage required for acceptance). Where inspected landscape work does not comply with requirements, replace rejected work and continue specified maintenance until reinspected by Landscape Architect and found to be acceptable. Remove rejected plants and materials promptly from project site.

- A. An automatic irrigation system providing 100% coverage with 50% overlap
- is to be provided. A rain sensor is required on all Irrigation Systems.
- C. Provide an as built drawing of the irrigation system to the Landscape Architect.

LANDSCAPE AND ROOT BARRIER NOTE:

Trees shown on this plan are for graphic reprsentation only. Tree spacing is based on design requirements and the trees shown on this plans attempt to accomplish that spacing while maintaining the required setbacks from utilities. Trees may be field adjusted to avoid conflicts with driveways and underground utilities. In any case the trees shall be located in the filed in accordance with the planting details shown hereon.

Additionally, trees are to be installed with a ten foot (10') separation from any water or sewer main and/or service, hydrants, and lift stations. If a ten foot (10') separation cannot be achieved, the tree can be installed with a root barrier system. Refer to the "Root Barrier" detail for installation requirements.

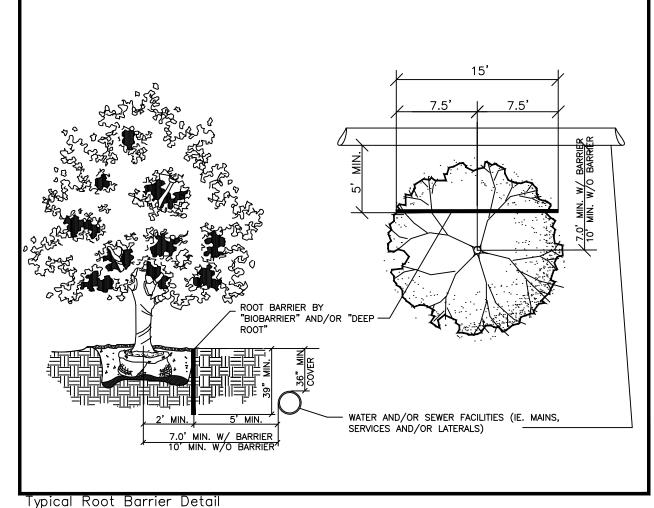

LANDSCAPE NOTES

EXHIBIT 'A'

June 15, 2016 CC Mtg

- 1. All proposed material shall be Florida No. 1 or better as set forth in "Grades & Standards for Nursery Plants," Florida Dept. of Agriculture. 2nd Edition 2/98.
- No deviations will be permitted. 2. By submitting a bid, the landscape contractor is responsible for providing the material
- specified on the plans. No substitutions will be accepted without prior written approval and acceptance by the Owner or his representative, or Landscape Architect.
- Materials to be hand-selected at the discretion of the Owner or his representative, or Landscape Architect.
- 4. All work shall proceed in a professional manner in accordance with standard nursery and installation practices.
- Quantities on plant list are for convenience only. Landscape Contractor is responsible for all plants shown on planting plans. When discrepancies occur between plant list and planting plans, the plans are to override the plant list in all
- to the Owner or his representative. Contractor is responsible for locating all underground utilities prior to digging. Notify the Owner or his representative, or the Landscape Architect immediately regarding discrepancies or conflicts.

cases. Contractor is responsible for confirming sod quantities and certifying such

- Landscape Contractor to notify the Owner or his representative, or Landscape
- Architect at least three (3) working days prior to beginning any stage of work. Owner or Landscape Architect to be immediately notified of any discrepancies
- 9. The Owner or his representative, or Landscape Architect reserve the right to field adjust plant material on-site to avoid conflicts or discrepancies not anticipated in the planning process.
- 10. Existing plant material to be removed, except as noted.


No double or multi-trunk trees unless otherwise specified.


- TREES & PALMS All trees, new and relocated, to be staked and guyed as detailed.
- Face of trees and palms to be located a minimum of 2'-0" off all sidewalks/bike paths or other paved surfaces, unless otherwise notated on plans.
- Root suckers on Live Oaks are not acceptable. All trees falling within grassed areas to have a 3" mulch ring with no more tḥan 1" of mulcḥ ḍirectly adgacent to the trunk of the tree. Min. 3' radius mulch
- PLANTING BEDS
- Groundcover and shrubs to be layed out in a uniform and consistent pattern.
- All planting beds to receive 3" deep shredded mulch per specifications. Landscape Contractor is responsible for verifying that clean top soil, meeting the attached specifications, exists in each planting bed prior to planting. Contractor shall add or amend top soil if necessary. Tree pits shall be backfilled as noted in attached specifications. Excavate all shrub and groundcover beds as specified and backfill with planting soil per specifications.
- All existing asphalt base material to be removed from planting areas and replaced with clean top soil prior to planting. Final grade within planting areas to be 2" below adjacent paved areas or top of curb.
- Landscape Contractor is responsible for replacing any damaged sod.

All sod areas to receive a 3" top dressing of soil per specifications.

1. All landscape areas (including sod) shall be irrigated with an underground automatic sprinkler system providing 100% coverage, and a rain sensor per attached plans. No landscape installation shall occur until the irrigation system is operational, unless approval is granted by Owner or his representative, or Landscape Architect.

DFTAILS

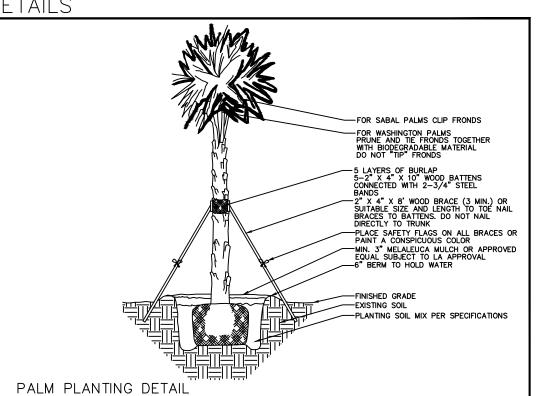

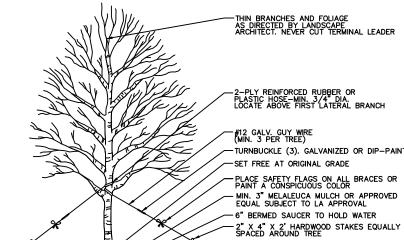


-#12 GALV. GUY WIRE (MIN. 3 PER TREE) TURNBUCKLE (3). GALVANIZED OR DIP-PAINTED SET FREE AT ORIGINAL GRADE PLACE SAFETY FLAGS ON ALL BRACES OR PAINT A CONSPICUOUS COLOR MIN. 3" MELALEUCA MULCH OR APPROVED EQUAL SUBJECT TO LA APPROVAL 6" BERMED SAUCER TO HOLD WATER

- REMOVE BURLAP FROM TOP 1/3 OF ROOT BALL

- MIN. 3" MELALEUCA MULCH OR APPROVED EQUAL SUBJECT TO LA APPROVAL - PLANT SO THAT ROOTBALL IS LEVEL WITH FINISHED GRADE - FINISH GRADE

NOTES:
1. DO NOT ALLOW AIR POCKETS TO FORM WHEN BACK FILLING
2. LEAVE 10" OF STAKE ABOVE GRADE FOR REMOVAL

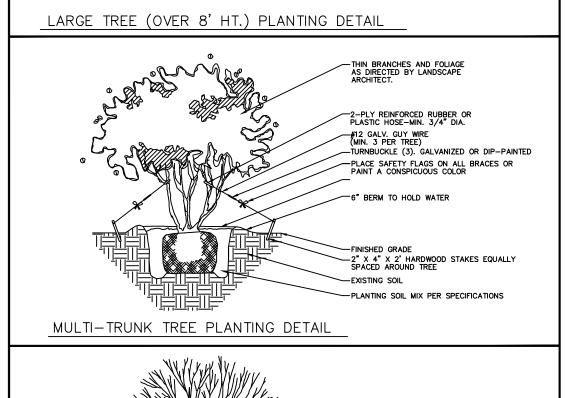

EXCAVATE SHRUB AND GROUND COVER
BEDS TO 24" DEPTH AND BACK FILL
WITH PLANTING SOIL.
SEE SPECIFICATIONS FOR PLANTING SOIL MIX.

HRUB AND GROUND COVER DETAIL

Jon E. Schmidt and Associates Landscape Architecture & Site Planning 2247 Palm Beach Lakes Blvd.- Suite 101 West Palm Beach, Florida 33409 Tel. (561) 684-6141 • Fax. (561) 684-6142 E-mail: Jschmidt@jesla.com Website: www.jesla.com License No.: LC26000232

5/21/14 'Date: 1" = 20'-0" Scale: Design By: JES BMCDrawn By: Checked By: 688.01 File No. 14-08 Job No.


TREVISIONS / SUBMISSIONS

09/30/14 Staff Comments

10/03/14 Fencing Revision 01/13/15 MYC Spec 10/14/15 FPL Pad/Easment Rev. 11/10/15 Entry Revisions

01/1<u>8/16 Alternative Plan Created</u> 03/17/16 Revise per Civil Plan 05/1<u>0/16 Submittal</u>


Phase 2B

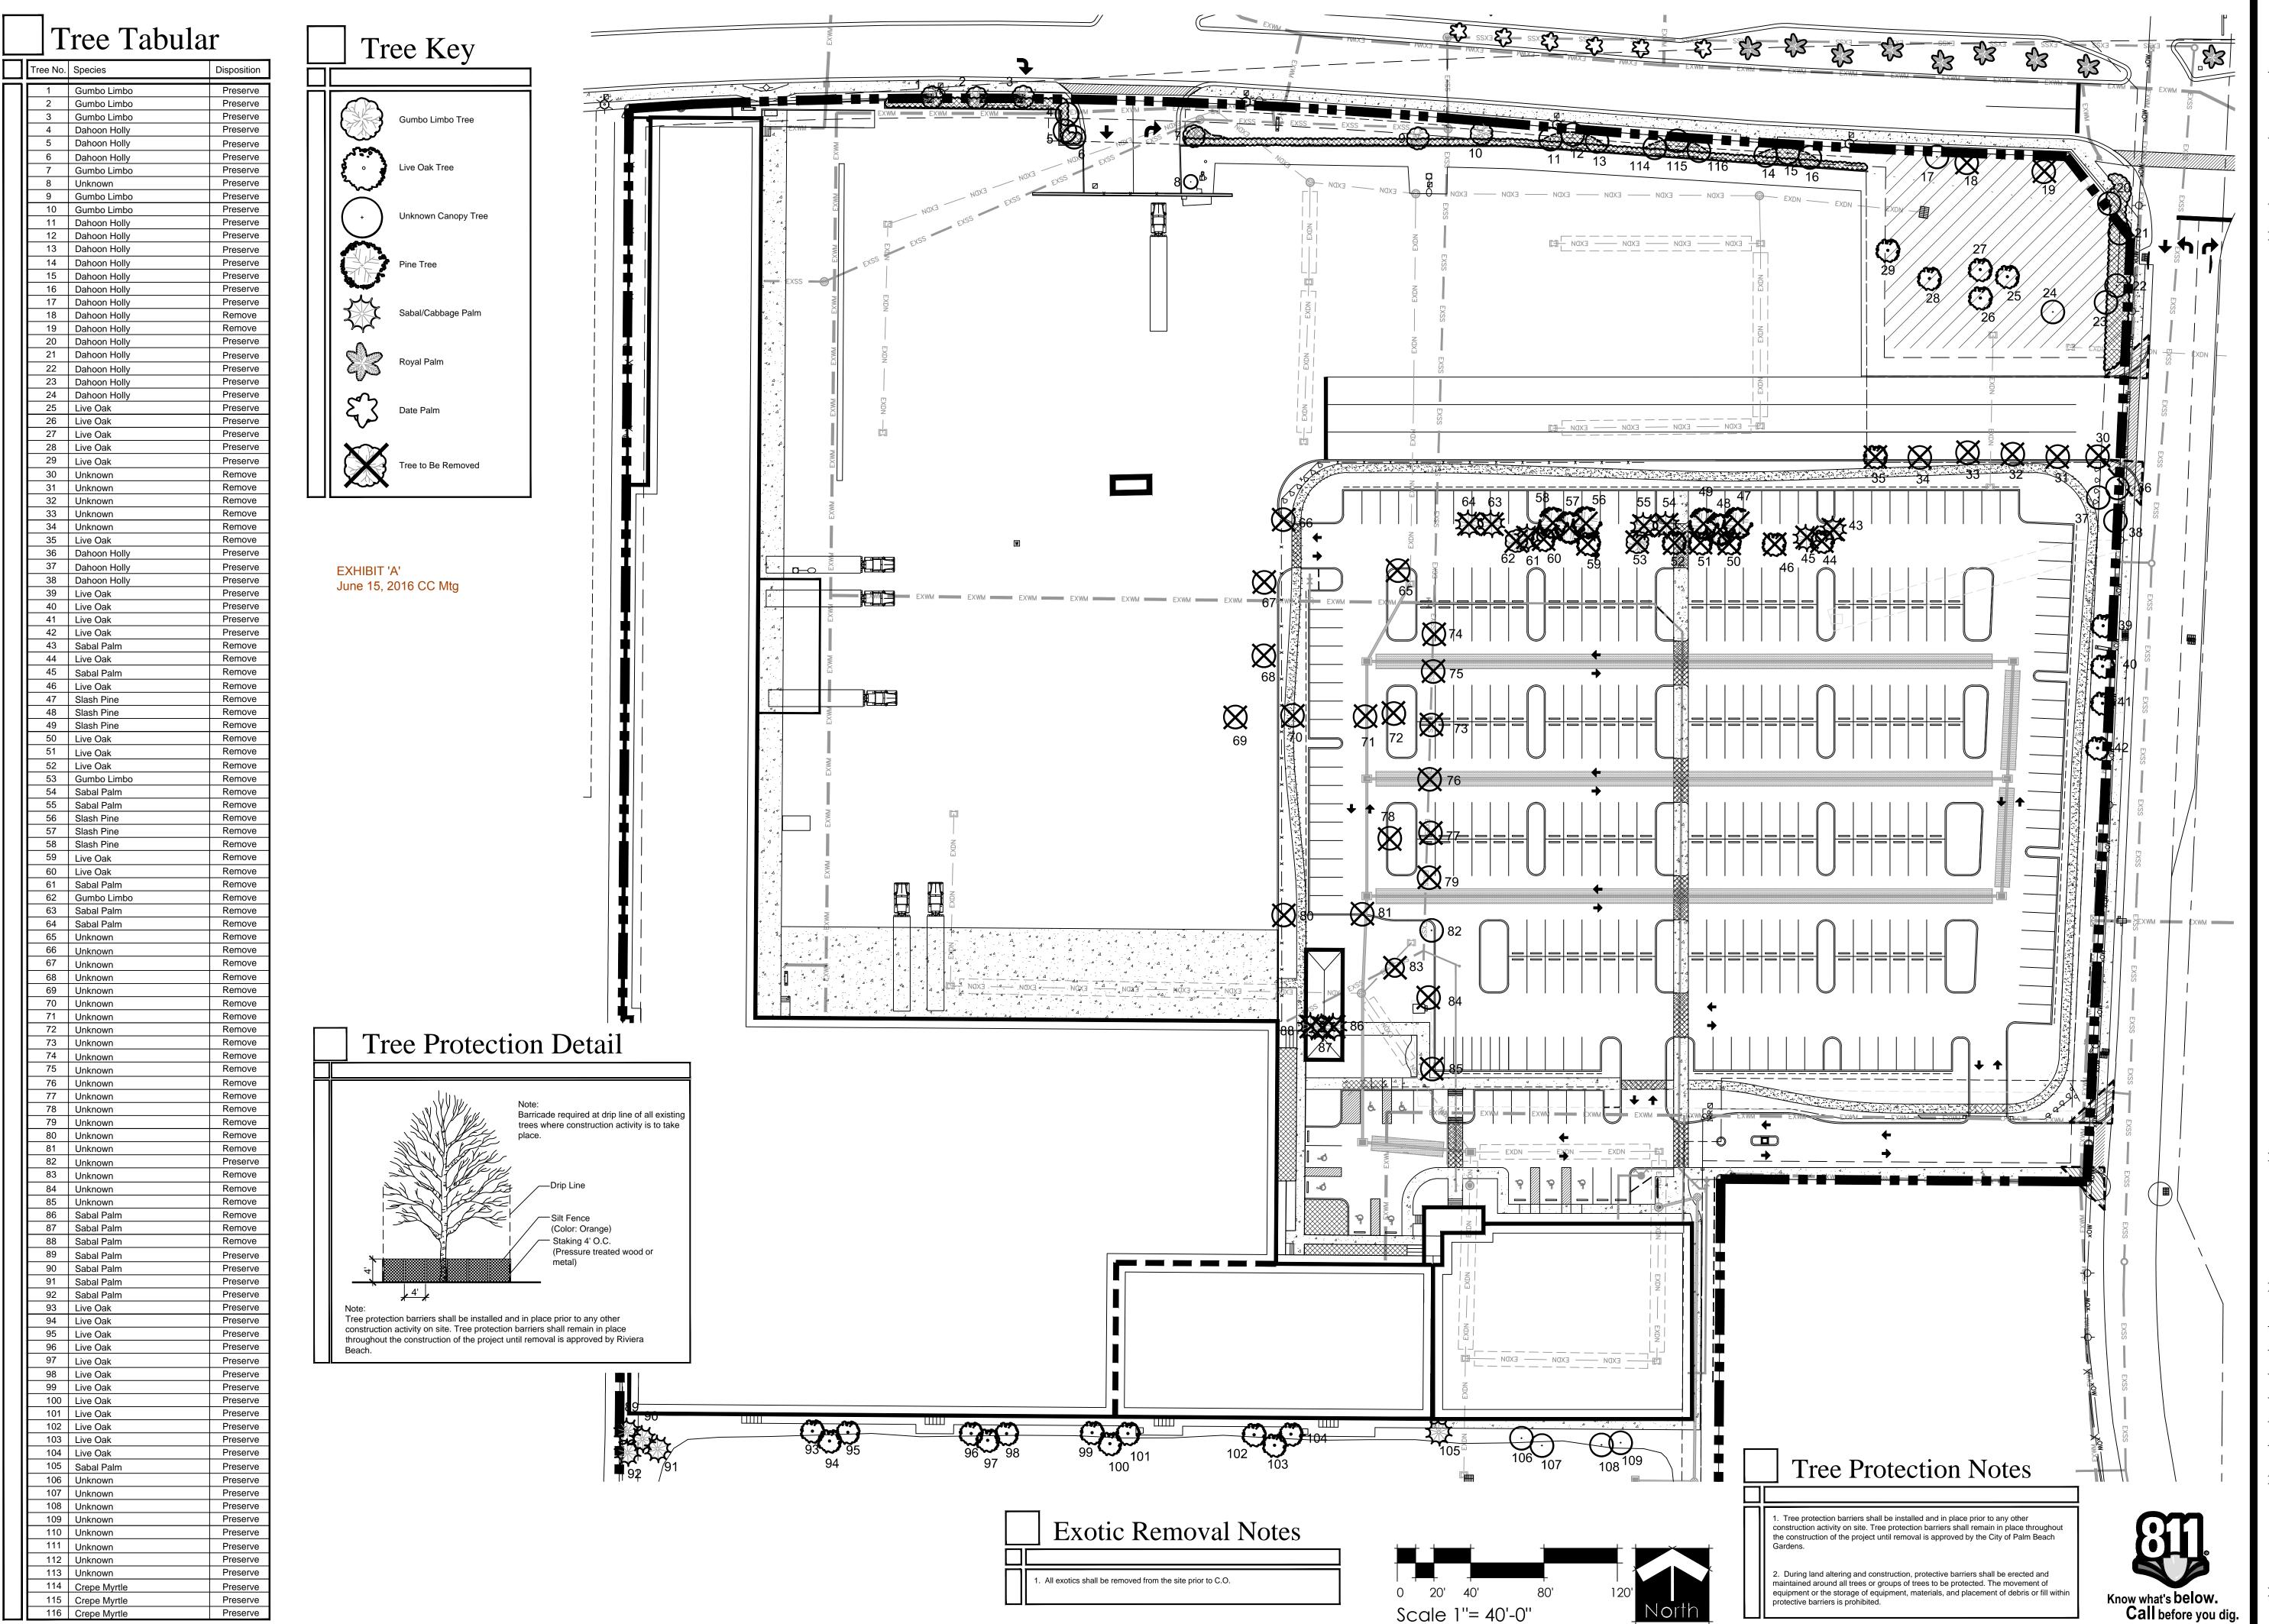

116 Crepe Myrtle

Preserve

Scale 1"= 40'-0"

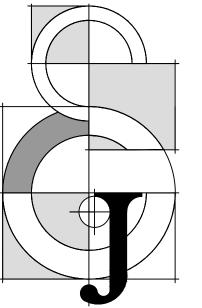

Jon E. Schmidt and Associates Landscape Architecture & Site Planning 2247 Palm Beach Lakes Blvd.- Suite 101 West Palm Beach, Florida 33409 Tel. (561) 684-6141 • Fax. (561) 684-6142 E-mail: Jschmidt@jesla.com Website: www.jesla.com License No.: LC26000232

ate:	09/26/14
cale:	1'' = 40'-0''
esign By:	JES
rawn By:	BMC
Checked By:	Jes
le No.	688.01
ob No.	14-08

revisions / submissions

10/03/14 Fencing Revision 10/14/15 FPL Pad/Easment Rev.

11/10/15 Entry Revisions

01/18/16 Alternative Plan Create

03/17/16 Revise per Civil Plan

05/10/16 Submittal

Tree Disposition Plan