



&ASSOCIATES 500 Australian Avenue South Suite 530 West Palm Beach, FL 33401 561.746.6900 www.chenmoore.com **CERTIFICATES OF AUTHORIZATION** EB4593 LC26000425

## REGISTRATION

SUB-CONSULTANT

SUZANNE DOMBROWSKI **REGISTRATION NO. PE-69918** DATE: \_\_\_\_\_

CATION NAME	RIVIERA BEACH HEIGHTS COMMUNITY CENTER
CATION #	SP-17-08
USE DESIGNATION	COMMUNITY FACILITY
IG DISTRICT	CF
ERTY CONTROL NUMBERS	56434233090000520
	56434233090000510
	56434233080000310
	COMMUNITY FACILITY
DN/TOWNSHIP/RANGE	32/42/43
/UNITY CENTER PARCEL AREA	15,000 SF
LOW PARKING LOT PARCEL AREA (SEE SHEET SP-2)	10,000 SF
- AREA	25,000 SF
COMMUNITY CENTER PARCEL	
BUILDING AREA	3,312 SF (22%)
IMPERVIOUS AREA	6,689 SF (45%)
PERVIOUS AREA	4,999 SF (33%)
COMMUNITY CENTER PARCEL AREA	15,000 SF
LOW PARKING LOT PARCEL (SEE SHEET SP-2)	
BUILDING AREA	0 SF (0%)
IMPERVIOUS AREA	5,810 SF (58%)
PERVIOUS AREA	4,190 SF (42%)
OVERFLOW PARKING LOT PARCEL AREA	10,000 SF
ING DATA	
EVENT SPACE	1,491 SF
OFFICE SPACE	348 SF
COMMON AREA	1,473 SF
TOTAL BUILDING AREA	3,312 SF
MAX. BUILDING HEIGHT	20'-6"
RED PARKING (1 SPACE PER 200 SF)	
TOTAL BUILDING AREA (3,312 SF)	16.56 PARKING SPACES = 17 REQUIRED
DSED PARKING (INCLUDING OVERFLOW PARKING AREA)	
STANDARD PARKING SPACES (10'X20')	25
ACCESSIBLE SPACES (12'X20')	2

ROPERTY	MAX. BUILDING AREA	IILDING AREA MIN. BUILDING SETBACKS						
SIZE	(% OF PARCEL)	FRONT	SIDE	STREET	REAR			
5,000 SF	35% MAX. (5,250 SF)	20'	7'	12'-6"	15'			
L5,000 SF	22% (3,312 SF)	13'	10'	92'	17'			



**PROJECT INFORMATION** 

## **RIVIERA BEACH** HEIGHTS COMMUNITY CENTER

## RIVIERA BEACH, FL PROJECT NUMBER 15.221.002

CLIENT PROJECT NUMBER

## VERIFY SCALES

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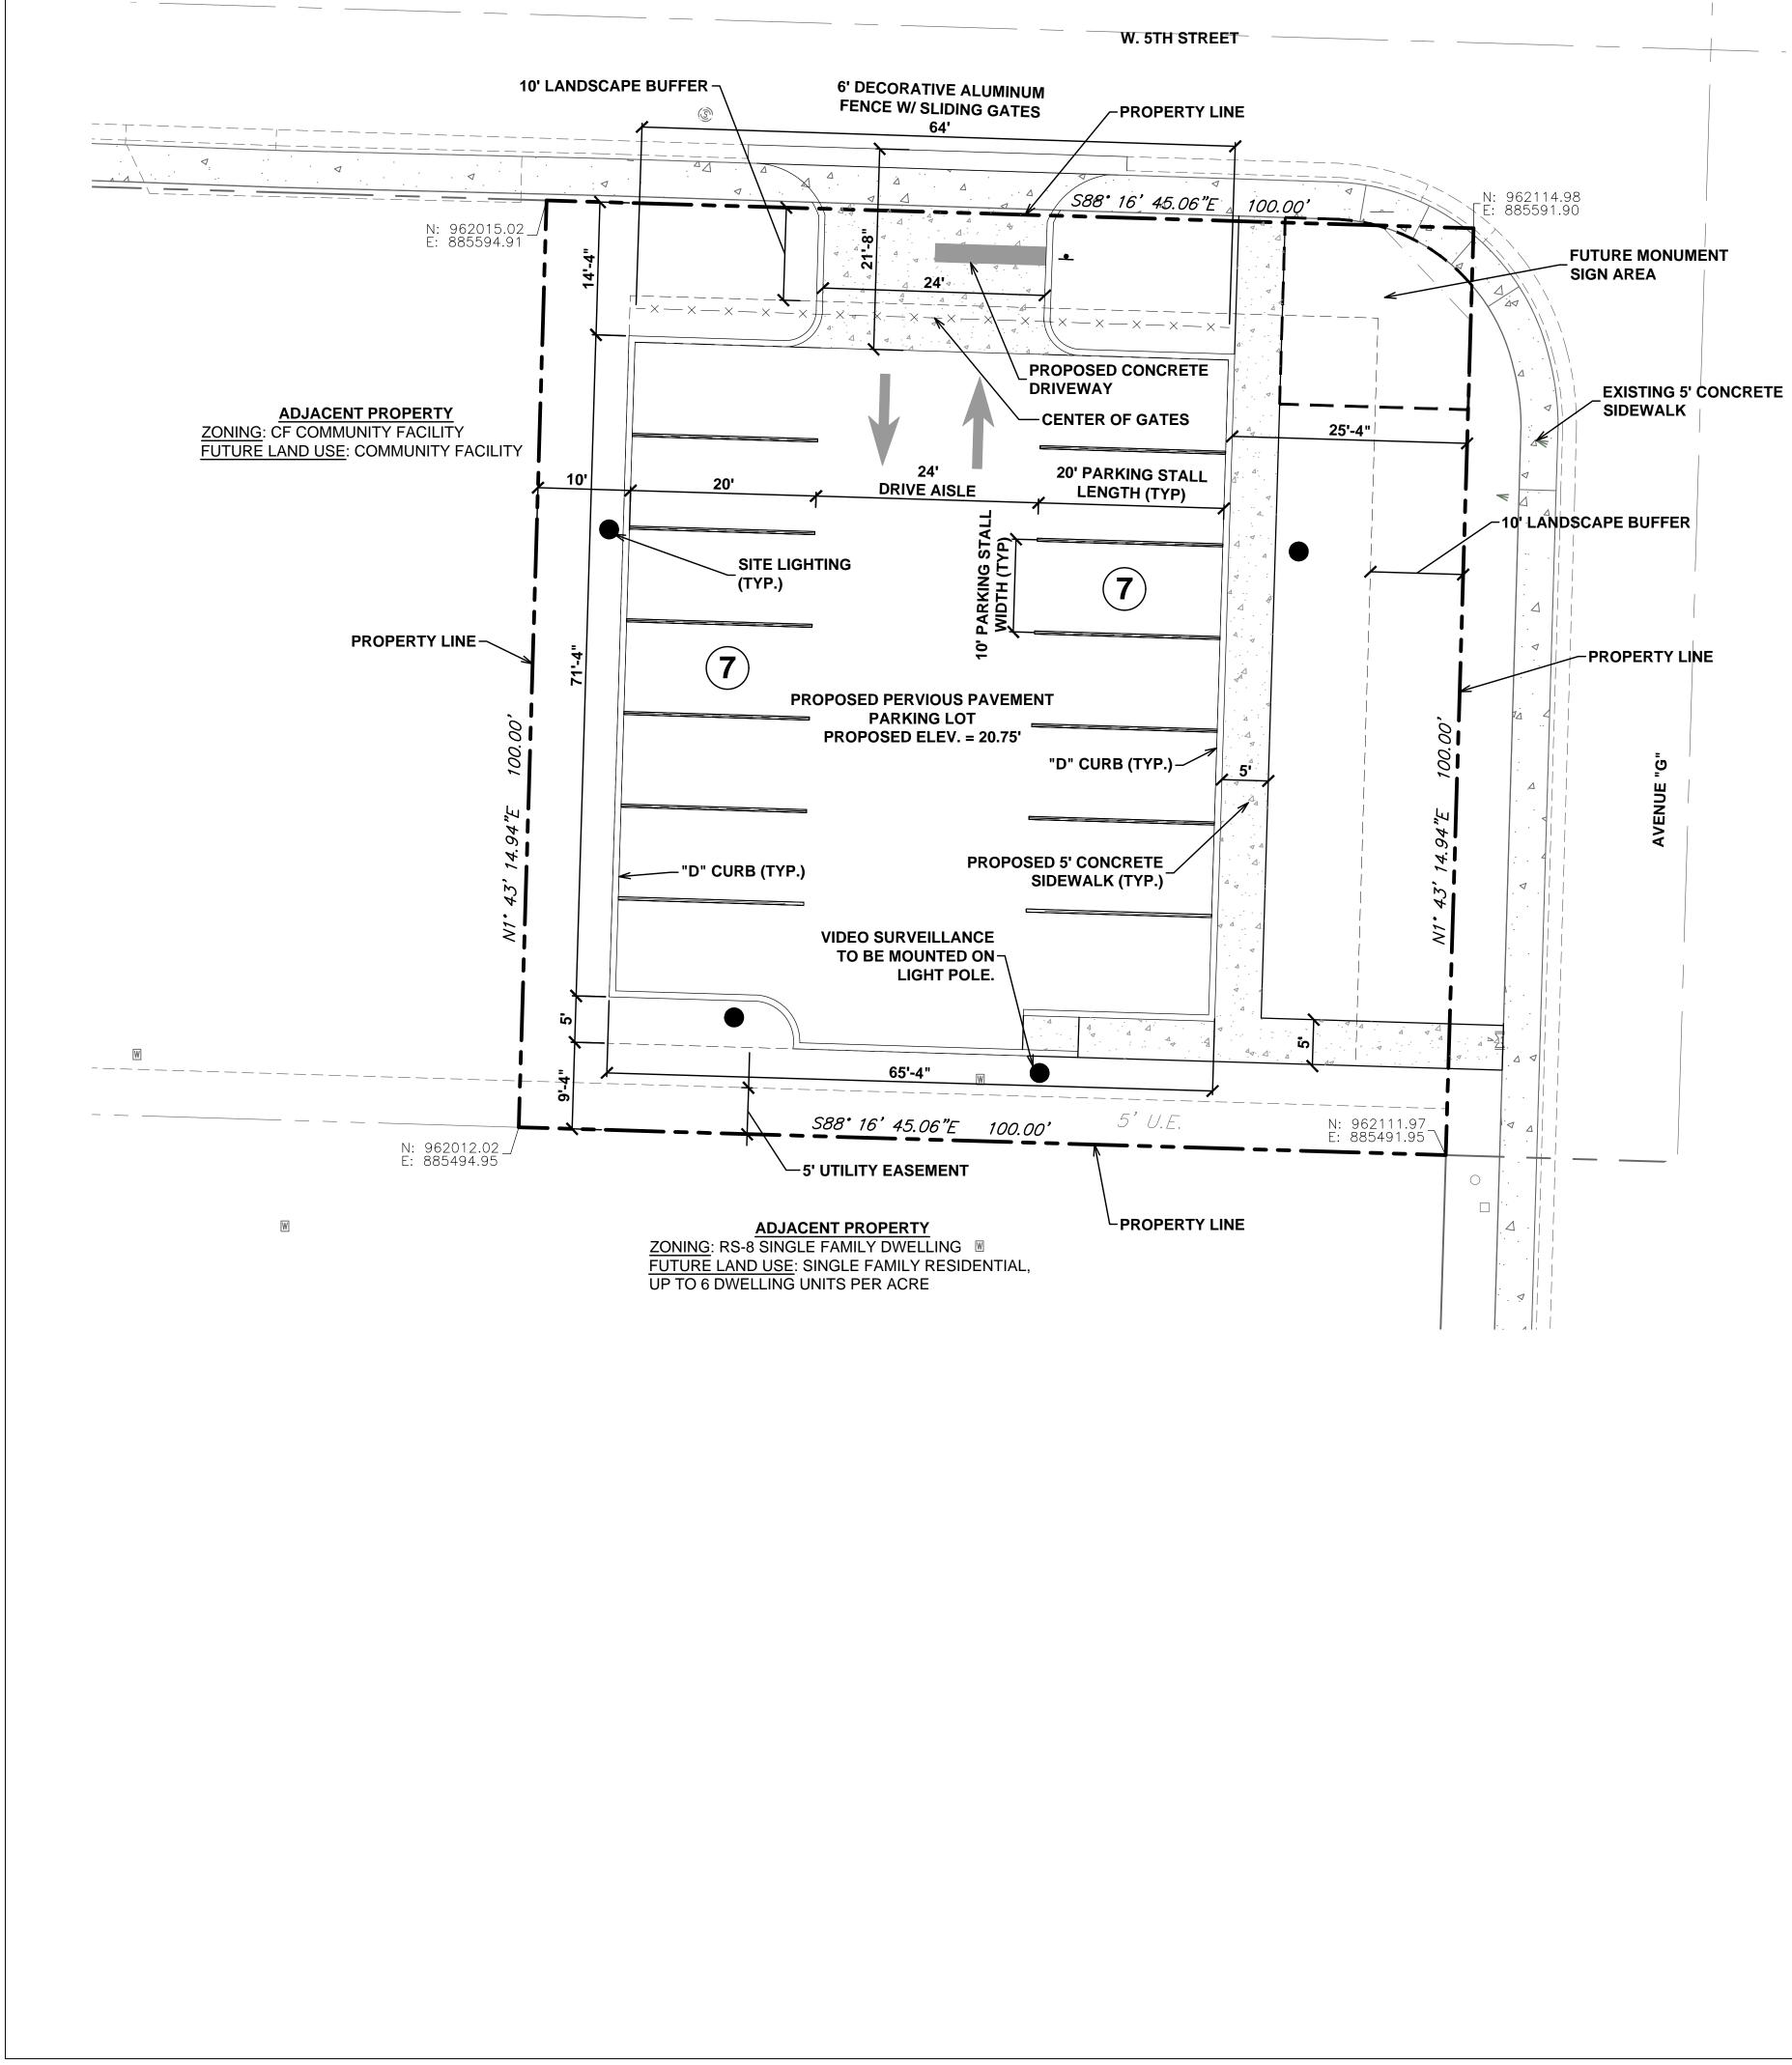
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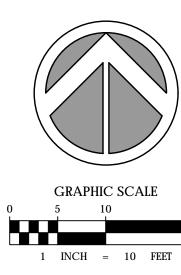
COMMUNITY

CENTER SITE PLAN

DRAWN BY



t Date: 12/21/2017 1:37:35 PM Username: asavage Layout Name: SP-2 der Path: V:\Projects\2015\15-221.002 - Riviera Beach Heights Community Center\Design\CAD\Plans\Administrative Approval Filename: Site Pl




APPLICATION NAME	RIVIERA BEACH HEIGHTS COMMUNITY CENTER			
APPLICATION #	SP-17-08			
LAND USE DESIGNATION	COMMUNITY FACILITY			
ZONING DISTRICT	CF			
PROPERTY CONTROL NUMBERS	56434233090000520			
	56434233090000510			
	56434233080000310			
USE	COMMUNITY FACILITY			
SECTION/TOWNSHIP/RANGE	32/42/43			
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BUILDING AREA	0 SF (0%)			
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BUILDING DATA				
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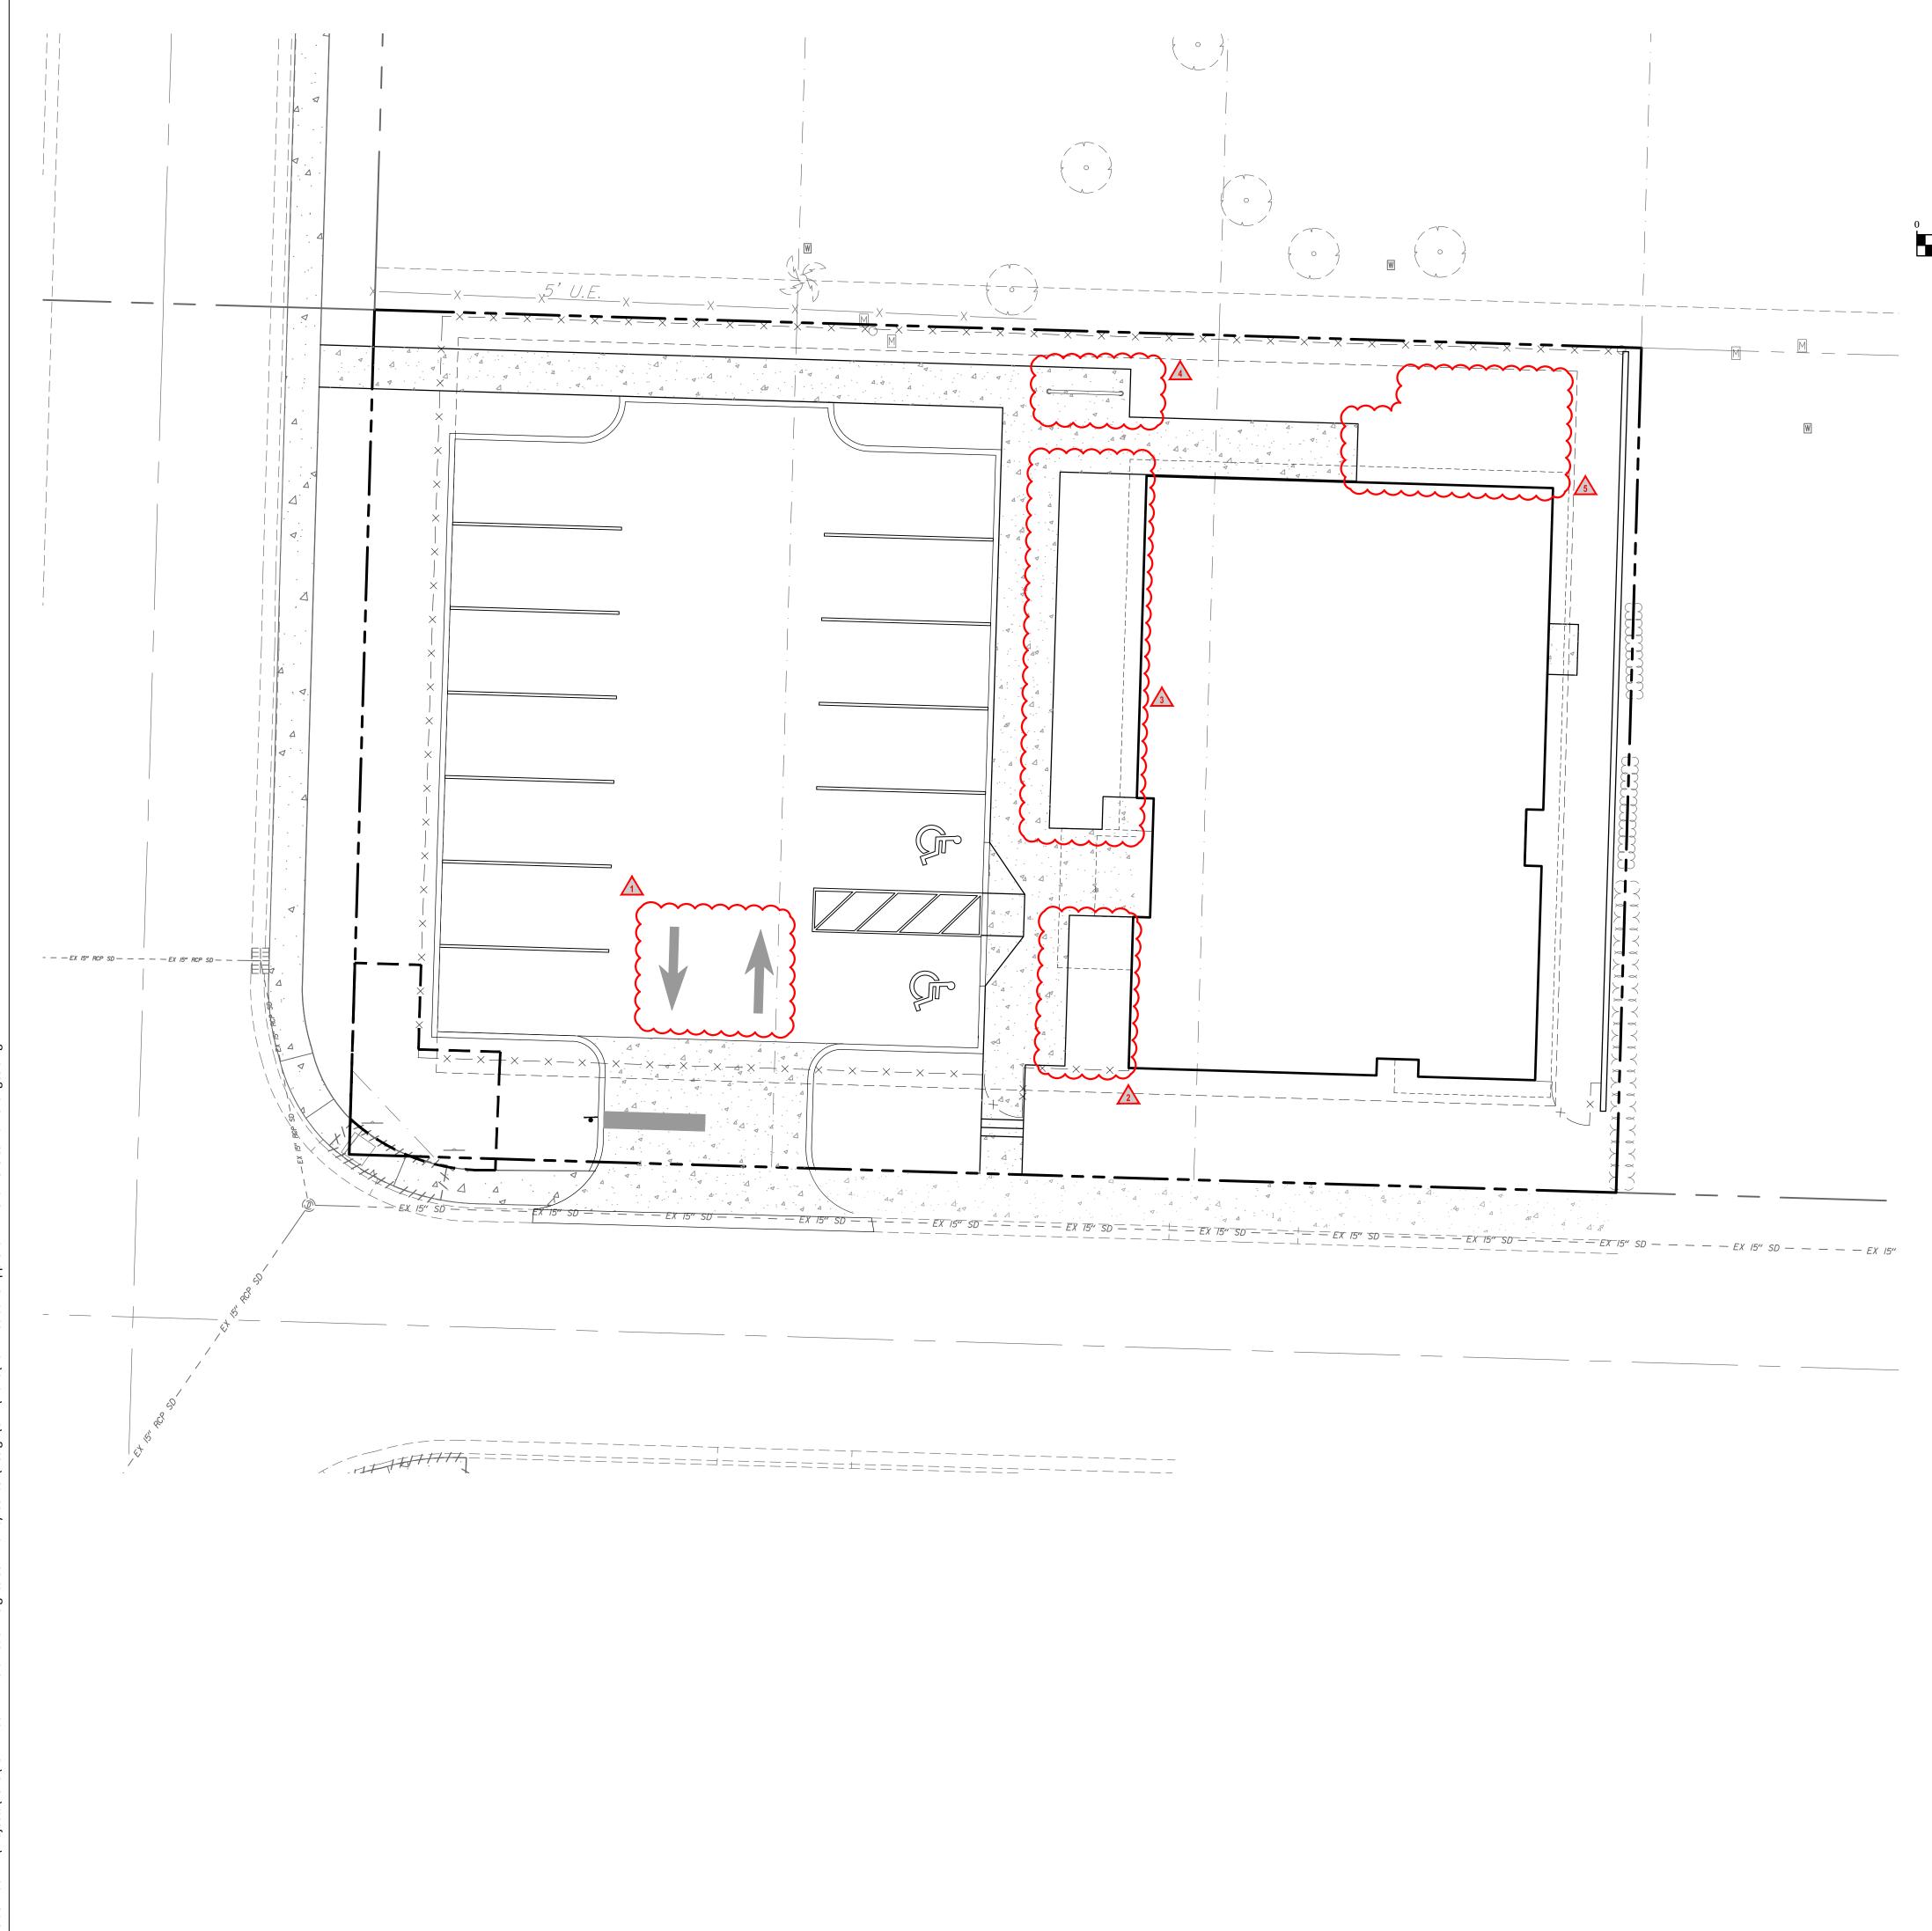
## PROPERTY DEVELOPMENT REGULATIONS


ZONING DISTRICT	PROPERTY	MAX. BUILDING AREA	М	IN. BUILDI	NG SETBACK	S
	SIZE	(% OF PARCEL)	FRONT	SIDE	STREET	REAR
CF-REQUIRED	5,000 SF	35% MAX. (5,250 SF)	20'	7'	12'-6"	15'
CF-PROPOSED	10,000 SF	0% (0 SF)	13'	10'	92'	17'

## LOCATION MAP





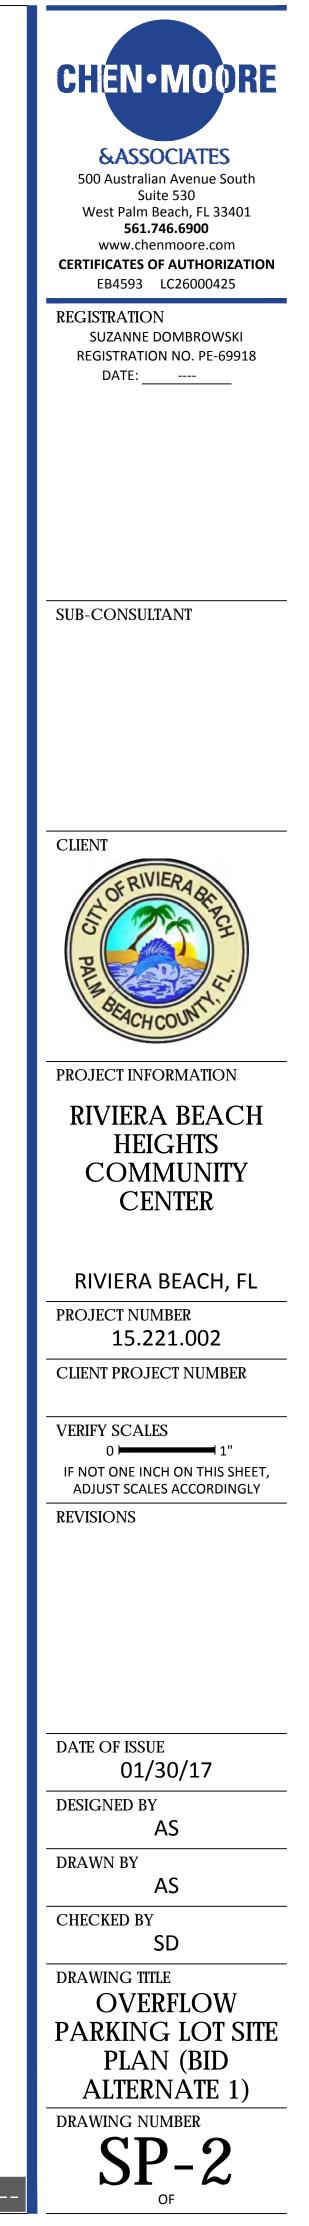

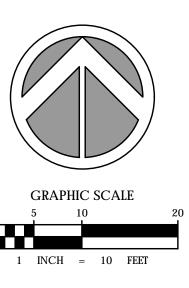

## LOCATION MAP





AREAS WITH SITE PLAN CHANGES

## SITE PLAN CHANGES



BUILDING SIZE REDUCTION BUILDING SIZE REDUCTION, REMOVAL OF FRONT PATIO, AND SIDEWALK RECONFIGURATION BIKE RACK LOCATION CHANGE AND SIDEWALK RECONFIGURATION BUILDING SIZE REDUCTION AND SIDEWALK RECONFIGURATION

ADDITION OF DIRECTIONAL ARROW PAVEMENT MARKINGS



&ASSOCIATES

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REGISTRATION SUZANNE DOMBROWSKI **REGISTRATION NO. PE-69918** DATE: \_\_\_\_\_ SUB-CONSULTANT CLIENT PROJECT INFORMATION **RIVIERA BEACH** HEIGHTS COMMUNITY CENTER RIVIERA BEACH, FL PROJECT NUMBER 15.221.002 CLIENT PROJECT NUMBER VERIFY SCALES

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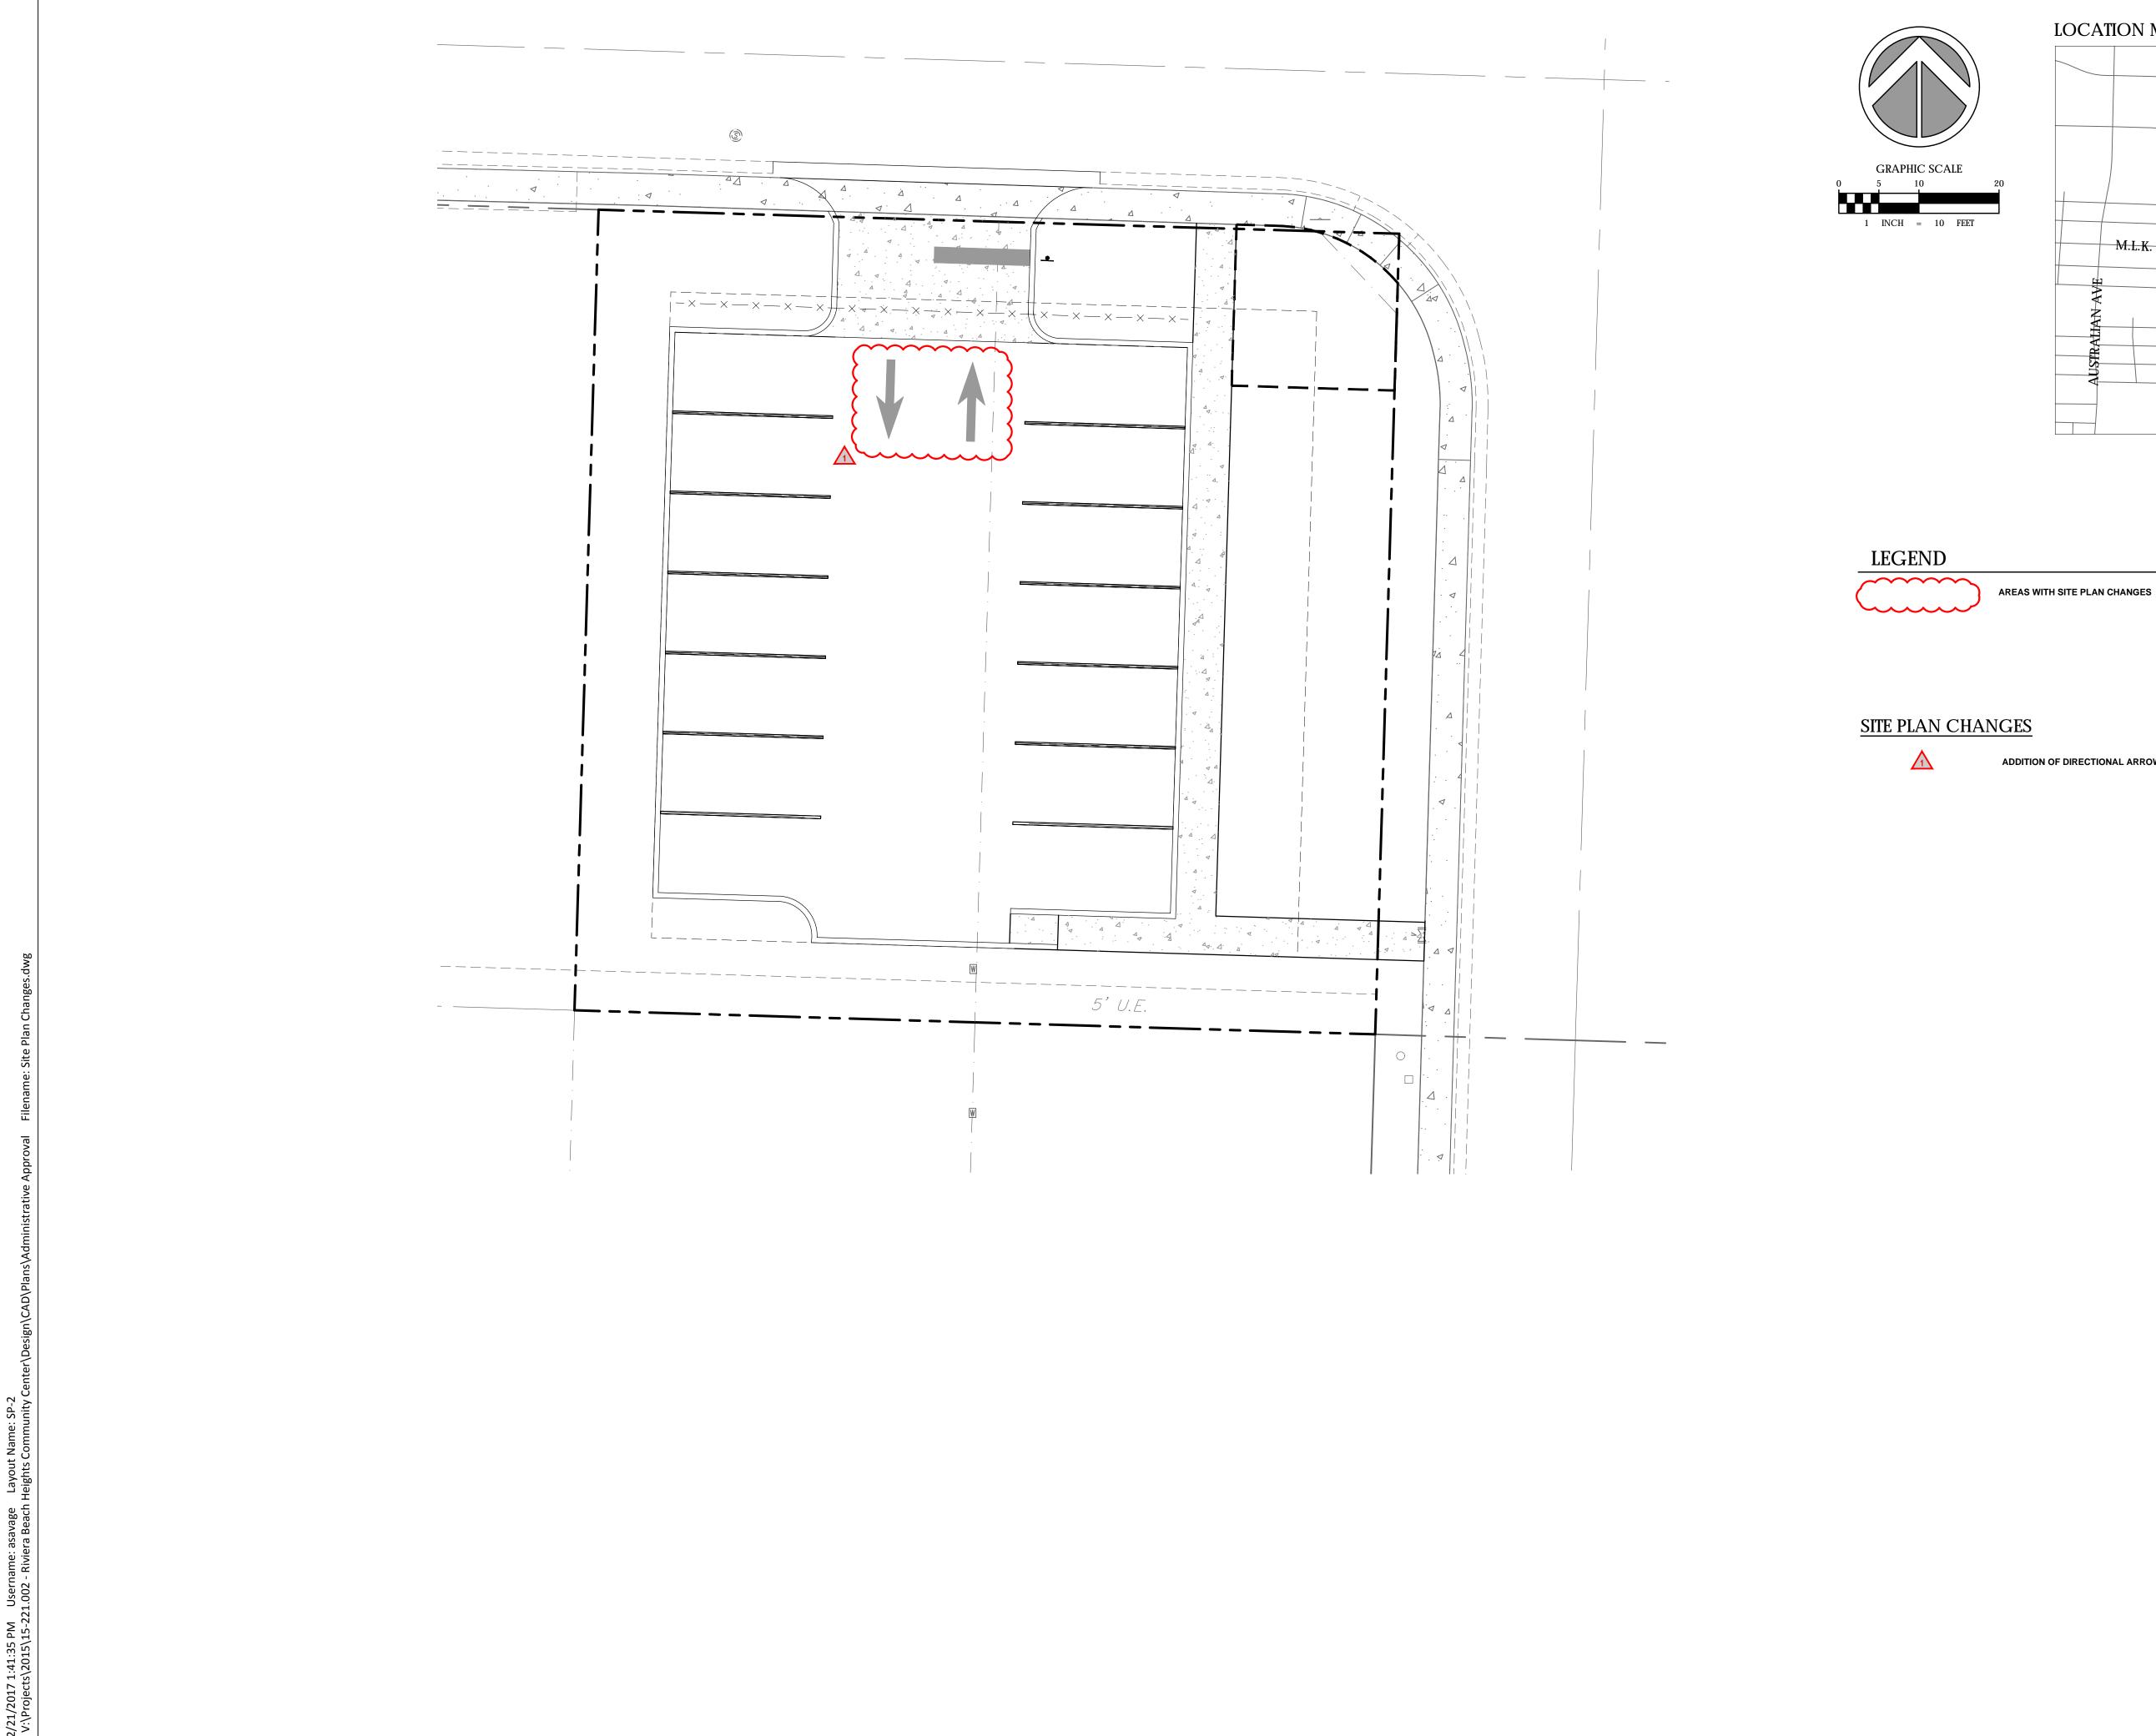
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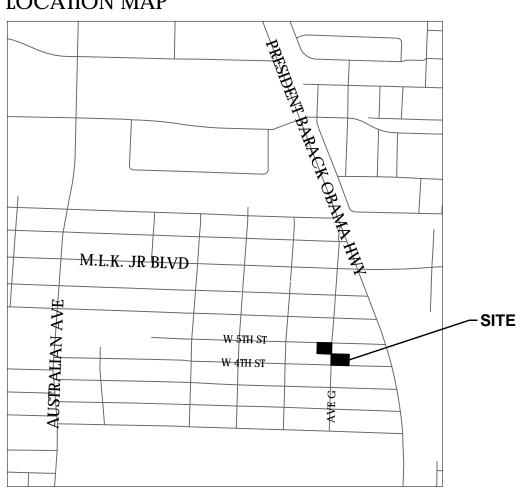
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COMMUNITY **CENTER SITE PLAN** 



Date: er Pat

## LOCATION MAP



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REGISTRATION SUZANNE DOMBROWSKI **REGISTRATION NO. PE-69918** DATE: \_\_\_\_\_

SUB-CONSULTANT

ADDITION OF DIRECTIONAL ARROW PAVEMENT MARKINGS

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RIVIERA BEACH, FL PROJECT NUMBER

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OVERFLOW

PARKING LOT SITE

PLAN (BID

ALTERNATE 1)

**SP-2** 

OF


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## SITE LANDSCAPE DATA TABLE: COMMUNITY CENTER


LAND USE CATEGORY: RS-8 SINGLE FAMILY DWELLING							
CODE APPLICATION	#	REQUIRED	PROVIDED	EXISTING	RELOCATED	PROPOSED	TREE VALADATION/LOCATION
SEC. 31-609 DEVELOPMENT LANDSCAPE REQUIREMENTS		•			•	-	
1 TREE PER 1,500 SF	15,000	10	21	х	x	21	(5) SILVER BUTTONWOOD, SPECICES SELECTED DUE TO PROXIMITY OF OVERHEAD UTILITY LINES. (2) LIVE OAKS, (14) CABBAGE PALMS, SPECIES SELECTED DUE TO PROXIMITY OF OVERHEAD UTILITY LINES
MIN. 20% OF DEVELOPED SITE SHALL BE LANDSCAPED		3,000	4,282				73% SHRUBS/ GROUNDCOVERS AND 27% BAHIA TURF
SEC. 31-610 PARKING AREAS FOR NONRESIDENTIAL DEVELOPMEN	TS	•	-		•		
AVENUE G: MIN. 10' BUFFER W/ 1 TREE PER 20 LF	100	5	5	х	x	5	PROPOSED TREES: (2) SILVER BUTTONWOOD, (2) LIVE OAK, (1) CABBAGE PALM. BUFFER TREES ARE COUNTED TOWARDS THE REQUIRERMENTS OF 1 TREE PER 1,500 SF.
CONTINUOUS HEDGE		CONTINUOUS HEDGE	CONTINUOUS HEDGE	Х	х	CONTINUOUS HEDGE	
WEST 4TH STREET: MIN. 10' BUFFER W/ 1 TREE PER 20 LF	80	4	8	х	x	8	PROPOSED TREES: (3) SILVER BUTTONWOOD, (5) CABBAGE PALM. BUFFER TREES ARE COUNTED TOWARDS THE REQUIRERMENTS OF 1 TREE PER 1,500 SF
CONTINUOUS HEDGE		CONTINUOUS HEDGE	CONTINUOUS HEDGE	х	х	CONTINUOUS HEDGE	

MON NAME	BOTANICAL NAME	CONT	SIZE	NATIVE	
Buttonwood	Conocarpus erectus `Sericeus`	F.G.	12` OAH, 2" DBH MIN.	Yes	
Side Live Oak	Quercus virginiana `Park Side` TM	F.G.	14` HT, 5` SPRD, 4" DBH	Yes	
page Palmetto	Sabal palmetto	F.G.	10`,14`, 18` CT., Stag. Ht.	Yes	
MON NAME	BOTANICAL NAME	CONT	<u>SIZE</u>	<u>NATIVE</u>	<u>SPACING</u>
o Plum o ground, Min. 24" sprd.	Chrysobalanus icaco	7 gal	Min. 36" ht x 24" sprd.	Yes	24" o.c.
MON NAME	BOTANICAL NAME	CONT	SIZE	<u>NATIVE</u>	<u>SPACING</u>
ed Bulbine	Bulbine frutescens	1 gal.	MIN 12" FULL	No	18" o.c.
Muhly	Muhlenbergia capillaris	3 gal.	MIN. 24" HT.	Yes	30" o.c.
ntie	Zamia pumila	3 gal.	14" HT, 14" SPRD	Yes	30" o.c.
MON NAME	BOTANICAL NAME	CONT	SIZE	<u>NATIVE</u>	
n Grass	Paspalum notatum	Solid Sod	FULL	No	

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REGISTRATION CRISTOBAL BETANCOURT **REGISTRATION NO. LA6666941** DATE: ----

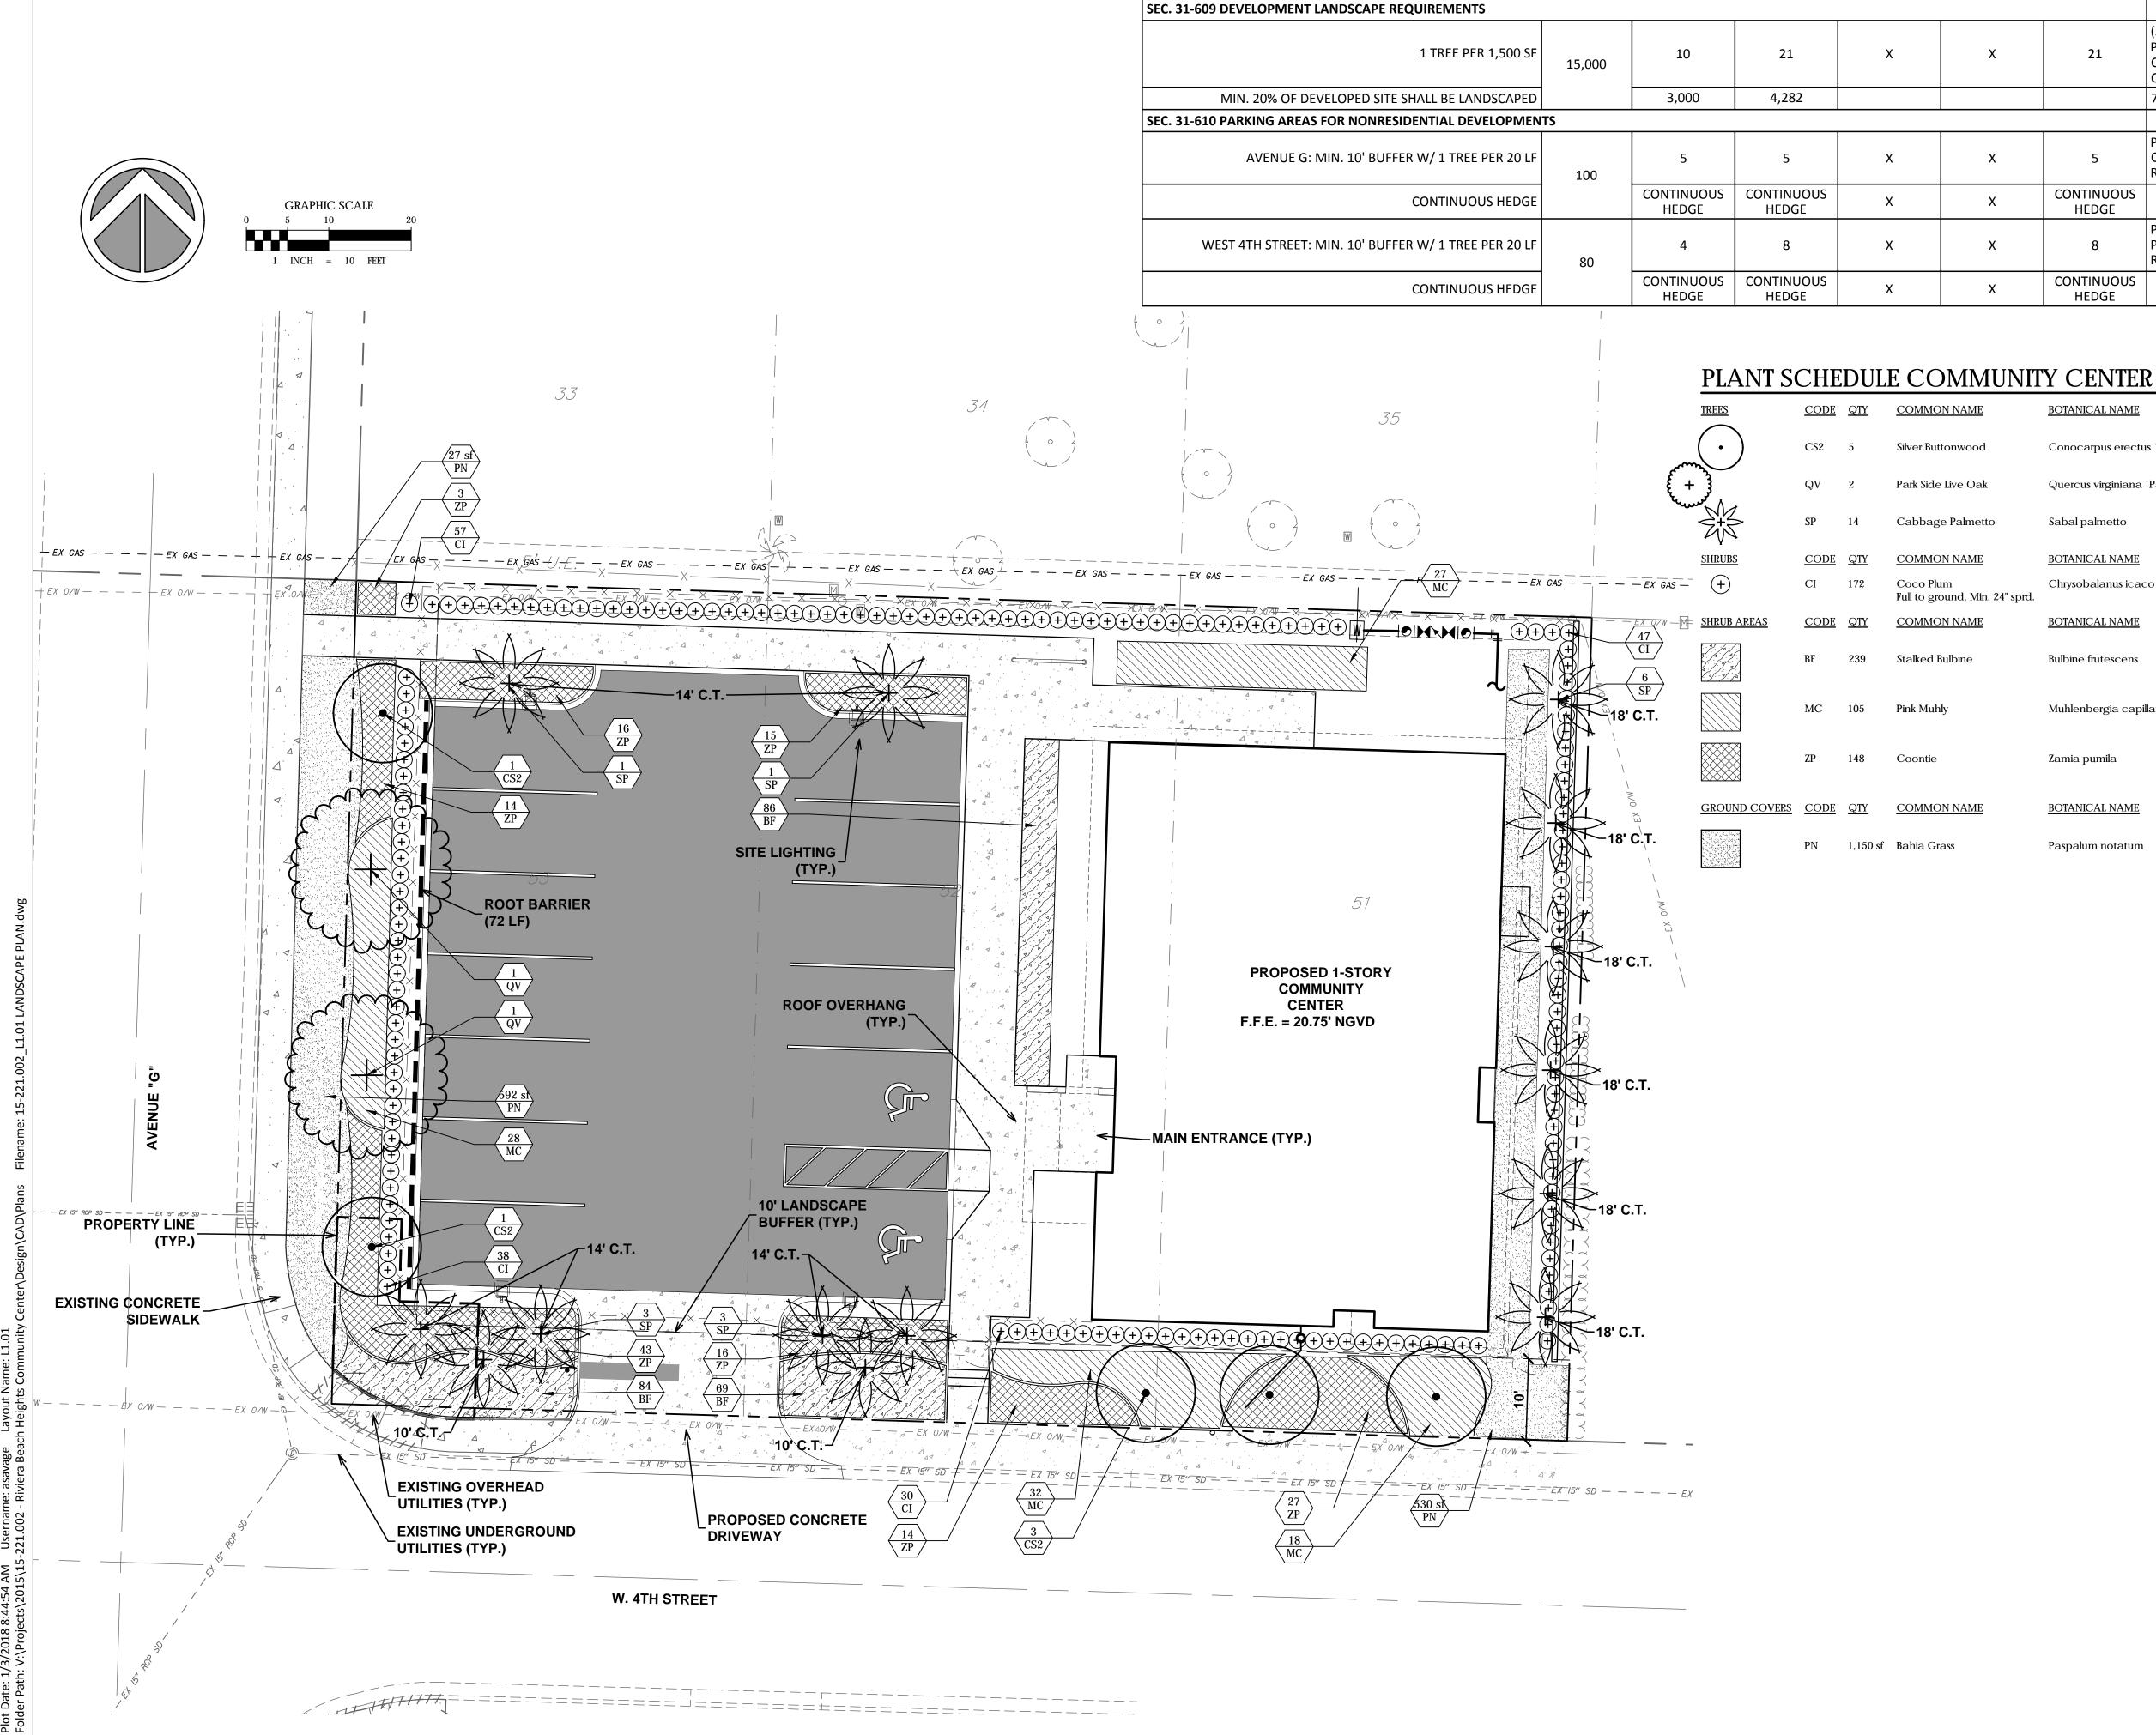

SUB-CONSULTANT

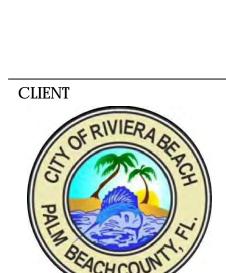PROJECT INFORMATION



RIVIERA BEACH, FL PROJECT NUMBER 15.221.002

CLIENT PROJECT NUMBER

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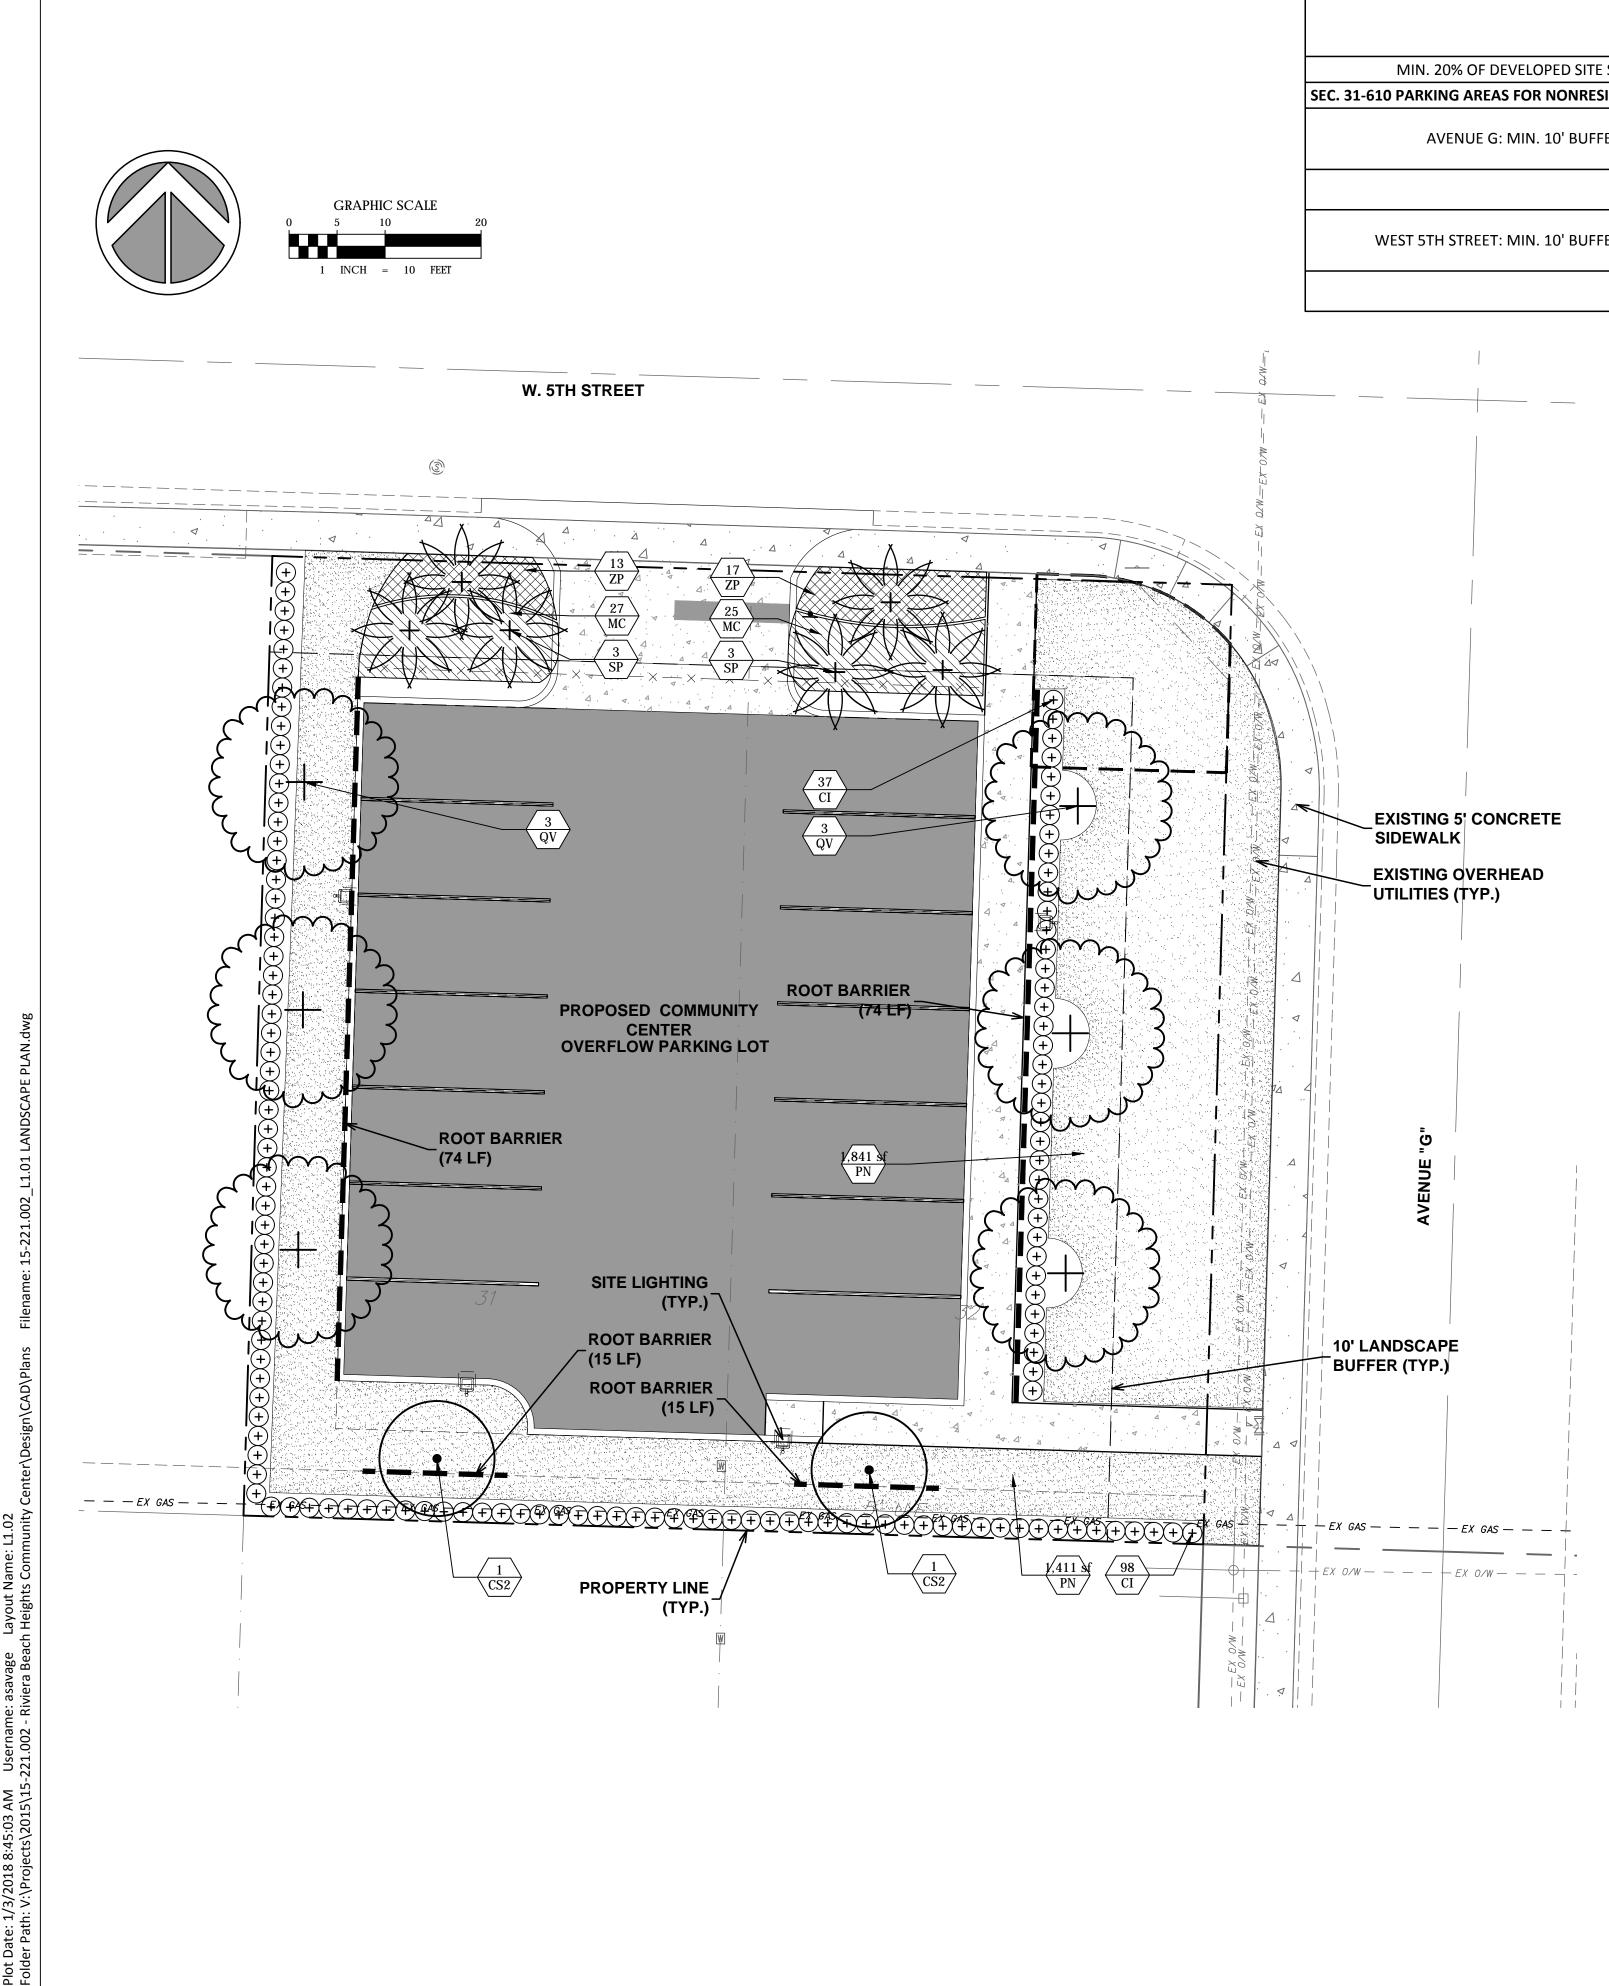
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CENTER LANDSCAPE PLAN DRAWING NUMBER



## SITE LANDSCAPE DATA TABLE: OVERFLOW PARKING LOT

LAND USE CATEGORY: RS-8 SINGLE FAMILY DWELLING								
CODE APPLICATION	#	REQUIRED	PROVIDED	EXISTING	RELOCATED	PROPOSED	TREE VALADATION/LOCATION	
SEC. 31-609 DEVELOPMENT LANDSCAPE REQUIREMENTS	SEC. 31-609 DEVELOPMENT LANDSCAPE REQUIREMENTS							
1 TREE PER 1,500 SF	10,000	7	14	х	x	14	(2) SILVER BUTTONWOOD, SPECIES SELECTED DUE TO PROXIMITY OF OVERHEAD UTILITY LINES. (6) LIVE OAKS, (6) CABBAGE PALMS,	
MIN. 20% OF DEVELOPED SITE SHALL BE LANDSCAPED		2,000	4,290				28% SHRUBS/ GROUNDCOVERS AND 72% BAHIA TURF	
SEC. 31-610 PARKING AREAS FOR NONRESIDENTIAL DEVELOPMEN								
AVENUE G: MIN. 10' BUFFER W/ 1 TREE PER 20 LF	75	4	4	х	x	4	PROPOSED TREES: (1) SILVER BUTTONWOOD, (3) LIVE OAK. BUFFER TREES ARE COUNTED TOWARDS THE REQUIRERMENTS OF 1 TREE PER 1,500 SF	
CONTINUOUS HEDGE		CONTINUOUS HEDGE	CONTINUOUS HEDGE	х	x	CONTINUOUS HEDGE		
WEST 5TH STREET: MIN. 10' BUFFER W/ 1 TREE PER 20 LF	65	4	7	х	x	7	PROPOSED TREES: (1) LIVE OAK, (6) CABBAGE PALM. BUFFER TREES ARE COUNTED TOWARDS THE REQUIRERMENTS OF 1 TREE PER 1,500 SF	
CONTINUOUS HEDGE		CONTINUOUS HEDGE	CONTINUOUS HEDGE	х	х	CONTINUOUS HEDGE		

## PLANT SCHEDULE OVERFLOW PARKING

	TREES	<u>CODE</u>	QTY	COMMON NAME	BOTANICAL NAME	CONT	SIZE	<u>NATIVE</u>	
~~~~	$(\cdot)$	CS2	2	Silver Buttonwood	Conocarpus erectus `Sericeus`	F.G.	12` OAH, 2" DBH MIN.	Yes	
٤ +		QV	6	Park Side Live Oak	Quercus virginiana `Park Side` TM	F.G.	14` HT, 5` SPRD, 4" DBH	Yes	
لاس		SP	6	Cabbage Palmetto	Sabal palmetto	F.G.	10`,14`, 18` CT., Stag. Ht.	Yes	
	<u>SHRUBS</u>	<u>CODE</u>	QTY	COMMON NAME	BOTANICAL NAME	CONT	<u>SIZE</u>	<u>NATIVE</u>	<u>SPACING</u>
	(+)	CI	135	Coco Plum Full to ground, Min. 24" sprd.	Chrysobalanus icaco	7 gal	Min. 36" ht x 24" sprd.	Yes	24" o.c.
	SHRUB AREAS	CODE	QTY	COMMON NAME	BOTANICAL NAME	CONT	SIZE	NATIVE	<u>SPACING</u>
		MC	52	Pink Muhly	Muhlenbergia capillaris	3 gal.	MIN. 24" HT.	Yes	30" o.c.
		ZP	30	Coontie	Zamia pumila	3 gal.	14" HT, 14" SPRD	Yes	30" o.c.
	GROUND COVERS	<u>CODE</u>	QTY	COMMON NAME	BOTANICAL NAME	CONT	SIZE	NATIVE	
		PN	3,252 sf	Bahia Grass	Paspalum notatum	Solid Sod	FULL	No	

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REGISTRATION CRISTOBAL BETANCOURT REGISTRATION NO. LA6666941 DATE: ----

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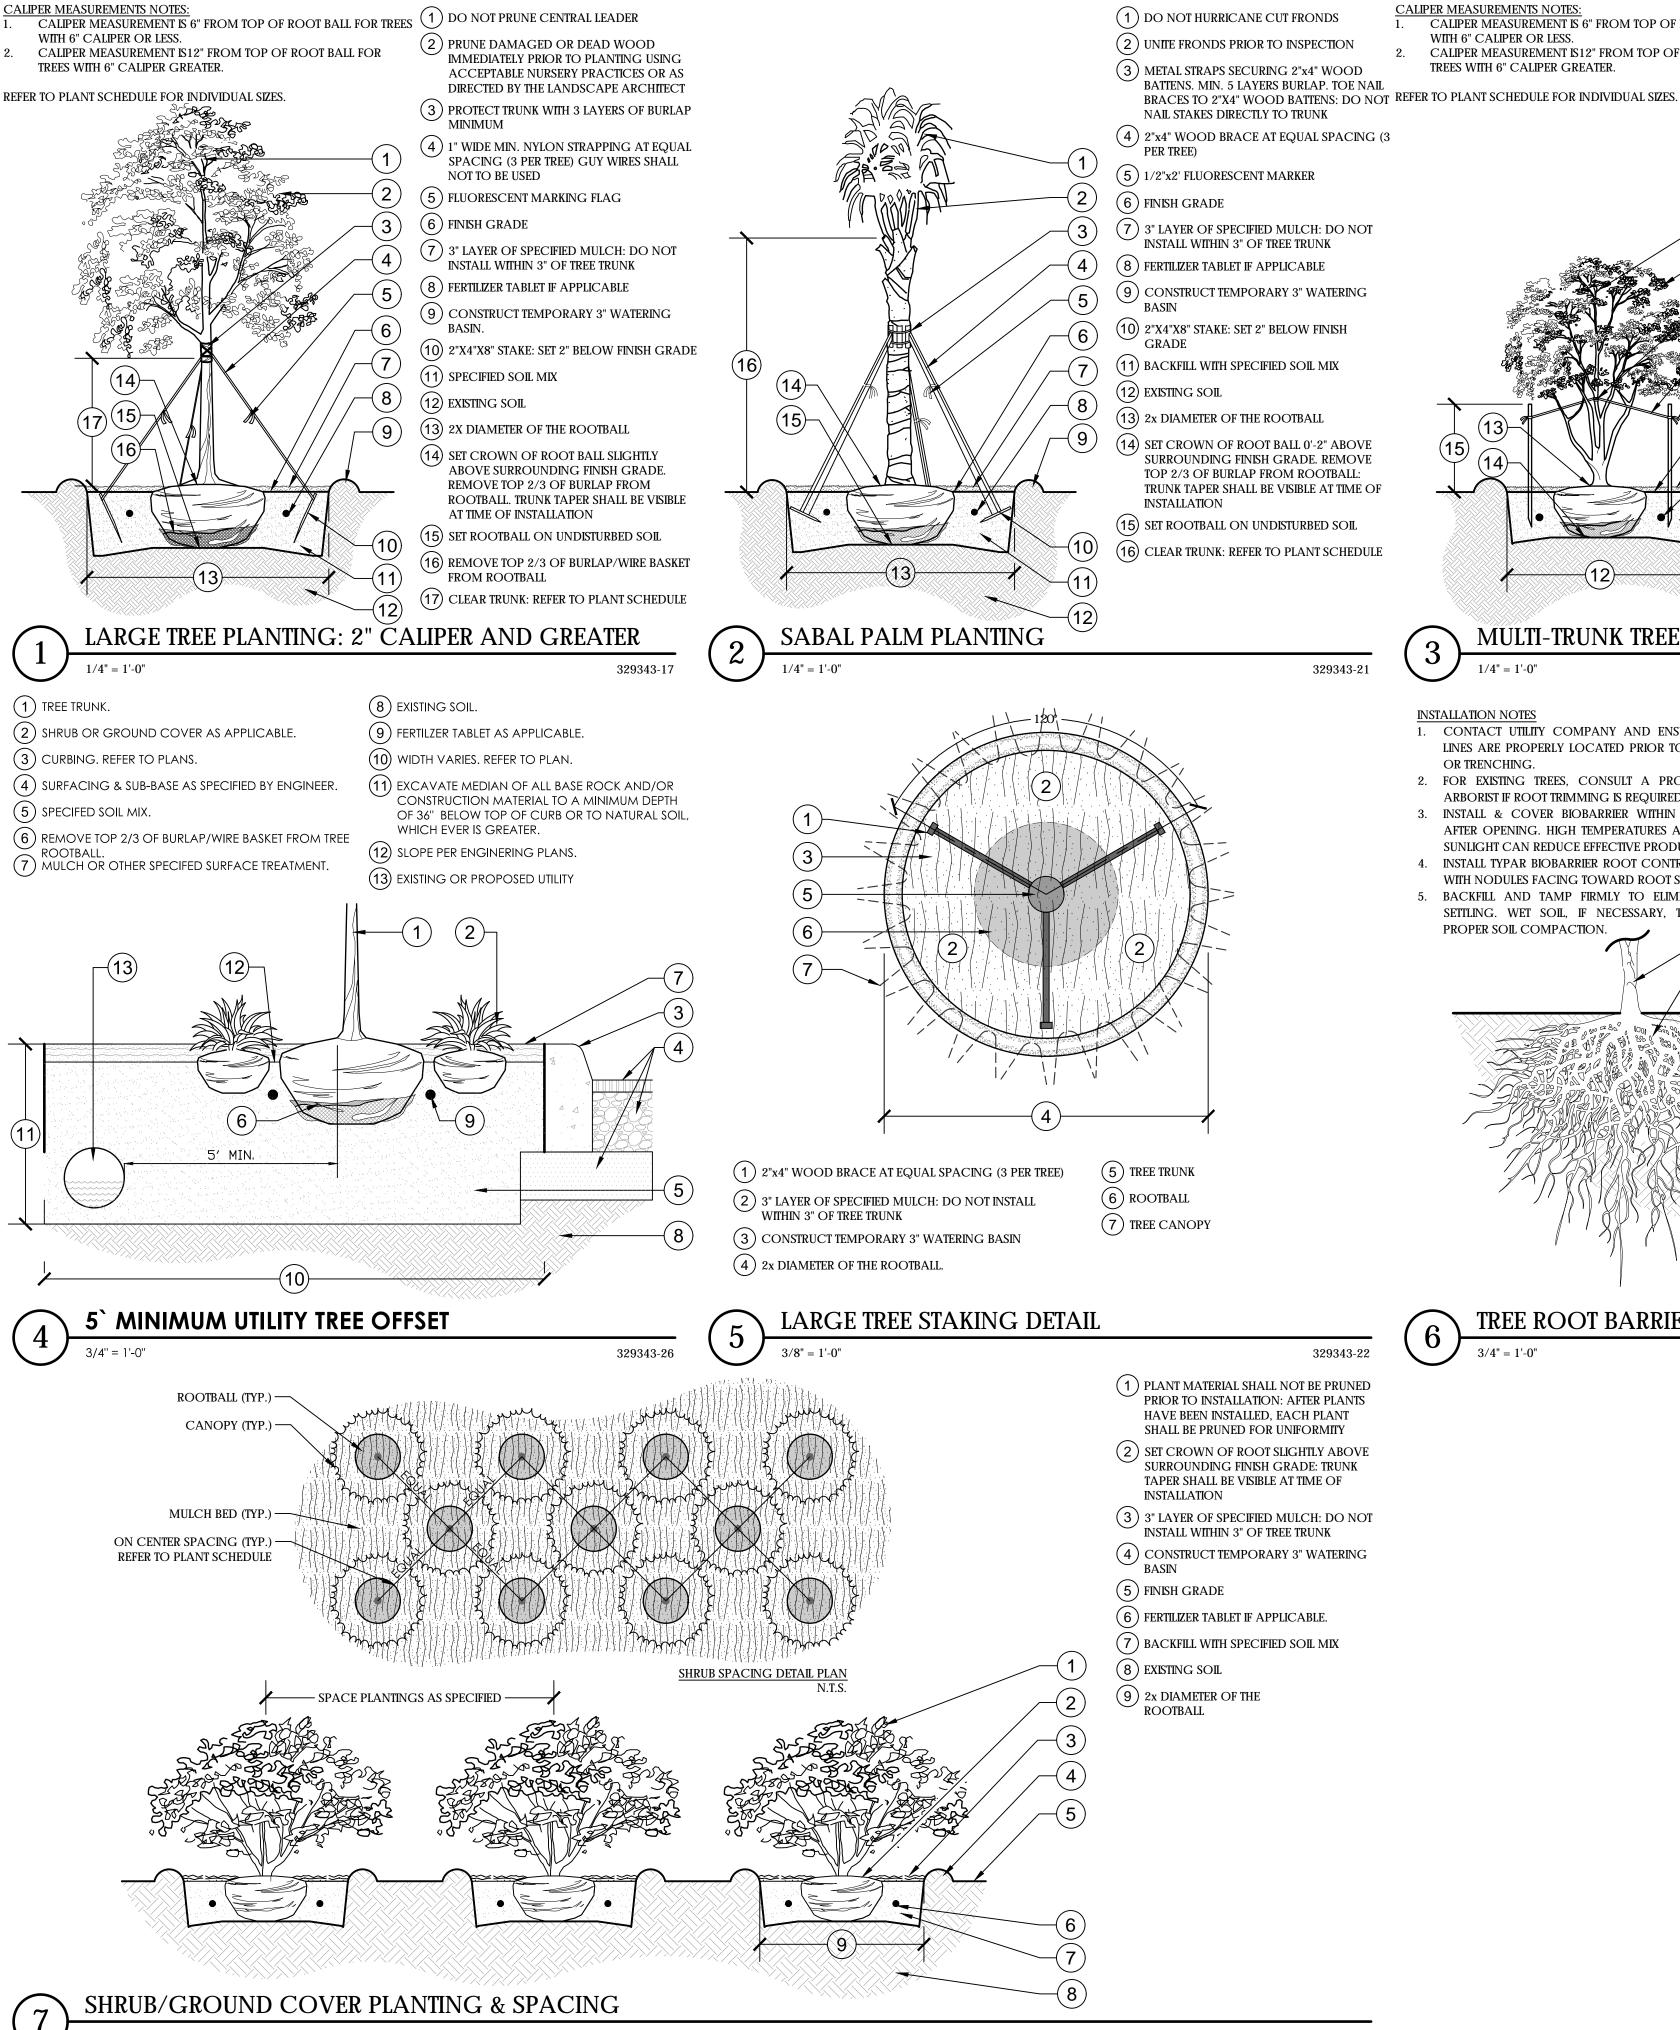
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DRAWING TITLE OVERFLOW PARKING LANDSCAPE PLAN (BID ALTERNATE 1)

DRAWING NUMBER L1.02







## CALIPER MEASUREMENTS NOTES: CALIPER MEASUREMENT IS 6" FROM TOP OF ROOT BALL FOR TREES (1) DO NOT PRUNE CENTRAL LEADER WITH 6" CALIPER OR LESS.

- CALIPER MEASUREMENT IS12" FROM TOP OF ROOT BALL FOR TREES WITH 6" CALIPER GREATER.

# MULTI-TRUNK TREE PLANTING

1/4'' = 1'-0'

- INSTALLATION NOTES 1. CONTACT UTILITY COMPANY AND ENSURE UTILITY LINES ARE PROPERLY LOCATED PRIOR TO DIGGING OR TRENCHING.
- 2. FOR EXISTING TREES, CONSULT A PROFESSIONAL ARBORIST IF ROOT TRIMMING IS REQUIRED. 3. INSTALL & COVER BIOBARRIER WITHIN 12 HOURS
- AFTER OPENING. HIGH TEMPERATURES AND DIRECT SUNLIGHT CAN REDUCE EFFECTIVE PRODUCT LIFE. 4. INSTALL TYPAR BIOBARRIER ROOT CONTROL FABRIC
- WITH NODULES FACING TOWARD ROOT SOURCE. 5. BACKFILL AND TAMP FIRMLY TO ELIMINATE SOIL
- SETTLING. WET SOIL, IF NECESSARY, TO ENSURE PROPER SOIL COMPACTION.

- (2) PRUNE DAMAGED OR DEAD WOOD IMMEDIATELY PRIOR TO PLANTING USING ACCEPTABLE NURSERY PRACTICES OR AS DIRECTED BY THE LANDSCAPE ARCHITECT
- (3) PROTECT TRUNK WITH 3 LAYERS OF BURLAP MINIMUM (4) 1" WIDE MIN. NYLON STRAPPING AT EQUAL
- SPACING (3 PER TREE) GUY WIRES SHALL NOT TO BE USED
- (5) 1/2"X2' FLUORESCENT MARKER
- (6) FINISH GRADE
- (7) 3" LAYER OF SPECIFIED MULCH. DO NOT INSTALL WITHIN 3" OF TREE TRUNK
- (8) FERTILIZER TABLET IF APPLICABLE
- (9) CONSTRUCT TEMPORARY 3" WATERING
- BASIN 10) BACKFILL WITH SPECIFIED SOIL MIX
- (11) EXISTING SOIL

(1) PROPOSED OR EXISTING TREE

EDGE

GROWTH

(2) FUTURE OR EXISTING ROOT STRUCTURE

(3) SECURE FABRIC EVERY 2'-0" WITHIN 1/4" OF TOP

(4) EXCAVATE TRENCHES A MINIMUM OF 4" WIDE:

MATURE PLANT CANOPY PLUS 10 FEET,

ADJACENT TO PROTECTION AREA

(5) PROPOSED OR EXISTING UTILITIES

CENTERED ON THE ROOT SOURCE AND

(6) TYPAR BIOBARRIER ROOT CONTROL FABRIC


(7) EXTEND ROOT CONTROL FABRIC TO A DEPTH BELOW EXISTING OR PROPOSED UTILITY LINES

VERTICALLY PLACED TO STOP LATERAL ROOT

TRENCHES MUST BE A MINIMUM LENGTH OF

- (12) 2X DIAMETER OF THE ROOTBALL
- (13) SET CROWN OF ROOT BALL SLIGHTLY ABOVE SURROUNDING FINISH GRADE. REMOVE TOP 2/3 OF BURLAP FROM ROOTBALL: TRUNK TAPER SHALL BE VISIBLE
- AT TIME OF INSTALLATION (14) SET ROOTBALL ON UNDISTURBED SOIL
- (15) CLEAR TRUNK: REFER TO PLANT SCHEDULE

## 329343-19

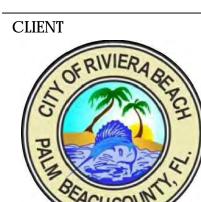

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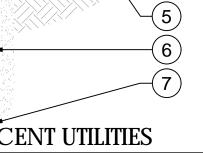
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- LANDSCAPE DETAILS

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32 9413.23-01

TREE ROOT BARRIER - ADJACENT UTILITIES

3/4" = 1'-0"

## LANDSCAPE SPECIFICATIONS

1 1	NERAL	4.2.	TREE PROTECTION BARRICADES SHALL BE PROVIDED BY LANDSCAPE CONTRACTOR AROUND THE	6.17.	NO PLAN
1.1.	WORK PERFORMED SHALL COMPLY WITH THE FOLLOWING: THESE GENERAL NOTES, CONSTRUCTION DOCUMENTS AND SPECIFICATIONS.		DRIP LINE OF EXISTING TREES TO BE PRESERVED IN PLACE, AS SHOWN ON PLAN. PRESERVATION BARRICADES SHALL BE LEFT IN PLACE THROUGHOUT DURING ALL PHASES OF CONSTRUCTION.	6.18.	SCARS, O Plant Ma
1.1.1		4.3.	PRIOR TO ANY CONSTRUCTION A TREE PROTECTION BARRICADE INSPECTION SHALL BE CONDUCTED	0.18.	BEEN CRA
1.2.	SOURCE OF BASE INFORMATION PROVIDED BY OWNER AND IS ASSUMED TO BE CORRECT. IF SITE	1.0.	BY THE LANDSCAPE ARCHITECT, OWNER OR GOVERNING MUNICIPALITY. REFER TO PLANS FOR TREE	6.19.	ALL TREES
	DISCREPANCIES ARE PRESENT, CONTRACTOR SHALL NOTIFY OWNER'S REPRESENTATIVE IMMEDIATELY.		PRESERVATION BARRICADE FENCING DETAIL.		MINIMUM
	IF CONTRACTOR CONTINUES WORK WITHOUT THE PROPER NOTIFICATION, CONTRACTOR DOES SO	4.4.	IF EXCAVATION IN THE VICINITY OF A PROTECTED TREE IS REQUIRED, CONTRACTOR SHALL ROOT	6.20.	ALL PLAN
	AT HIS OWN RISK.		PRUNE TREES, UNDER THE SUPERVISION OF A CERTIFIED ARBORIST IN ACCORDANCE TO THE		TO PROV
.3.	THE CONTRACTOR SHALL FURNISH ALL MATERIALS, LABOR, SUPERVISION, AND EQUIPMENT REQUIRED		FOLLOWING CONDITIONS:		FEET ABO
	FOR THE WORK AS SHOWN ON THE CONSTRUCTION DOCUMENTS DESCRIBED HEREIN.	4.4.1		6.21.	NO CANO
.4.	CONTRACTOR SHALL BE RESPONSIBLE FOR ANY COORDINATION WITH SUB-CONTRACTORS AS		PRUNING, THOROUGHLY WATER THE ROOT ZONE WITH AT LEAST 2 TO 3 INCHES OF WATER FOR 2	0.00	PLANTED
5	REQUIRED TO COMPLETE THE WORK OF THIS PROJECT. CONTRACTOR SHALL VERIFY LOCATIONS OF PERTINENT SITE IMPROVEMENTS INSTALLED UNDER		TO 3 DAYS PRIOR TO ROOT PRUNING. SEE BELOW FOR RELOCATION TIMELINE.	6.22.	GROUND
.5.	OTHER CONTRACTS. IF ANY PART OF THIS PLAN CANNOT BE FOLLOWED DUE TO SITE CONDITIONS,		1. PROVIDE TEMPORARY IRRIGATION FOR EACH TREE THROUGHOUT THE DURATION OF CONSTRUCTION.	6.23.	UPON PLA TREES AN
	CONTACT OWNER'S REPRESENTATIVE FOR INSTRUCTIONS PRIOR TO COMMENCING WORK.		2. ROOT PRUNE TREES, SHOWN ON PLAN IN AREAS WHERE ROOTS WILL CONFLICT WITH	0.23.	AREAS.
.6.	CONTRACTOR TO NOTIFY "SUNSHINE STATE ONE CALL OF FLORIDA, INC." AT 1-800-432-4770 TWO		CONSTRUCTION ACTIVITY. PRUNING OF ROOTS SHOULD BE DONE IN A MANNER TO PRESERVE	6.24.	ALL LAND
	FULL BUSINESS DAYS PRIOR TO DIGGING FOR UNDERGROUND UTILITY LOCATIONS.		THE GREATEST AMOUNT OF THE ROOT BASE AS POSSIBLE.	6.25.	CONTRAC
.7.	CONTRACTOR IS RESPONSIBLE FOR DETERMINING ALL UTILITY LOCATIONS AND INSTALLING FACILITIES		3. BACKFILL TRENCH WITH PLANTING SOIL.		PRIOR TO
	SO AS TO NOT CONFLICT. THE LOCATION OF EXISTING UTILITIES OR SITE FEATURES AS SHOWN ON THE		4. FERTILIZE WITHIN THE ROOT ZONE (SEE BELOW).	6.26.	CONTRAC
	PLANS MAY VARY IN RELATION TO ACTUAL EXISTING CONDITIONS. ANY DIFFERING SITE CONDITIONS	4.4.2	2. ROOT PRUNING SHALL BE ACCOMPLISHED BY DIGGING A TRENCH AROUND THE TREE IN AREAS		APPROPR
	FROM THAT WHICH IS REPRESENTED HEREON, WHETHER ABOVE, ON OR BELOW THE SURFACE OF THE		WHERE PROPOSED SITE WORK WILL BE PERFORMED. TRENCHING SHALL BE AT A MINIMUM OF 24"		ALL STAKI
	GROUND, SHOULD BE BROUGHT TO THE IMMEDIATE ATTENTION OF THE LANDSCAPE ARCHITECT AND		DEEP. ROOT PRUNE ONLY WITH A MECHANICAL ROOT-PRUNING SAW OR A TRENCHER WITH A		AFTER EST
	THE OWNER IN WRITING. NO CLAIM FOR EXPENSES INCURRED BY THE CONTRACTOR DUE TO	4.4.0	MAXIMUM TRENCH WIDTH OF 8".	6.27.	TREES THA
	DIFFERING SITE CONDITIONS WILL BE ALLOWED IF THE CONTRACTOR FAILS TO PROVIDE THE	4.4.3			RF GRASSES
	REQUIRED WRITTEN NOTIFICATION OF SUCH CONDITIONS FOR REVIEW BY THE LANDSCAPE ARCHITECT AND THE OWNER.		TRENCHES WITH SOIL CONSISTING OF 30% SILICA SAND AND 70% MUCK. WATER THOROUGHLY AFTER ROOT PRUNING, AND ONCE WEEKLY DURING THE ROOT REGENERATION PERIOD, WITH A	7.1.	ALL AREA: GRASSED.
.8.	CONTRACTOR SHALL NOTIFY ALL APPROPRIATE UTILITY COMPANIES OF PROPOSED START OF WORK		SOLUBLE FERTILIZER THAT HAS A 20.20.20 ANALYSIS AT MANUFACTURER'S RECOMMENDED RATE.		GRASSED. WATERLIN
~	IN ACCORDANCE WITH THEIR STANDARD REQUIREMENTS, INCLUDING BUT NOT LIMITED TO, WATER,	4.5.	THE CONTRACTOR SHALL FIELD STAKE THE LIMIT OF ROOT PRUNING. LIMITS OF ROOT PRUNING SHALL		ESTIMATED
	SANITARY SEWER, POWER, NATURAL GAS, TELEPHONE AND CABLE TV COMPANIES.		BE APPROVED BY THE LANDSCAPE ARCHITECT PRIOR TO ANY EXCAVATION. DO NOT ROOT PRUNE	8. <u>M</u> I	JLCH & FERT
.9.	IT SHALL BE THE CONTRACTOR'S SOLE RESPONSIBILITY TO TAKE THE NECESSARY PRECAUTIONS TO		FOR IRRIGATION OR ELECTRICAL LINES WITHIN DRIP LINES OF EXISTING TREES. COORDINATE ALL	8.1.	ALL PLAN
	ENSURE PROPER SAFETY AND WORKMANSHIP WHEN WORKING IN THE VICINITY OF EXISTING UTILITY		TRENCHING REQUIRED FOR UTILITY WORK WITH THE LANDSCAPE PLANS.		OF SHRED
	LINES.	4.6.	ROOT PRUNING SHALL OCCUR IN ACCORDANCE WITH TREE RELOCATION NOTES AS NOTED ON		OTHERWIS
.10.	PERFORM EXCAVATION IN THE VICINITY OF UNDERGROUND UTILITIES WITH CARE AND BY HAND, IF		PLANS.	8.2.	INDIVIDUA
	NECESSARY. THE CONTRACTOR BEARS FULL RESPONSIBILITY FOR THIS WORK AND DISRUPTION OF		ANTING SOIL		MULCH RI
11	DAMAGE TO UTILITIES SHALL BE REPAIRED IMMEDIATELY AND AT NO EXPENSE TO THE OWNER. THE SUCCESSFUL BIDDER SHALL FURNISH TO THE OWNER A UNIT PRICE BREAKDOWN FOR ALL	5.1.	ALL TREES SHALL BE PLANTED WITH A MINIMUM OF 12" TOPSOIL AROUND AND BENEATH THE	8.3.	MULC H SH
.11.	MATERIALS. THE OWNER MAY, AT ITS DISCRETION, ADD OR DELETE FROM THE MATERIALS UTILIZING	5.2.	ROOTBALL. All trees shall be planted with a minimum of 6" topsoil around and beneath the	8.4. 8.4.	FERTILIZER
	THE UNIT PRICE BREAKDOWN SUBMITED.	5.2.	ROOTBALL.	8.4.2	
1.12.	IT IS THE RESPONSIBILITY OF THE CONTRACTOR TO ENSURE THAT ALL REQUIRED PERMITS ARE	5.3.	MINIMUM TOPSOIL SHALL BE 2" FOR SODDED GRASS AREAS.	8.4.3	
	OBTAINED AND ARE IN HAND AT THE JOB SITE PRIOR TO THE COMMENCEMENT OF CONSTRUCTION.	5.4.	PLANTING SOIL MIX SHALL BE A WEED FREE MIX AS FOLLOWS:	9. <u>W</u>	ATERING
	CONTRACTOR SHALL ABIDE BY ALL PERMIT CONDITIONS.	5.4.1	1. DICOT TREES & SHRUBS: 50% SAND, 40% MUCK & 10% PEAT	9.1.	ALL LANI
PRE	C-CONSTRUCTION RESPONSIBILITY	5.4.2	2. MONOCOT PALMS: 70% SAND & 30% MUCK		UNDERGR
2.1.	UPON RECEIPT OF NOTICE OF AWARD, THE CONTRACTOR SHALL ARRANGE A PRE-CONSTRUCTION	5.4.3	3. TURF: 80% SAND, 10% PEAT & 10% MUCK		50% SPRA
	CONFERENCE TO INCLUDE ALL INVOLVED GOVERNMENTAL AGENCIES, ALL AFFECTED UTILITY	6. <u>LA</u>	NDSCAPE PLANTING		DESIGNED
	OWNERS, THE OWNER, THE LANDSCAPE ARCHITECT, ANY OTHER PERTINENT PARTIES AND HIMSELF.	6.1.	THIS PLAN HAS BEEN DESIGNED TO MEET OR EXCEED ALL APPLICABLE CODES.		SENSOR D
2.	CONTRACTOR SHALL PROVIDE TEMPORARY SANITARY FACILITIES ONSITE. LOCATION TO BE	6.2.	THE PLANTING PLAN SHALL BE INSTALLED IN COMPLIANCE WITH ALL EXISTING CODES AND	0.0	ADEQUAT
	DETERMINED BY THE OWNER. JANITORIAL SERVICES SHALL BE PROVIDED BY CONTRACTOR THROUGHOUT THE DURATION OF PROJECT.	6.2	APPLICABLE DEED RESTRICTIONS. PLANT MATERIAL: ALL PLANT MATERIAL SHALL BE FLORIDA #1 OR BETTER AS ESTABLISHED BY "GRADES	9.2.	ALL LAND ESTABLISHI
.3.	PRIOR TO BEGINNING CONSTRUCTION, THE CONTRACTOR SHALL VERIFY THE SIZE, LOCATION,	6.3.	AND STANDARDS FOR NURSERY PLANTS" OF THE STATE OF FLORIDA, DEPARTMENT OF AGRICULTURE.		LANDSCA
	ELEVATION, AND MATERIAL OF ALL EXISTING UTILITIES WITHIN THE AREA OF CONSTRUCTION.	6.4.	ALL PLANT MATERIAL SHALL BE TRUE TO THE BOTANICAL NAME, GENUS, SPECIES AND/OR HYBRID	9.3.	ALL PLAN
.4.	IF UPON EXCAVATION, AN EXISTING UTILITY IS FOUND TO BE IN CONFLICT WITH THE PROPOSED		DESIGNATION.		STANDARI
	CONSTRUCTION OR TO BE OF A SIZE OR MATERIAL DIFFERENT FROM THAT SHOWN ON THE PLANS;	6.5.	ALL TREES, SHRUBS AND GROUNDCOVERS SHALL BE OF THE SIZES (HEIGHT & SPREAD) AS SPECIFIED IN		PLANT MA
	THE CONTRACTOR SHALL IMMEDIATELY NOTIFY THE LANDSCAPE ARCHITECT.		THE PLANT LIST. CONTAINER SIZE IS FOR REFERENCE PURPOSES ONLY. ALL PLANT MATERIAL SHALL		OWNER.
.5.	IT SHALL BE THE CONTRACTOR'S RESPONSIBILITY TO MAKE ARRANGEMENTS FOR THE FIELD		MEET OR EXCEED THE MINIMUM SIZES AT INSTALLATION, AS SPECIFIED IN THE PLANT LIST.	10. <u>PR</u>	OJECT CLOS
	LOCATIONS AND FOR ANY TREES PROPOSED FOR RELOCATION. THIS SHALL BE DONE IN A TIMELY	6.6.	QUANTITIES LISTED ON THE PLANT LIST ARE FOR ESTIMATING PURPOSES. CONTRACTOR SHALL VERIFY	10.1.	DURING C
	MANNER TO MINIMIZE IMPACT ON CONSTRUCTION SCHEDULE. ANY DELAY CAUSED BY THE		ALL QUANTITIES. MULCH, TOPSOIL, FERTILIZER, ETC. SHALL BE INCLUDED IN THE UNIT COST OF THE		NEAT AND
	CONTRACTOR BY THE RELOCATION OF TREES SHALL BE INCIDENTAL TO THE CONTRACT AND NO		PLANTS.	10.0	SURPLUS N
.6.	EXTRA COMPENSATION WILL BE ALLOWED. CONTRACTOR SHALL VERIFY LIMITS OF CONSTRUCTION AS NOTED ON THE PLANS. ANY WORK	6.7.	WHERE THERE IS A DISCREPANCY EITHER IN QUANTITIES, PLANT NAMES, SIZES OR SPECIFICATIONS	10.2.	THE CONT PUBLIC O
.0.	PERFORMED OUTSIDE OF THE AGREED UPON LIMITS OF CONSTRUCTION SHALL BE DONE AT THE	6.8.	BETWEEN THE PLAN OR PLANT LIST, THE PLAN TAKES PRECEDENCE. ALL SUBSTITUTIONS AND CHANGES SHALL BE APPROVED IN WRITING PRIOR TO INSTALLATION. ANY		EMPLOYE
	EXPENSE OF THE CONTRACTOR.	0.0.	DISCREPANCIES BETWEEN PLANS, SITE AND SPECIFICATIONS SHALL BE BROUGHT TO THE IMMEDIATE		EQUAL TO
<u>SIT</u> E	E DEMOLITION		ATTENTION OF THE LANDSCAPE ARCHITECT, THE OWNER AND/OR GOVERNING MUNICIPALITY.		BE AT THE
	ITEMS SHALL REMAIN UNLESS OTHERWISE NOTED ON THE PLAN(S). REMOVE DESIGNATED ITEMS	6.9.	CONTRACTOR SHALL BE RESPONSIBLE FOR PROVIDING FINAL GRADING OF ALL ASSOCIATED		RESTORAT
.1.	SHOWN ON THE PLAN TO THE FULL DEPTH OF THEIR CONSTRUCTION UNLESS OTHERWISE NOTED.		PLANTING AREAS.	10.3.	WHERE M
.1.		6.10.	AFTER FINAL GRADE, LANDSCAPE AREAS ARE TO BE RAKED TO A DEPTH OF 6". ALL ROCK AND		DITCHES, I
	ALL HARDSCAPE DESIGNATED FOR REMOVAL SHALL BE SAW CUT, LEAVING UNIFORM EDGES TO THE	0.10.	FOREIGN INORGANIC MATERIALS SHALL BE REMOVED AND DISPOSED OF PROPERLY OFF-SITE.		SUCH MA
	GREATEST EXTENT POSSIBLE. MATERIAL EDGES TO REMAIN SHALL BE SHORED UP AND PROTECTED	0.10.	ALL PLANTING HOLES TO BE HAND DUG EXCEPT WHERE MACHINE DUG HOLES WILL NOT ADVERSELY		PROGRESS
	GREATEST EXTENT POSSIBLE. MATERIAL EDGES TO REMAIN SHALL BE SHORED UP AND PROTECTED DURING CONSTRUCTION TO PRESERVE EDGE INTACT. REPAIRS TO DAMAGED EDGES SHALL BE				
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.2. .3. .4.	<ul> <li>GREATEST EXTENT POSSIBLE. MATERIAL EDGES TO REMAIN SHALL BE SHORED UP AND PROTECTED DURING CONSTRUCTION TO PRESERVE EDGE INTACT. REPAIRS TO DAMAGED EDGES SHALL BE REPAIRED BY CONTRACTOR AT NO ADDITIONAL COST TO THE OWNER.</li> <li>NO EXISTING MATERIAL SHALL BE USED IN NEW CONSTRUCTION UNLESS NOTED ON THE PLANS OR APPROVED DURING THE SHOP DRAWING APPROVAL PROCESS.</li> <li>SALVAGE EXISTING MATERIALS AS INDICATED ON THE PLANS. SALVAGED MATERIALS SHALL BE HANDLED WITH CARE AND STORED ON-SITE OR AS DIRECTED BY OWNER. CLEAN ALL DEBRIS AND CONSTRUCTION MATERIAL FROM SALVAGED ITEMS; REUSE AS DIRECTED BY OWNER'S REPRESENTATIVE.</li> <li>REMOVE DEMOLISHED MATERIALS FROM SITE AND DISPOSE OF AS REQUIRED BY LOCAL, STATE OR FEDERAL LAWS.</li> <li>CONTRACTOR SHALL PROTECT ADJACENT WATER BODIES, COASTAL DUNE SYSTEMS AND</li> </ul>	<ul><li>6.11.</li><li>6.12.</li><li>6.13.</li></ul>	AFFECT EXISTING TREES, DAMAGE UTILITIES OR OTHER IMPROVEMENTS. ALL PLANTING BEDS IN OPEN AREAS AND AROUND BUILDING FOUNDATIONS SHALL BE EXCAVATED TO A DEPTH OF TWENTY-FOUR INCHES (24") AND BACK FILLED WITH SOIL MIX AS SPECIFIED IN SECTION 5.00. PLANTING BED SHALL BE FREE FROM ROCK, CONSTRUCTION DEBRIS OR OTHER EXTRANEOUS MATERIAL. ALL PLANTING BEDS IN MEDIANS, HARDSCAPE AREAS OR AREAS ENCOMPASSED BY IMPERVIOUS MATERIAL SHALL BE EXCAVATED TO A DEPTH OF THIRTY-SIX INCHES (36") OR UNTIL NATIVE SOILS ENCOUNTERED TO ENSURE DRAINAGE. BACK FILL WITH SOIL MIX AS SPECIFIED IN SECTION 5.00. PLANTING BED SHALL BE FREE FROM ROCK, CONSTRUCTION DEBRIS OR OTHER EXTRANEOUS MATERIAL.	10.5. 11. <u>G</u>	COMPLET UPON CC ARCHITEC DRAWING LOCATION SPECIFIED SHALL BE S JARANTEE ALL NEW 1
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	<ul> <li>GREATEST EXTENT POSSIBLE. MATERIAL EDGES TO REMAIN SHALL BE SHORED UP AND PROTECTED DURING CONSTRUCTION TO PRESERVE EDGE INTACT. REPAIRS TO DAMAGED EDGES SHALL BE REPAIRED BY CONTRACTOR AT NO ADDITIONAL COST TO THE OWNER.</li> <li>NO EXISTING MATERIAL SHALL BE USED IN NEW CONSTRUCTION UNLESS NOTED ON THE PLANS OR APPROVED DURING THE SHOP DRAWING APPROVAL PROCESS.</li> <li>SALVAGE EXISTING MATERIALS AS INDICATED ON THE PLANS. SALVAGED MATERIALS SHALL BE HANDLED WITH CARE AND STORED ON-SITE OR AS DIRECTED BY OWNER. CLEAN ALL DEBRIS AND CONSTRUCTION MATERIAL FROM SALVAGED ITEMS; REUSE AS DIRECTED BY OWNER'S REPRESENTATIVE.</li> <li>REMOVE DEMOLISHED MATERIALS FROM SITE AND DISPOSE OF AS REQUIRED BY LOCAL, STATE OR FEDERAL LAWS.</li> <li>CONTRACTOR SHALL PROTECT ADJACENT WATER BODIES, COASTAL DUNE SYSTEMS AND PROPERTIES FROM DAMAGE BY SEDIMENTATION OR OTHER POTENTIAL CONSTRUCTION RELATED CAUSES.</li> <li>ALL IRRIGATION IN DEMOLITION AREA TO BE CAPPED AND ADJUSTED AS NECESSARY TO ENSURE</li> </ul>	<ul><li>6.11.</li><li>6.12.</li><li>6.13.</li><li>6.14.</li></ul>	<ul> <li>AFFECT EXISTING TREES, DAMAGE UTILITIES OR OTHER IMPROVEMENTS.</li> <li>ALL PLANTING BEDS IN OPEN AREAS AND AROUND BUILDING FOUNDATIONS SHALL BE EXCAVATED TO A DEPTH OF TWENTY-FOUR INCHES (24") AND BACK FILLED WITH SOIL MIX AS SPECIFIED IN SECTION 5.00. PLANTING BED SHALL BE FREE FROM ROCK, CONSTRUCTION DEBRIS OR OTHER EXTRANEOUS MATERIAL.</li> <li>ALL PLANTING BEDS IN MEDIANS, HARDSCAPE AREAS OR AREAS ENCOMPASSED BY IMPERVIOUS MATERIAL SHALL BE EXCAVATED TO A DEPTH OF THIRTY-SIX INCHES (36") OR UNTIL NATIVE SOILS ENCOUNTERED TO ENSURE DRAINAGE. BACK FILL WITH SOIL MIX AS SPECIFIED IN SECTION 5.00. PLANTING BED SHALL BE FREE FROM ROCK, CONSTRUCTION DEBRIS OR OTHER EXTRANEOUS MATERIAL.</li> <li>EXCAVATE PLANTING PITS TO A DEPTH SO THAT THE TRUNK FLARE AND FIRST ORDER LATERAL ROOT(S) WILL BE PLANTED AT FINISH GRADE OR SLIGHTLY HIGHER. ADVENTITIOUS ROOTS ARE NOT CONSIDERED FIRST ORDER ROOTS.</li> </ul>	10.5. 11. <u>G</u>	COMPLE UPON C ARCHITE DRAWIN LOCATIC SPECIFIE SHALL BE JARANTEE ALL NEW OF PROJ KIND BY

4.1. ALL TREES TO BE PRESERVED AS INDICATED ON THE TREE DISPOSITION PLAN SHALL BE PROTECTED BY

A TREE PROTECTION BARRICADE, UNLESS OTHERWISE NOTED ON PLAN.

6.16. NO PLUNGING OF ANY TREE OR PALM WILL BE ACCEPTED

## ED AT FINISH GRADE OR SLIGHTLY HIGHER. ADVENTITIOUS ROOTS ARE NOT RST ORDER ROOTS.

- ETIC STRING, CORDS AND/OR LIFTING ROPES SHALL BE REMOVED FROM THE DRE ANY TREES ARE PLANTED. THE TOP 1/3RD OF BURLAP MUST BE REMOVED FROM HE TOP OF THE ROOTBALLS. THE TOP 1/3RD OF WIRE BASKETS SHALL BE COMPLETELY REMOVED AND THE BOTTOM 2/3RDS SHALL BE CUT BEFORE THE TREES ARE INSTALLED.
- BE EXCAVATED TO A DEPTH OF THIRTY-SIX INCHES (36") OR UNTIL NATIVE SOILS
- TWENTY-FOUR INCHES (24") AND BACK FILLED WITH SOIL MIX AS SPECIFIED IN TERIAL. BEDS IN MEDIANS, HARDSCAPE AREAS OR AREAS ENCOMPASSED BY IMPERVIOUS
- EDS IN OPEN AREAS AND AROUND BUILDING FOUNDATIONS SHALL BE EXCAVATED PLANTING BED SHALL BE FREE FROM ROCK, CONSTRUCTION DEBRIS OR OTHER
- ANIC MATERIALS SHALL BE REMOVED AND DISPOSED OF PROPERLY OFF-SITE. OLES TO BE HAND DUG EXCEPT WHERE MACHINE DUG HOLES WILL NOT ADVERSELY TREES, DAMAGE UTILITIES OR OTHER IMPROVEMENTS.
- RADE, LANDSCAPE AREAS ARE TO BE RAKED TO A DEPTH OF 6". ALL ROCK AND
- BETWEEN PLANS, SITE AND SPECIFICATIONS SHALL BE BROUGHT TO THE IMMEDIATE HE LANDSCAPE ARCHITECT, THE OWNER AND/OR GOVERNING MUNICIPALITY. SHALL BE RESPONSIBLE FOR PROVIDING FINAL GRADING OF ALL ASSOCIATED
- A DISCREPANCY EITHER IN QUANTITIES, PLANT NAMES, SIZES OR SPECIFICATIONS 10.2. THE CONTRACTOR SHALL RESTORE, REPLACE OR AS DIRECTED BY THE LANDSCAPE ARCHITECT, AN AN OR PLANT LIST, THE PLAN TAKES PRECEDENCE. NS AND CHANGES SHALL BE APPROVED IN WRITING PRIOR TO INSTALLATION. ANY

- MULCH, TOPSOIL, FERTILIZER, ETC. SHALL BE INCLUDED IN THE UNIT COST OF THE

- THE MINIMUM SIZES AT INSTALLATION, AS SPECIFIED IN THE PLANT LIST. 10. PROJECT CLOSEOUT ED ON THE PLANT LIST ARE FOR ESTIMATING PURPOSES. CONTRACTOR SHALL VERIFY 10.1. DURING CONSTRUCTION, THE PROJECT SITE AND ALL ADJACENT AREAS SHALL BE MAINTAINED IN
- IBS AND GROUNDCOVERS SHALL BE OF THE SIZES (HEIGHT & SPREAD) AS SPECIFIED IN CONTAINER SIZE IS FOR REFERENCE PURPOSES ONLY. ALL PLANT MATERIAL SHALL

- 5 FOR NURSERY PLANTS" OF THE STATE OF FLORIDA, DEPARTMENT OF AGRICULTURE. ERIAL SHALL BE TRUE TO THE BOTANICAL NAME, GENUS, SPECIES AND/OR HYBRID
- EEN DESIGNED TO MEET OR EXCEED ALL APPLICABLE CODES. PLAN SHALL BE INSTALLED IN COMPLIANCE WITH ALL EXISTING CODES AND D RESTRICTIONS. ALL PLANT MATERIAL SHALL BE FLORIDA #1 OR BETTER AS ESTABLISHED BY "GRADES
- IIX SHALL BE A WEED FREE MIX AS FOLLOWS: 9. WATERING 5 & SHRUBS: 50% SAND, 40% MUCK & 10% PEAT PALMS: 70% SAND & 30% MUCK
- BE PLANTED WITH A MINIMUM OF 6" TOPSOIL AROUND AND BENEATH THE DIL SHALL BE 2" FOR SODDED GRASS AREAS.
- BE PLANTED WITH A MINIMUM OF 12" TOPSOIL AROUND AND BENEATH THE 8.3.

- UIRED FOR UTILITY WORK WITH THE LANDSCAPE PLANS. SHALL OCCUR IN ACCORDANCE WITH TREE RELOCATION NOTES AS NOTED ON
- ( THE LANDSCAPE ARCHITECT PRIOR TO ANY EXCAVATION. DO NOT ROOT PRUNE 8. <u>MULCH & FERTILIZER</u>
- ED ROOTS SHALL BE CUT OFF SMOOTHLY, WITH SHARP INSTRUMENTS. BACKFILL 7. TURF GRASSES PRUNING, AND ONCE WEEKLY DURING THE ROOT REGENERATION PERIOD, WITH A RTILIZER THAT HAS A 20.20.20 ANALYSIS AT MANUFACTURER'S RECOMMENDED RATE. DR SHALL FIELD STAKE THE LIMIT OF ROOT PRUNING. LIMITS OF ROOT PRUNING SHALL
- ING SHALL BE ACCOMPLISHED BY DIGGING A TRENCH AROUND THE TREE IN AREAS POSED SITE WORK WILL BE PERFORMED. TRENCHING SHALL BE AT A MINIMUM OF 24" PRUNE ONLY WITH A MECHANICAL ROOT-PRUNING SAW OR A TRENCHER WITH A RENCH WIDTH OF 8".
- E WITHIN THE ROOT ZONE (SEE BELOW).
- EST AMOUNT OF THE ROOT BASE AS POSSIBLE. ILL TRENCH WITH PLANTING SOIL.
- PRUNE TREES, SHOWN ON PLAN IN AREAS WHERE ROOTS WILL CONFLICT WITH
- PRIOR TO ROOT PRUNING. SEE BELOW FOR RELOCATION TIMELINE. DE TEMPORARY IRRIGATION FOR EACH TREE THROUGHOUT THE DURATION OF
- NDITIONS:
- NDER THE SUPERVISION OF A CERTIFIED ARBORIST IN ACCORDANCE TO THE
- ONSTRUCTION A TREE PROTECTION BARRICADE INSPECTION SHALL BE CONDUCTED ARRICADE FENCING DETAIL.
- ALL BE LEFT IN PLACE THROUGHOUT DURING ALL PHASES OF CONSTRUCTION.
- KISTING TREES TO BE PRESERVED IN PLACE, AS SHOWN ON PLAN. PRESERVATION
- DN BARRICADES SHALL BE PROVIDED BY LANDSCAPE CONTRACTOR AROUND THE 6.17. NO PLANT MATERIAL WILL BE ACCEPTED SHOWING EVIDENCE OF CABLE, CHAIN MARKS, EQUIPMEN SCARS, OR OTHERWISE DAMAGED.
  - 6.18. PLANT MATERIAL WILL NOT BE ACCEPTED WHEN THE BALL OF EARTH SURROUNDING ITS ROOTS HA
- BEEN CRACKED, BROKEN OR OTHERWISE DAMAGED. APE ARCHITECT, OWNER OR GOVERNING MUNICIPALITY. REFER TO PLANS FOR TREE 6.19. ALL TREES SPECIFIED AS FIELD GROWN OR B&B TREES SHALL BE ROOT-PRUNED AT THE NURSERY
- MINIMUM OF (8) WEEKS PRIOR TO PLANTING. IN THE VICINITY OF A PROTECTED TREE IS REQUIRED, CONTRACTOR SHALL ROOT 6.20. ALL PLANT MATERIAL PLANTED WITHIN THE SIGHT DISTANCE TRIANGLE AREAS SHALL BE MAINTAINE TO PROVIDE UNOBSTRUCTED CROSS-VISIBILITY AT A HORIZONTAL LEVEL BETWEEN 30 INCHES AND
  - FEET ABOVE ADJACENT STREET GRADE.
- E TREES A MINIMUM OF EIGHT (8) WEEKS PRIOR TO CONSTRUCTION. PRIOR TO ROOT 6.21. NO CANOPY TREES SHALL BE PLANTED WITHIN 12 FEET OF A LIGHT POLE. NO PALM SPECIES SHALL
  - PLANTED WITHIN 6 FEET OF A LIGHT POLE.

  - 6.22. GROUND COVER PLANTINGS SHALL PROVIDE NOT LESS THAN 50 PERCENT COVERAGE IMMEDIATE UPON PLANTING AND 100 PERCENT COVERAGE WITHIN 6 MONTHS AFTER PLANTING.
  - 6.23. TREES AND PALMS SHALL BE MAINTAINED TO ALLOW FOR CLEAR PASSAGE 8' IN ALL PEDESTRIA
  - AREAS.
- ION ACTIVITY. PRUNING OF ROOTS SHOULD BE DONE IN A MANNER TO PRESERVE 6.24. ALL LANDSCAPE MATERIAL SHALL BE SETBACK A MINIMUM OF 10' FROM ANY FIRE HYDRANT. 6.25. CONTRACTOR SHALL REMOVE ALL NURSERY STAKES, CONDULT, FLAGGING AND NURSERY TAI
  - PRIOR TO STAKING. 6.26. CONTRACTOR SHALL STAKE & GUY ALL TREES AND PALMS AT TIME OF PLANTING AS PER T APPROPRIATE DETAIL. CONTRACTOR IS RESPONSIBLE FOR THE MAINTENANCE AND/OR REPAIR ALL STAKING AND GUYING DURING WARRANTY PERIOD AND REMOVAL & DISPOSAL OF STAKIN
  - AFTER ESTABLISHMENT/WARRANTY PERIOD. 6.27. TREES THAT CANNOT STAND WITHOUT THE SUPPORT OF STAKES AND/OR GUYS SHALL BE REJECTED.
- VITH SOIL CONSISTING OF 30% SILICA SAND AND 70% MUCK. WATER THOROUGHLY 7.1. ALL AREAS NOT USED FOR BUILDINGS, VEHICULAR USE AREAS, WALKS OR PLANTING BEDS SHALL GRASSED. GRASSING SHALL EXTEND TO ANY ABUTTING STREET PAVEMENT EDGE AND TO THE MEA WATERLINE OF ANY ABUTTING CANAL, LAKE OR WATERWAY. REFER TO PLANTING SCHEDULE FO ESTIMATED QUANTITY AND SPECIES.

- OR ELECTRICAL LINES WITHIN DRIP LINES OF EXISTING TREES. COORDINATE ALL 8.1. ALL PLANTING BEDS AND WATER BASINS FOR TREES SHALL BE COVERED WITH A 3" MINIMUM DEPT OF SHREDDED FLORI-MULCH, MELALEUCA OR EUCALYPTUS MULCH GRADE 'B' OR BETTER, UNLE OTHERWISE SPECIFIED.
  - 8.2. INDIVIDUAL TREES PLANTED IN LAWN AREAS SHALL BE MULCHED WITH A MINIMUM 3' DIAMETH MULCH RING.

				CHEN•MOORE
6.17.	NO PLANT MATERIAL WILL BE ACCEPTED SHOWING EVIDENCE OF CABLE, CHAIN MARKS, EQUIPMENT SCARS, OR OTHERWISE DAMAGED.	11.2.	FOR ALL REPLACEMENT PLANT MATERIAL, THE WARRANTY PERIOD SHALL BE EXTENDED AN ADDITIONAL 90 DAYS BEYOND THE ORIGINAL WARRANTY PERIOD. REPLACEMENT MATERIAL SHALL	& ASSOCIATES 500 Australian Avenue South
6.18.	PLANT MATERIAL WILL NOT BE ACCEPTED WHEN THE BALL OF EARTH SURROUNDING ITS ROOTS HAS BEEN CRACKED, BROKEN OR OTHERWISE DAMAGED.	11.3.	BE REPLACED IN KIND AS IT RELATES TO SPECIES, QUANTITY AND SIZE. ALL TREES THAT LEAN OR ARE BLOWN OVER, CAUSED BY WINDS LESS THAN 74 MPH AS DETERMINED	Solice Solice Solice Suite 530 West Palm Beach, FL 33401 561.746.6900
6.19.	ALL TREES SPECIFIED AS FIELD GROWN OR B&B TREES SHALL BE ROOT-PRUNED AT THE NURSERY A MINIMUM OF (8) WEEKS PRIOR TO PLANTING.		BY THE NATIONAL HURRICANE CENTER, WILL BE RE-SET AND BRACED BY THE CONTRACTOR AT NO ADDITIONAL COST TO THE OWNER.	www.chenmoore.com CERTIFICATES OF AUTHORIZATION
6.20.	ALL PLANT MATERIAL PLANTED WITHIN THE SIGHT DISTANCE TRIANGLE AREAS SHALL BE MAINTAINED TO PROVIDE UNOBSTRUCTED CROSS-VISIBILITY AT A HORIZONTAL LEVEL BETWEEN 30 INCHES AND 8 FEET ABOVE ADJACENT STREET GRADE.			EB4593 LC26000425 REGISTRATION CRISTOBAL BETANCOURT
6.21.	NO CANOPY TREES SHALL BE PLANTED WITHIN 12 FEET OF A LIGHT POLE. NO PALM SPECIES SHALL BE PLANTED WITHIN 6 FEET OF A LIGHT POLE.			REGISTRATION NO. LA66666941 DATE:
6.22.	GROUND COVER PLANTINGS SHALL PROVIDE NOT LESS THAN 50 PERCENT COVERAGE IMMEDIATELY UPON PLANTING AND 100 PERCENT COVERAGE WITHIN 6 MONTHS AFTER PLANTING.			
6.23.	TREES AND PALMS SHALL BE MAINTAINED TO ALLOW FOR CLEAR PASSAGE 8' IN ALL PEDESTRIAN AREAS.			
6.24. 6.25.	ALL LANDSCAPE MATERIAL SHALL BE SETBACK A MINIMUM OF 10' FROM ANY FIRE HYDRANT. CONTRACTOR SHALL REMOVE ALL NURSERY STAKES, CONDUIT, FLAGGING AND NURSERY TAPE PRIOR TO STAKING.			
6.26.	CONTRACTOR SHALL STAKE & GUY ALL TREES AND PALMS AT TIME OF PLANTING AS PER THE APPROPRIATE DETAIL. CONTRACTOR IS RESPONSIBLE FOR THE MAINTENANCE AND/OR REPAIR OF ALL STAKING AND GUYING DURING WARRANTY PERIOD AND REMOVAL & DISPOSAL OF STAKING AFTER ESTABLISHMENT/WARRANTY PERIOD.			SUB-CONSULTANT
6.27. 7. <u>TUI</u>	TREES THAT CANNOT STAND WITHOUT THE SUPPORT OF STAKES AND/OR GUYS SHALL BE REJECTED.			
7.1.	ALL AREAS NOT USED FOR BUILDINGS, VEHICULAR USE AREAS, WALKS OR PLANTING BEDS SHALL BE GRASSED. GRASSING SHALL EXTEND TO ANY ABUTTING STREET PAVEMENT EDGE AND TO THE MEAN WATERLINE OF ANY ABUTTING CANAL, LAKE OR WATERWAY. REFER TO PLANTING SCHEDULE FOR ESTIMATED QUANTITY AND SPECIES.			
8. <u>MU</u> 8.1.	<u>ULCH &amp; FERTILIZER</u> ALL PLANTING BEDS AND WATER BASINS FOR TREES SHALL BE COVERED WITH A 3" MINIMUM DEPTH OF SHREDDED FLORI-MULCH, MELALEUCA OR EUCALYPTUS MULCH GRADE 'B' OR BETTER, UNLESS OTHERWISE SPECIFIED.			CLIENT
8.2.	INDIVIDUAL TREES PLANTED IN LAWN AREAS SHALL BE MULCHED WITH A MINIMUM 3' DIAMETER MULCH RING.			S C S
8.3. 8.4.	MULC H SHALL NOT BE INSTALLED WITHIN 3" OF TREE TUNKS. FERTILIZER MIX AS FOLLOWS:			PALIN CONTRACTOR
8.4.1 8.4.2				HACH COOL
8.4.3				PROJECT INFORMATION
9. <u>WF</u> 9.1.	<u>ATERING</u> ALL LANDSCAPED AREAS WITHIN THE COMMUNITY CENTER SITE WILL BE IRRIGATED BY AN			RIVIERA BEACH
	UNDERGROUND, AUTOMATIC, RUST-FREE IRRIGATION SYSTEM PROVIDING 100% COVERAGE AND 50% SPRAY OVERLAP. THE SYSTEM SHALL BE MAINTAINED IN GOOD WORKING ORDER AND DESIGNED TO MINIMIZE WATER ON IMPERVIOUS SERVICES AND NOT OVERSPRAY WALKWAYS. A RAIN SENSOR DEVICE SHALL BE INSTALLED TO OVERRIDE THE IRRIGATION CYCLE OF THE SYSTEM WHEN			HEIGHTS COMMUNITY CENTER
9.2.	ADEQUATE RAINFALL HAS OCCURRED. ALL LANDSCAPE AREAS WITHIN THE OVERFLOW PARKING SITE SHALL BE HAND WATERED DURING			
	ESTABLISHMENT PERIOD. IN ACCORDANCE WITH IFAS PUBLICATION #ENH85 "IRRIGATING LANDSCAPE PLANTS DURING ESTABLISHMENT" (https://edis.ifas.edu/ep113).			RIVIERA BEACH, FL PROJECT NUMBER
9.3.	ALL PLANT MATERIAL SHALL BE WATERED IN AT TIME OF PLANTING IN ACCORDANCE WITH STANDARD NURSERY PRACTICES. IN ADDITION, CONTRACTOR WILL CONTINUE THE WATERING OF			15.221.002 CLIENT PROJECT NUMBER
	PLANT MATERIAL UNTIL SUBSTANTIAL COMPLETION AND THE LANDSCAPE IS TURNED OVER TO THE OWNER.			
10. <u>PR</u>	OJECT CLOSEOUT			VERIFY SCALES 0 1"
10.1.	DURING CONSTRUCTION, THE PROJECT SITE AND ALL ADJACENT AREAS SHALL BE MAINTAINED IN A NEAT AND CLEAN MANNER. UPON FINAL CLEAN UP, THE PROJECT SITE SHALL BE LEFT CLEAR OF ALL SURPLUS MATERIAL OR TRASH. THE PAVED AREAS SHALL BE SWEPT BROOM CLEAN.			IF NOT ONE INCH ON THIS SHEET, ADJUST SCALES ACCORDINGLY REVISIONS
10.2.	THE CONTRACTOR SHALL RESTORE, REPLACE OR AS DIRECTED BY THE LANDSCAPE ARCHITECT, ANY PUBLIC OR PRIVATE PROPERTY DAMAGED BY THE WORK OF THE CONTRACTOR, HIS EQUIPMENT, EMPLOYEES OR THOSE OF HIS SUB-CONTRACTORS. THIS WORK SHALL BE RESTORED TO A CONDITION EQUAL TO OR BETTER THAN THAT OF THE EXISTING ADJACENT AREAS. THE RESTORATION WORK SHALL			
	BE AT THE CONTRACTOR'S EXPENSE. SUITABLE MATERIALS AND METHODS SHALL BE USED FOR SUCH RESTORATION.			
10.3.	WHERE MATERIAL OR DEBRIS HAS WASHED OR FLOWED INTO OR BEEN PLACED IN WATER COURSES, DITCHES, DRAINS, CATCH BASINS, OR ELSEWHERE AS A RESULT OF THE CONTRACTOR'S OPERATIONS, SUCH MATERIAL OR DEBRIS SHALL BE REMOVED AND SATISFACTORILY DISPOSED OF DURING			DATE OF ISSUE
10.4.	PROGRESS OF THE WORK. THESE AREAS SHALL BE KEPT IN A CLEAN AND NEAT CONDITION. THE CONTRACTOR SHALL MAINTAIN ACCURATE AND COMPLETE RECORDS OF WORK ITEMS			01/30/17 DESIGNED BY
10.5.	COMPLETED. UPON COMPLETION OF CONSTRUCTION, THE CONTRACTOR SHALL SUBMIT TO THE LANDSCAPE ARCHITECT OF RECORD COMPLETE SETS OF "AS-BUILT" CONSTRUCTION DRAWINGS. THESE			JS
	ARCHITECT OF RECORD COMPLETE SETS OF "AS-BUILT" CONSTRUCTION DRAWINGS. THESE DRAWINGS SHALL BE MARKED TO SHOW "AS-BUILT" CONSTRUCTION CHANGES AND DIMENSIONED LOCATIONS AND ELEVATIONS OF ALL IMPROVEMENTS INCLUDING PRODUCT/EQUIPMENT AS			DRAWN BY JS
	SPECIFIED OR REVISED DURING THE SHOP DRAWING SUBMITTAL PROCESS. AS-BUILT DRAWINGS SHALL BE SIGNED AND SEALED BY A FLORIDA REGISTERED LAND SURVEYOR.			CHECKED BY EH
	JARANTEE			DRAWING TITLE
11.1.	ALL NEW PLANT MATERIAL SHALL BE GUARANTEED FOR 1 YEAR FROM TIME OF FINAL ACCEPTANCE OF PROJECT. ANY PLANT MATERIAL NOT IN A HEALTHY GROWING CONDITION WILL BE REPLACED IN			LANDSCAPE
	KIND BY THE CONTRACTOR AT NO ADDITIONAL COST TO THE OWNER WITHIN 10 DAYS OF NOTIFICATION.			SPECIFICATIONS
				DRAWING NUMBER



## VIEW FROM SOUTHEAST

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## VIEW FROM NORTHEAST

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## VIEW FROM SOUTHWEST

VIEW FROM NORTHWEST



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CONSULTANT:





## RIVIERA BEACH HEIGHTS COMMUNITY CENTER

594 W 4TH ST. RIVIERA BEACH, FL, 33404

DATE:	03/02/17
NUMBER:	A15-011
REVIEWED:	MW
MANAGED:	PG
DRAWN:	BG
REVISION:	

## RENDERINGS

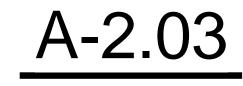

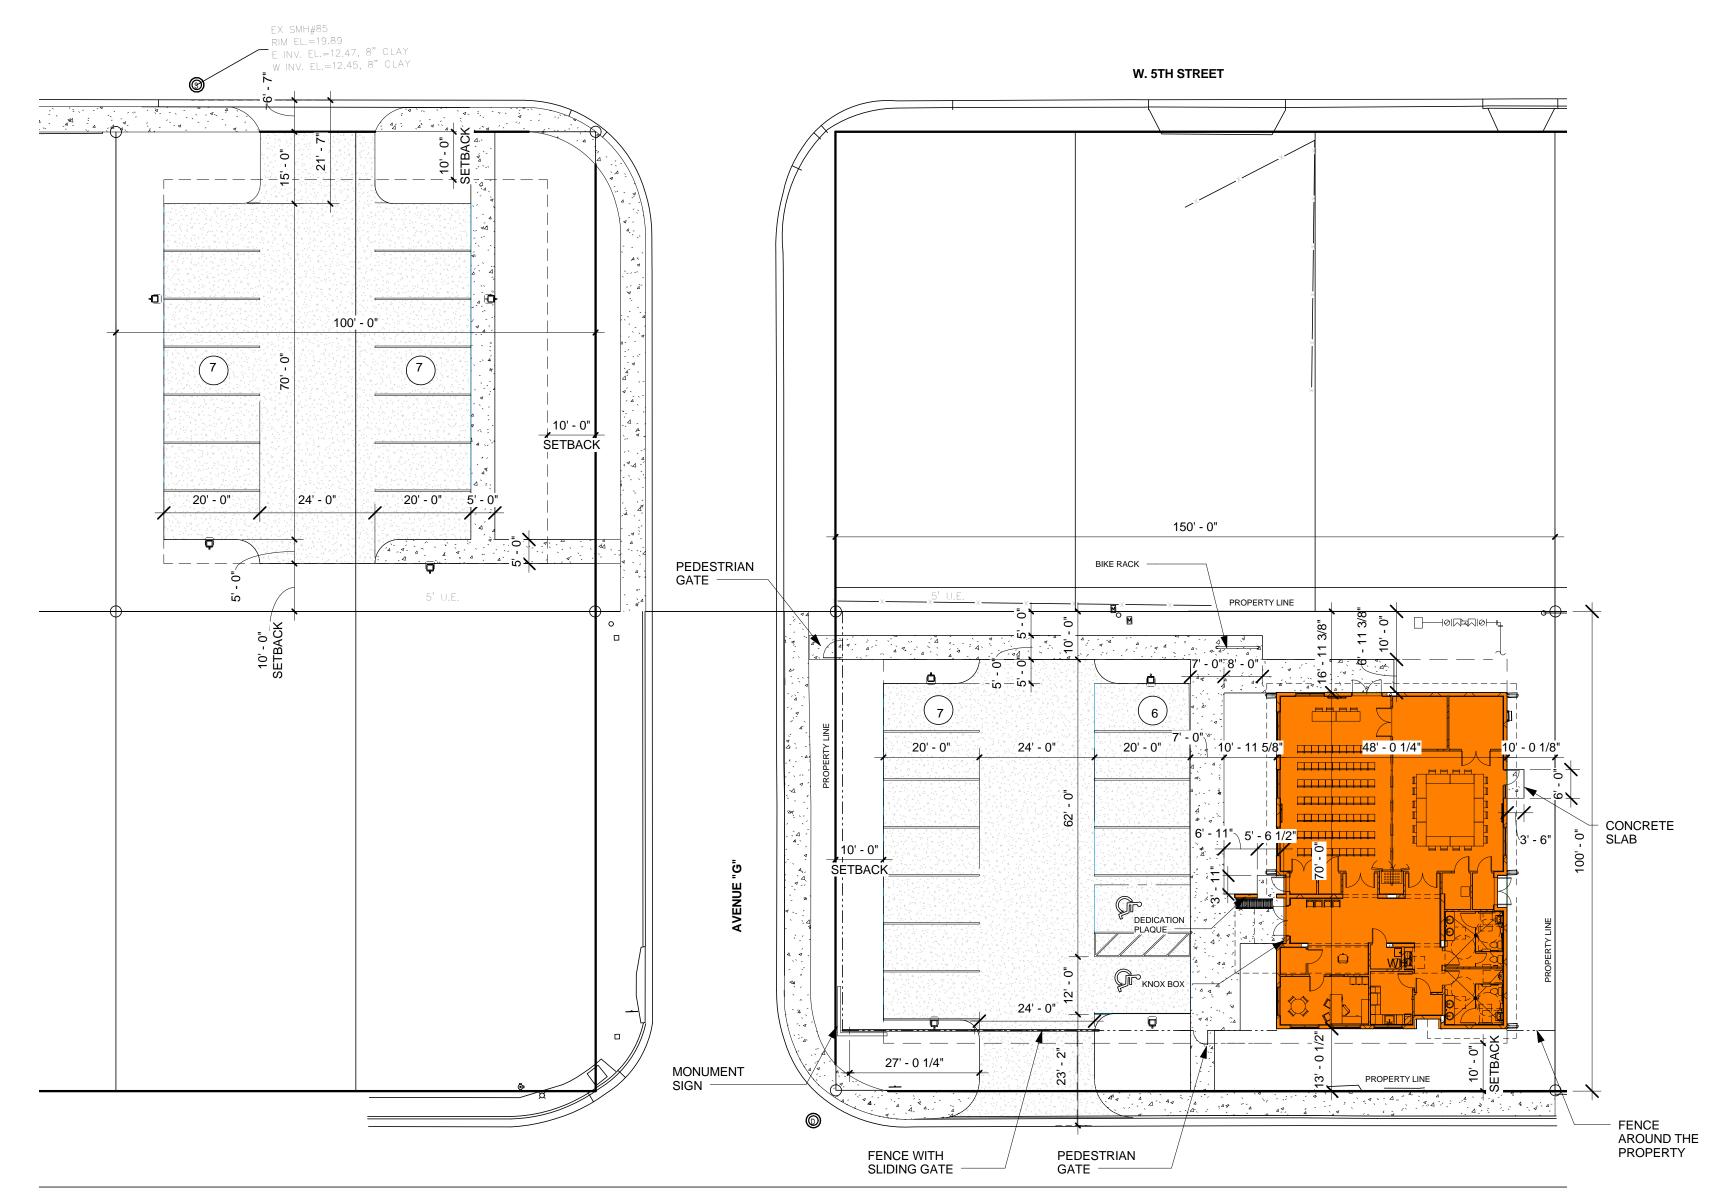



+

+

+

W. 4TH STREET

+

+

+

## SITE PLAN NOTES:

1. ARCHITECTURAL SITE PLAN FOR REFERENCE ONLY - SEE CIVIL & LANDSCAPE/LAND PLANNER DRAWINGS FOR DETAILED SITE INFORMATION.

2. SEE LANDSCAPE PLANS FOR LANDSCAPE AND HARDSCAPE INFORMATION.

 COORDINATE WITH MEP AND CIVIL PLANS FOR SYSTEMS LOCATIONS AND DETAILS.
 COORDINATE WITH STRUCTURAL PLANS FOR FOUNDATIONS AND ADDITIONAL INFORMATION.

5. SIZE OF TYPICAL OFF-STREET PARKING SPACES - SEE TYPICAL HANDICAPPED PARKING DETAIL: SEE CIVIL

6. ALL SIDEWALKS, CURBS, AND ROADWAY DRAINAGE DAMAGED DURING CONSTRUCTION SHALL BE REPAIRED IN CONFORMANCE WITH THE LAND DEVELOPMENT REGULATIONS AS DETERMINED BY THE CITY ENGINEER

7. SEE CIVIL DRAWINGS FOR CONTROL JOINT DETAILS FOR CONCRETE PAVING AND SIDEWALKS.



WEST ARCHITECTURE + DESIGN, LLC AA26001503

318 SOUTH DIXIE HIGHWAY SUITE 4-5 LAKE WORTH FL 33460 561-588-2027 T 561-582-9419 F

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CONSULTANT:

NEW DEVELOPMENT FOR:

## RIVIERA BEACH HEIGHTS COMMUNITY CENTER


594 W 4TH ST. RIVIERA BEACH, FL, 33404


DATE:	03/02/17
NUMBER:	A15-011
REVIEWED:	MW
MANAGED:	PG
DRAWN:	DA

**REVISION**:

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## ARCHITECTURAL SITE PLAN



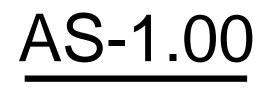

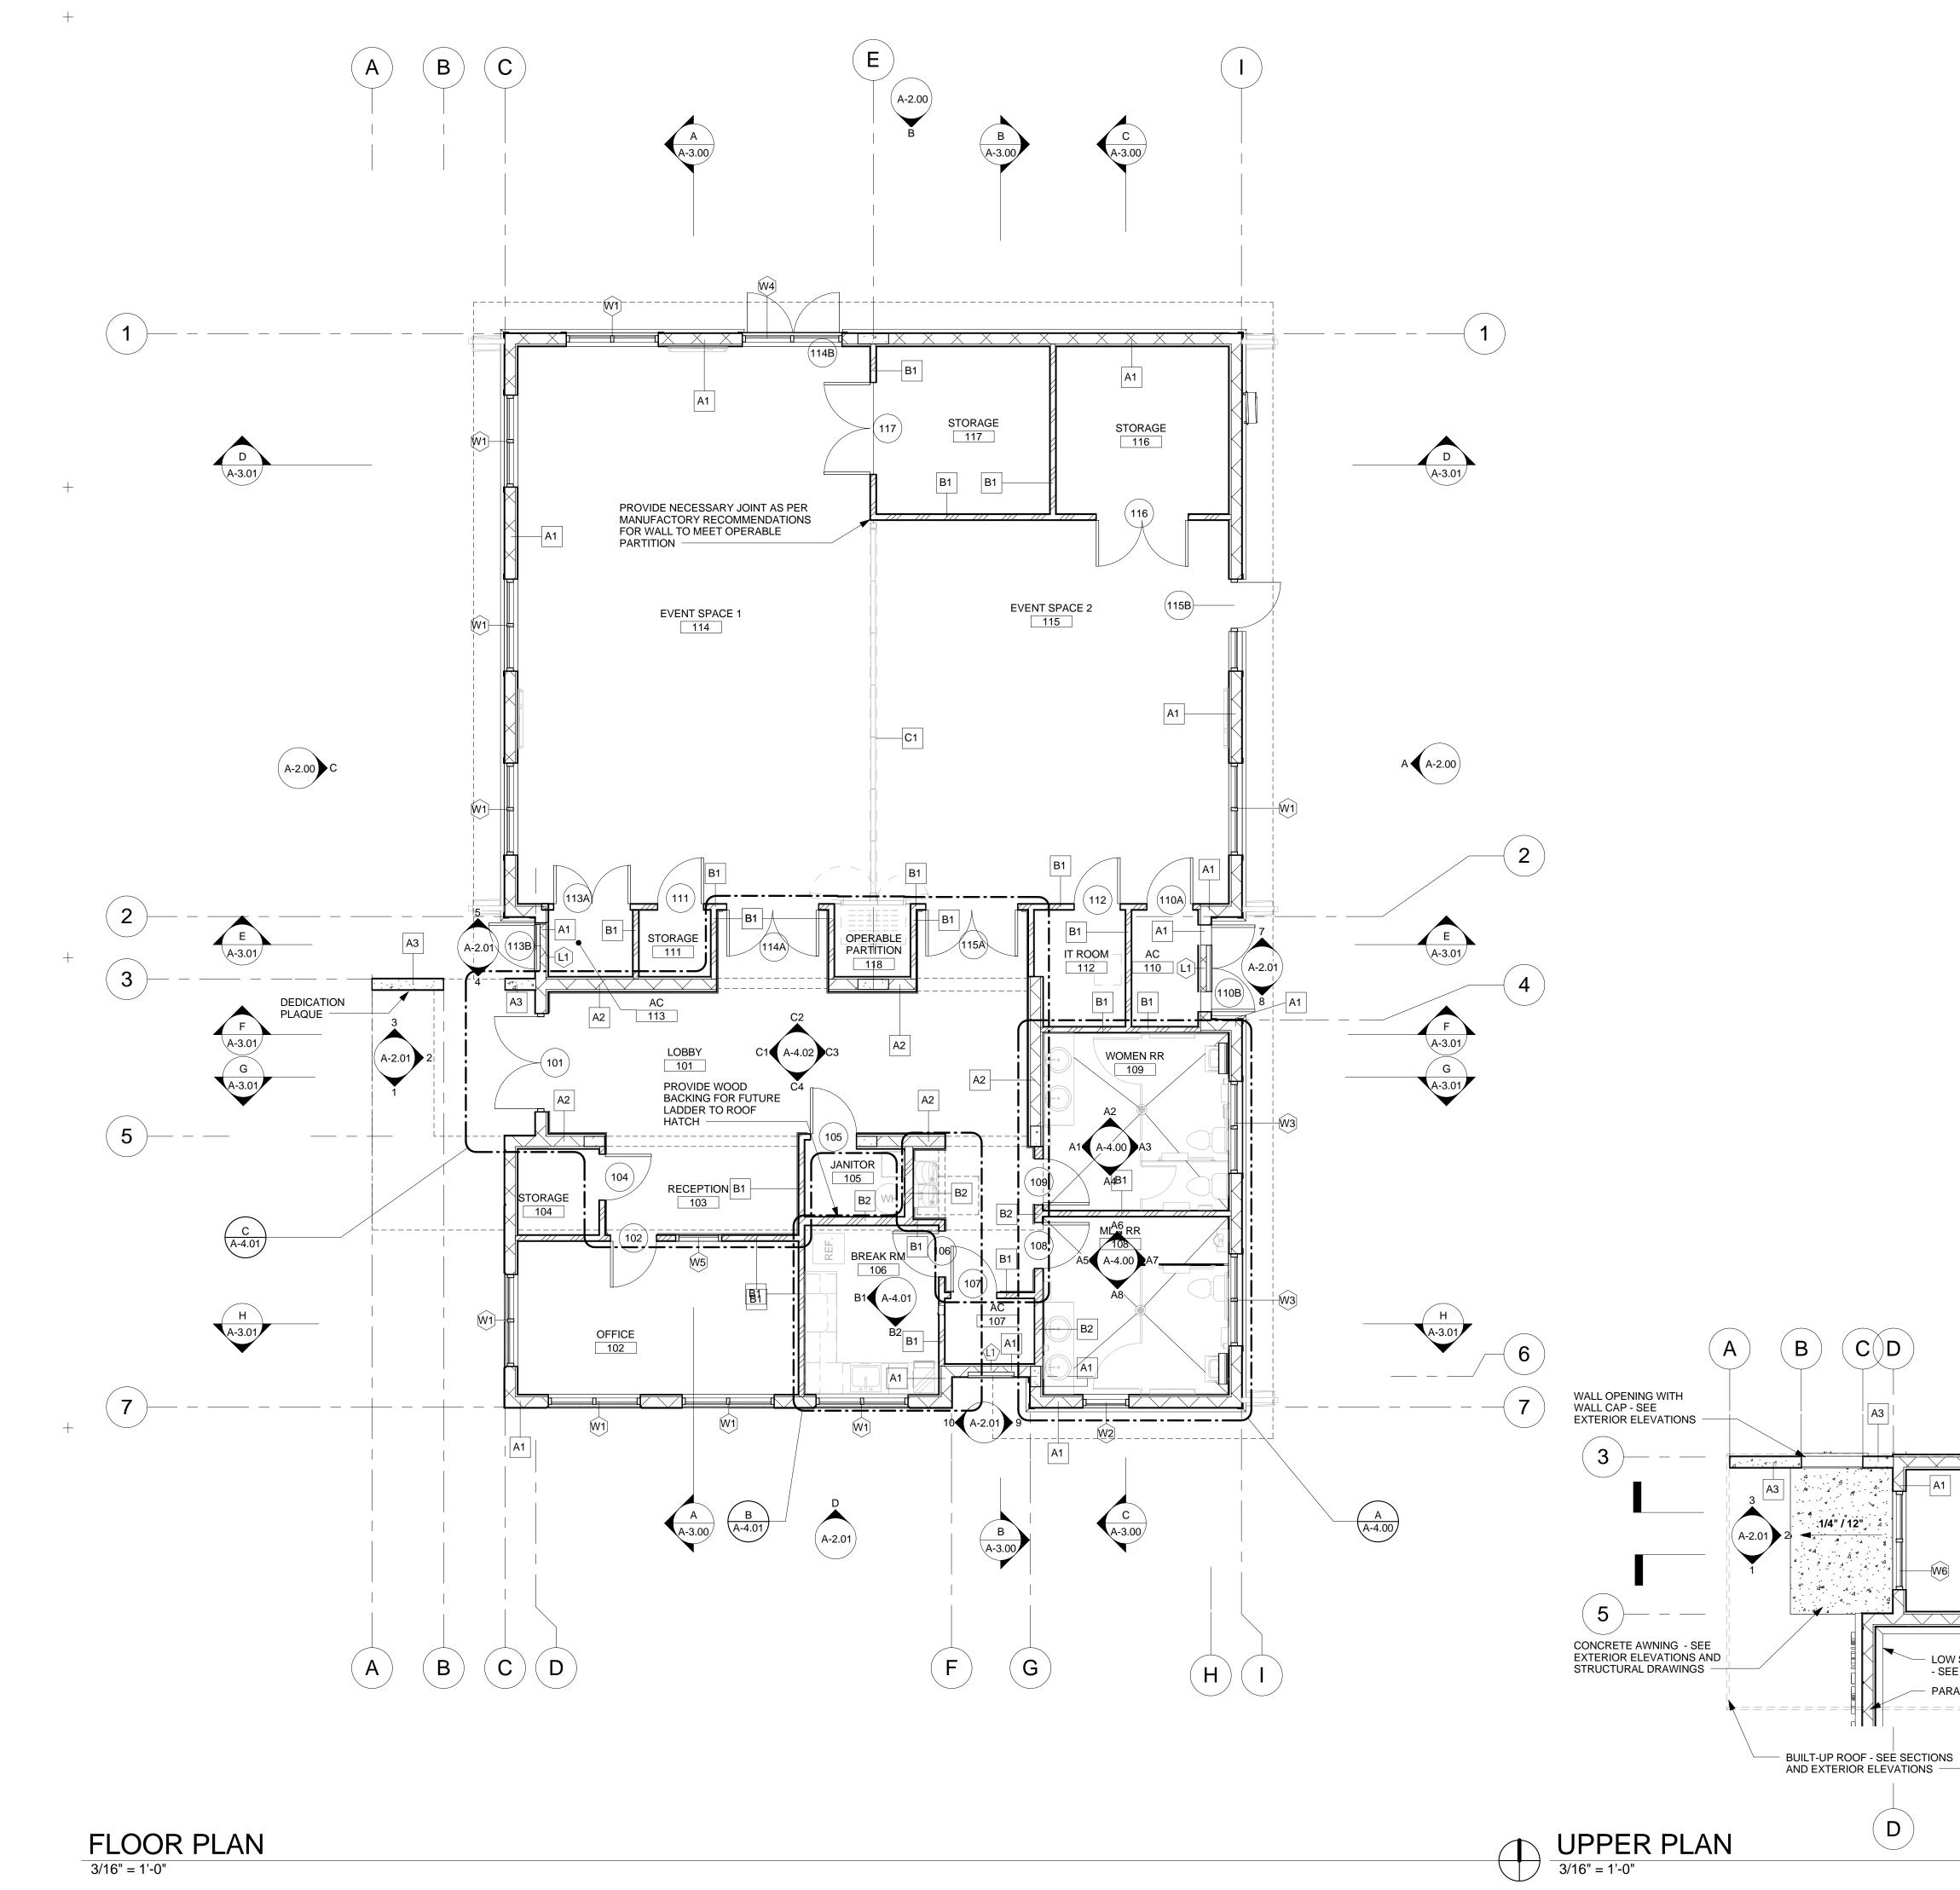+

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## FLOOR PLAN NOTES:

1. ASSEMBLY OCCUPANCIES OVER 50 PEOPLE SHALL POST OCCUPANCY LOAD SIGNAGE, LIFE SAFETY INSTRUCTIONS AND LIFE SAFETY DIAGRAMS.

- 2. FIRE ALARM SHALL COMPLY WITH NFPA 72.
- 3. KNOX BOX SHALL BE INSTALLED.

4. CONTRACTORS TO VERIFY ALL FIELD CONDITIONS PRIOR TO COMMENCEMENT AND REPORT ANY DISCREPANCIES TO THE ARCHITECT

5. PROVIDE SOLID WOOD BACKING FOR ALL WALLS TO RECEIVE COUNTERS CABINETS, DOOR STOPS, SINKS, TOILET ACCESSORIES, CHAIR RAILS, AND OTHER RELATED INSTALLATIONS. THE INSTALLATIONS SHALL BE INSPECTED BY THE ARCHITECT PRIOR TO COVERING WITH DRYWALL

- 6. PROVIDE MOISTURE RESISTANCE GYPSUM BOARD IN RESTROOMS.
- 7. LEVEL 4 FINISH ON ALL GYPSUM BOARD PARTITIONS.



WEST ARCHITECTURE + DESIGN, LLC AA26001503

318 SOUTH DIXIE HIGHWAY SUITE 4-5 LAKE WORTH FL 33460 561-588-2027 T 561-582-9419 F

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CONSULTANT

## WALL LEGEND

——A1	7-5/8" MASONRY WALL W/ 1-5/8" METAL FURRING (24" O.C), W/ MINIMUM R8 INSULATION AND 5/8" GYPSUM BOARD ON INTERIOR AND WATERPROOFING AND STUCCO FINISH ON EXTERIOR
——A2	7-5/8" MASONRY WALL W/ 1-1/2" METAL STUDS (24" O.C), W/ MINIMUM R8 INSULATION AND 5/8" GYPSUM BOARD ON BOTH SIDES
	7-5/8" POUR CONCRETE SEE STRUCTURAL. W/ PAINTED STUCCO FINISH ON BOTH SIDES
——B1	4-7/8" INTERIOR PARTITION W/ 3-5/8" 25GA. METAL STUDS @ 16" O.C W/ INSULATION R13 AND 5/8" GYPSUM BOARD ON BOTH SIDES - PROVIDE DIAGONAL BRACING TO STRUCTURE ABOVE
——B2	7-1/4" INTERIOR PARTITION W/ 6" 25GA. METAL STUDS @ 16" O.C W/ INSULATION R19 AND 5/8" GYPSUM BOARD ON BOTH SIDES - PROVIDE DIAGONAL BRACING TO STRUCTURE ABOVE
	OPERABLE PARTITION HUFCORE SERIES: 642, 54 STC WITH TOP AND BOTTOM MECHANICAL SEALS. ONE (1) 25'-0" W X 14'-10" H. WITH ONE TYPE II POCKET DOOR OR APPROVED EQUAL

NEW DEVELOPMENT FOR:

## **RIVIERA** BEACH HEIGHTS COMMUNITY CENTER

594 W 4TH ST. RIVIERA BEACH, FL, 33404

DATE:	03 / 02 / 17
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REVISION	

G REVISION: 3  $\vee \vee \vee \vee \vee \vee \vee \vee \vee$ A1 A1 -\A-3.01/ G 5 LOW SLOPED ROOF FLOOR PLAN ( A-2.02 PARAPET. SEE SECTIONS (A) (A-3.00) G  $\square$ A-1

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## CITY OF RIVIERA BEACH STAFF REPORT, SP-15-15 RIVIERA BEACH HEIGHTS COMMUNITY CENTER PLANNING AND ZONING BOARD – JANUARY 14, 2016

A SITE PLAN APPLICATION (SP-15-15) FOR THE CITY INITIATED RIVIERA BEACH HEIGHTS COMMUNITY CENTER, A MULTI-PURPOSE COMMUNITY ACTIVITY BUILDING, APPROXIMATELY 3,500 SQUARE FEET IN AREA, LOCATED ON VACANT LAND AT THE NORTHEAST CORNER OF WEST 4<sup>TH</sup> STREET AND AVENUE 'G'.

- **A. Applicants:** City of Riviera Beach.
- **B. Request:** The City desires to develop a 3,500 square foot multi-purpose community center on parcels which are currently vacant (see attached plans).
- **C. Location:** The community center is proposed at the northeast corner of West 4<sup>th</sup> Street and Avenue 'G'. Overflow parking is proposed at the southwest corner of West 5<sup>th</sup> Street and Avenue 'G' (see attached location map).
- **D.** Property Description and Uses: The subject property description / uses are as follows:

Parcel Control Numbers:	56-43-42-33-09-000-0520; 56-43-42-33-09-000-0510 & 56-43-42-33-08-000-0310
Parcel Size:	+/- 0.22; 0.23; 0.11 Acres (0.56 Total Acres)
Existing Use:	Vacant.
Zoning:	RS-8 Single Family Dwelling District (Proposed Amendment to Community Facility)
Future Land Use:	Single Family Residential (Proposed Amendment to Community Facilities)

## E. Adjacent Property Description and Uses:

- <u>North:</u> Single Family Residences / Vacant Property, RS-8 Zoning Designation.
- South: Single Family Residences, RS-8 Zoning Designation.
- East: Single Family Residences, RS-8 Zoning Designation.
- <u>West:</u> Single Family Residences, RS-8 Zoning Designation.

## F. Background:

Residents within the Riviera Beach Heights Community desire a community facility for various activities and events. Construction of a community center would satisfy this request and also function as a neighborhood anchor fostering a greater sense of place. City Council members have supported this proposal by way of funding allocations and initiating site plan development.

Historically FDOT acquired property in the Riviera Beach Heights Neighborhood in association with the SR 710 (Dr. MLK Jr. Hwy.) roadway improvement project. FDOT did not utilize all properties acquired and is willing to transfer this land to the City of Riviera Beach so long as it is utilized for a public purpose by the City in the future. The three aforementioned parcels (PCN's listed above) are all currently owned by FDOT and will be transferred to the City (see attached FDOT Parcel Map).

Please note that a Community Meeting was held on December 9, 2015 at 6:30 PM within the City's Public Services Complex; meeting minutes have been attached.

## G. Staff Analysis:

**Proposed Use:** A +/- 3,500 square foot multi-purpose community center.

**Zoning Regulations:** The zoning designation and map shall be amended to CF - Community Facility in order to accommodate this use.

**Comprehensive Plan:** The future land use designation and map shall be amended to CF – Community Facilities in order to accommodate this use.

Levels of Service: Customary services such as water, sewer, roads and garbage collection are currently available to the site.

**Landscaping:** A landscape plan was provided and new landscaping will be installed according to City landscape code requirements.

**Parking/Traffic:** The City Code requires 1 space per every 200 sq. ft. of building area (3500 / 200 = 17.5 parking spaces) and 27 spaces have been provided (including 2 accessible spaces). On average, this proposal is estimated to generate a minimal number of trips per day and is not anticipated to have any negative traffic impact within the community.

- **H. Recommendation:** Staff recommends approval of the City of Riviera Beach site plan application with the following conditions:
  - 1. A two-year landscape performance bond for 100% of the value of landscaping and irrigation is required prior to issuance of a certificate of occupancy.
  - 2. Construction must be initiated within 18 months of the effective date of the adopting Resolution in accordance with Section 31-60(b), of the City Code of Ordinances. Demolition, site preparation or land clearing shall not be considered construction. Building permit application and associated plans and documents shall be submitted in its entirety and shall not be accepted by City staff in a partial or incomplete manner.
  - 3. All future advertising must state that the development is located in the City of Riviera Beach. Fees and penalties in accordance with City Code Sec. 31-554 will be levied against the property owner and/or business for violation of this condition.
  - 4. This development must receive final Certificate of Occupancy from the City for all buildings and units approved within five years of the approval of the adopting resolution or the adopting resolution shall be considered null and void, requiring the applicant to resubmit application for site plan approval and re-initiate the site plan approval process.

continued on next page

5. Once approved, the City Council authorizes City staff to approve future amendments to this site plan administratively so long as the site plan does not deviate greater than 5% from the originally approved submittal.

## RESOLUTION NO. <u>14–16</u>

A RESOLUTION OF THE CITY COUNCIL OF THE CITY OF RIVIERA BEACH, PALM BEACH COUNTY, FLORIDA, APPROVING A SITE PLAN APPLICATION FOR THE CITY INITIATED RIVIERA BEACH HEIGHTS COMMUNITY CENTER, **MULTI-PURPOSE** Α COMMUNITY ACTIVITY BUILDING, APPROXIMATELY 3.500 SQUARE FEET IN AREA, LOCATED ON VACANT LAND AT THE NORTHEAST CORNER OF WEST 4<sup>TH</sup> STREET AND AVENUE 'G'; PROVIDING FOR CONDITIONS OF APPROVAL; AND PROVIDING FOR AN EFFECTIVE DATE.

WHEREAS, the residents of the Riviera Beach Heights neighborhood have requested a community facility in order to provide a space for various events and activities; and

WHEREAS, construction of a neighborhood community center would satisfy the residents' requests and also function as a neighborhood anchor, fostering a greater sense of place; and

**WHEREAS,** the City Council has supported this proposal and encouraged project approval and implementation; and

**WHEREAS,** the Florida Department of Transportation has committed to donating land for construction of the community center; and

WHEREAS, a public informational meeting was held on December 9, 2015 to discuss this project and there was overwhelming support of the community center proposal; and

**WHEREAS,** this proposal has been reviewed interdepartmentally by City staff and there are no outstanding staff questions or comments; and

**WHEREAS,** on January 14, 2016, the Planning and Zoning Board reviewed this project proposal and unanimously recommend approval.

NOW, THEREFORE, BE IT RESOLVED BY THE CITY COUNCIL OF THE CITY OF RIVIERA BEACH, PALM BEACH COUNTY, FLORIDA, AS FOLLOWS:

## RESOLUTION NO. <u>14–16</u> PAGE 2 of 3

**SECTION 1.** The City Council hereby approves the City initiated application for site plan approval (SP-15-15), for a +/- 3500 square foot community center, located on three parcels of land, known by parcel control numbers 56-43-42-33-09-000-0520; 56-43-42-33-09-000-0510 & 56-43-42-33-08-000-0310, on +/- 0.56 acres, within the Riviera Beach Heights Neighborhood, situated on the northeast corner of West 4<sup>th</sup> Street and Avenue "G", with overflow parking at the southwest corner of West 5<sup>th</sup> Street and Avenue "G", with the following conditions:

- 1. This development must receive final Certificate of Occupancy from the City within five years of the approval of this resolution (by February 3, 2021) or the resolution shall be considered null and void, requiring the applicant to resubmit application for site plan approval and re-initiate the site plan approval process.
- 2. Once approved, the City Council authorizes City staff to approve future amendments to this site plan administratively so long as the site plan does not deviate greater than 5% from the originally approved submittal

**SECTION 2.** The associated site plan and landscape plan are attached hereto and shall be archived as part of this resolution as Exhibit "A" and Exhibit "B".

**SECTION 3.** This Resolution shall take effect immediately upon passage and approval by City Council.

PASSED and APPROVED this <u>3<sup>RD</sup></u> day of <u>FEBRUARY</u>, 2016.

[ REMAINDER OF PAGE INTENTIONALLY BLANK ]

## RESOLUTION NO. <u>14–16</u> PAGE 3 of 3

**APPROVED:** 

ma. Ma

THOMAS A. MASTERS

ATTEST:

CLAUDENE L. ANTHONY CERTIFIED MUNICIPAL CLERK CITY CLERK

The Marts

DAWN S. PARDO CHAIRPERSON

TERENCE D. DAVIS CHAIR PRO TEM

BRUCE A. GUYTON COUNCILPERSON

**KASHAMBA L. MILLER-ANDERSON** 

COUNCILPERSON


CEDRICK A. THOMAS COUNCILPERSON

MOTIONED BY:	<u> </u>	HOMAS	
SECONDED BY:	B. (	GUYTON	
B. GUYTON		AYE	
K. MILLER-ANDER	SON	NAY	
C. THOMAS		AYE	_
D. PARDO		AYE	
T. DAVIS		AYE	

**REVIEWED AS TO LEGAL SUFFICIENCY** 

amil H. Ry PAMALA H. RYAN, B.C.S., CITY ATTORNEY

2/2/16 DATE:

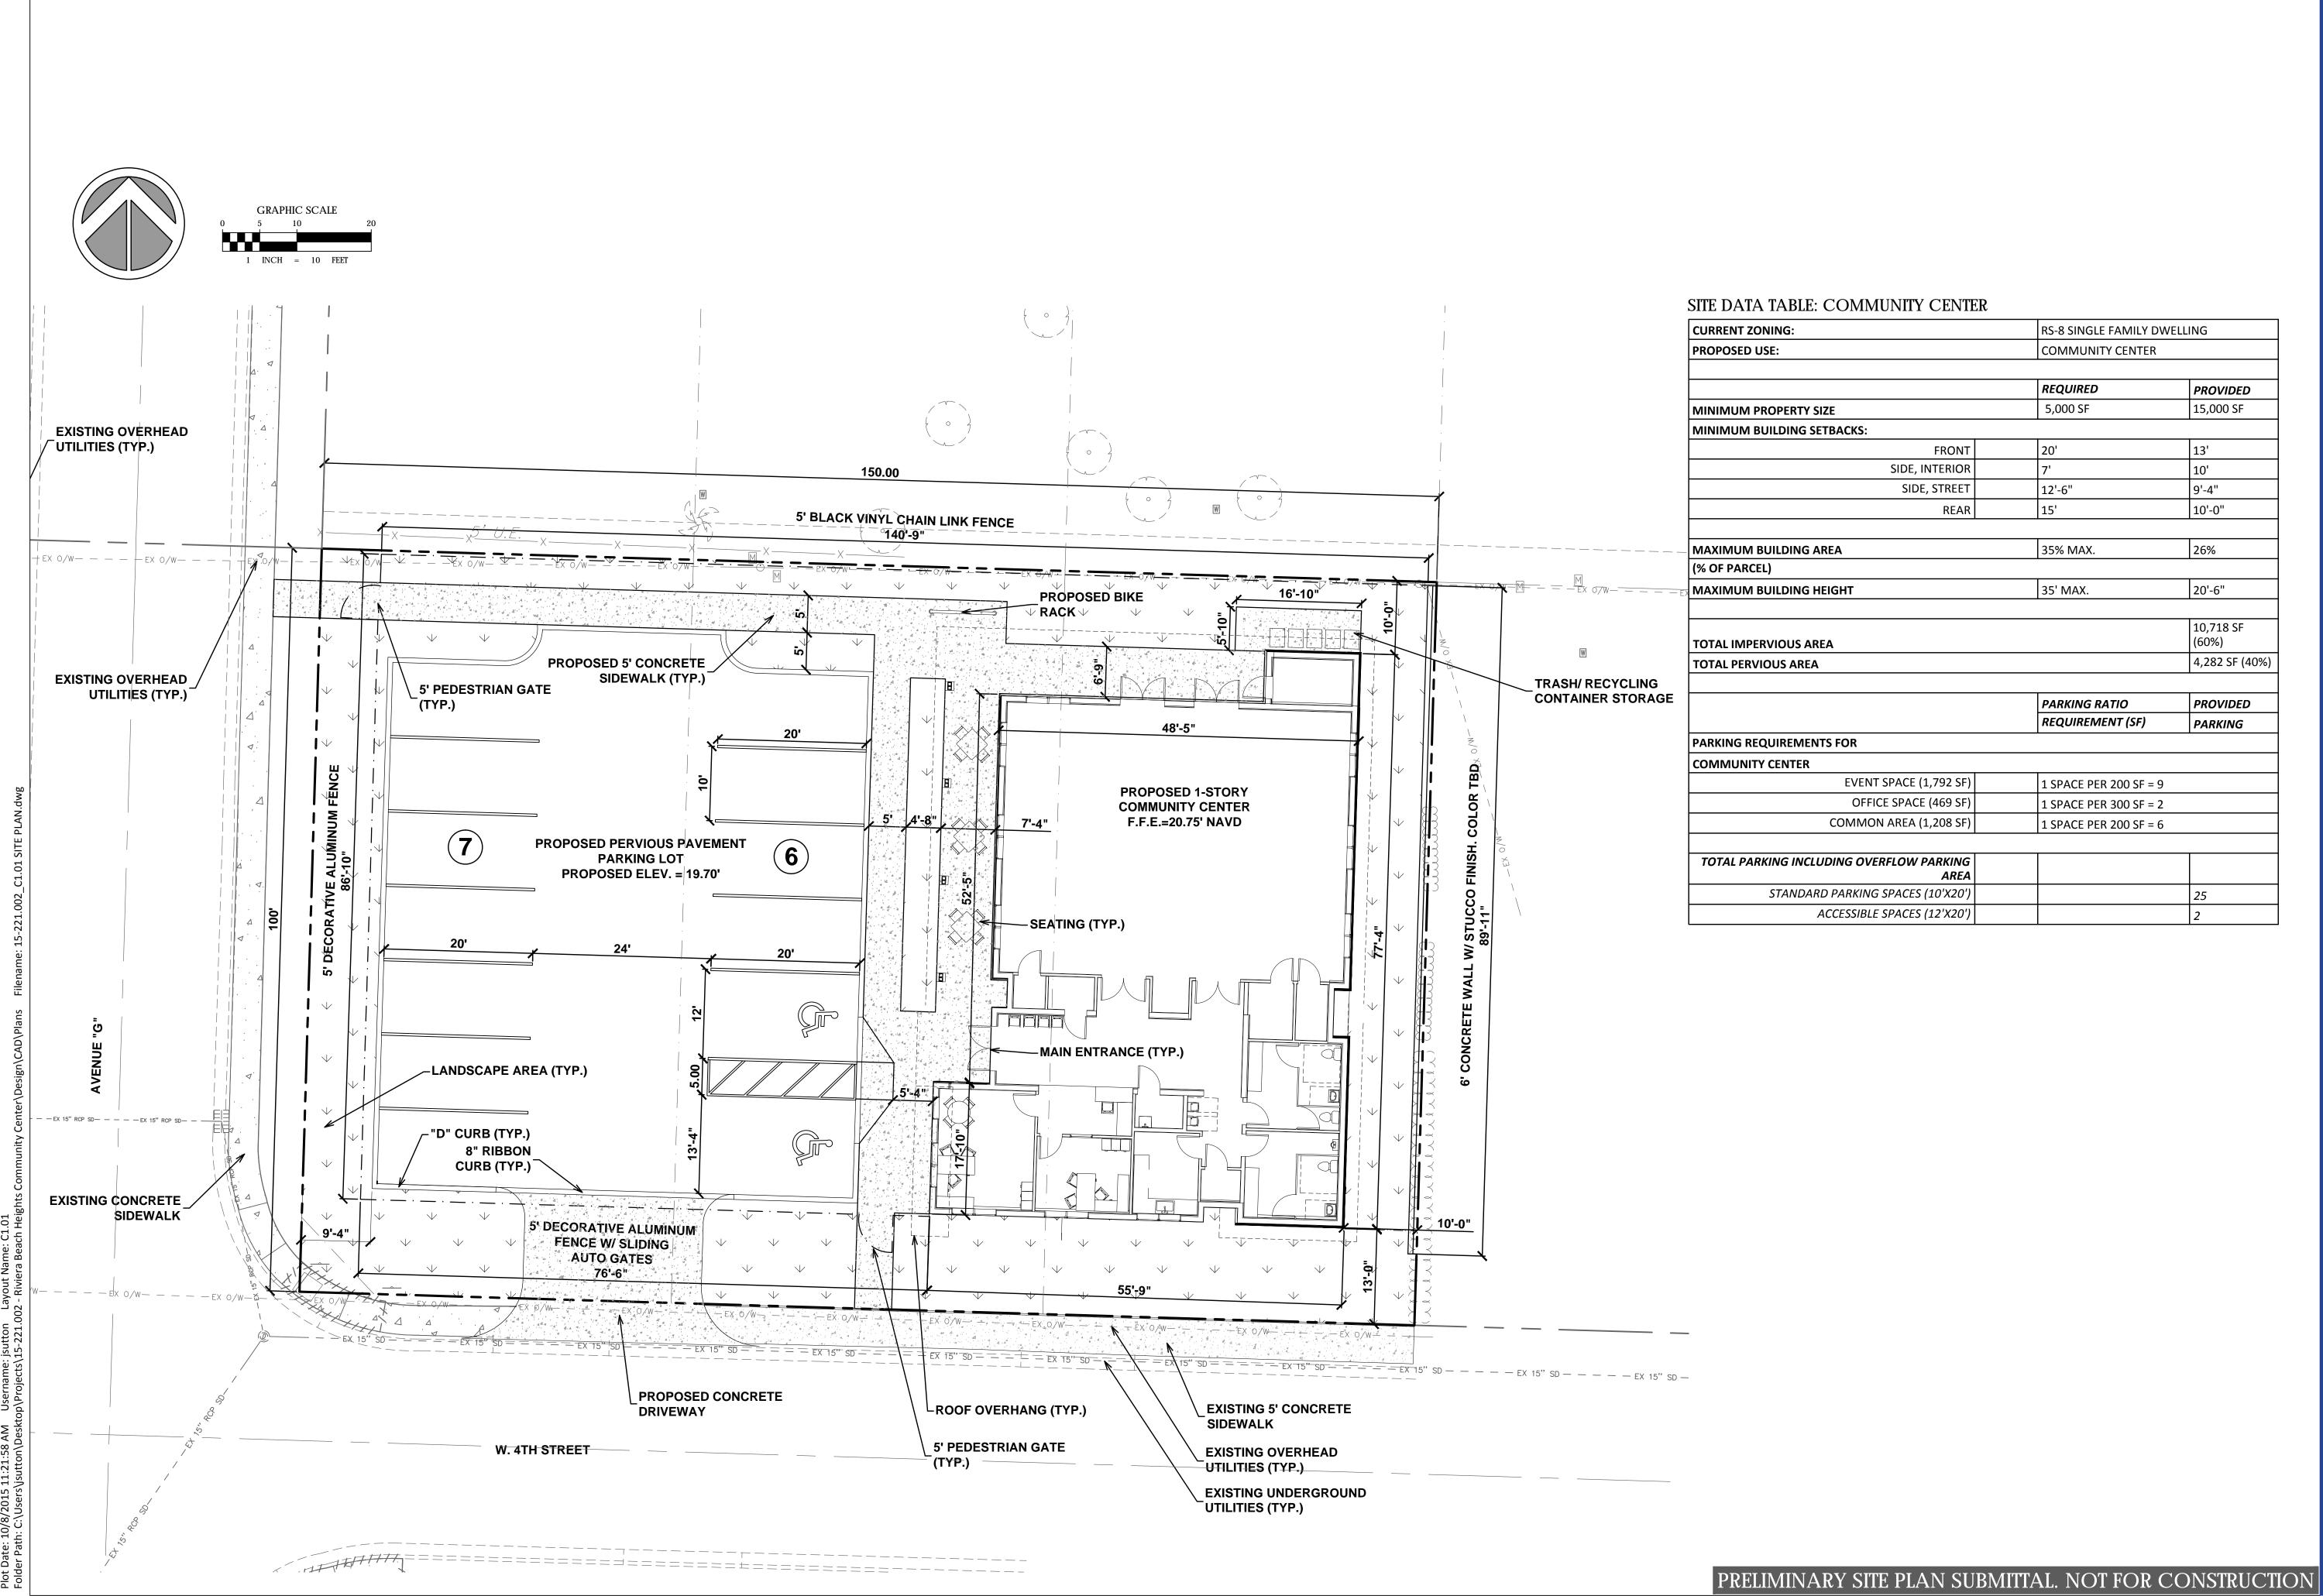

# City Council EHXIBIT "A"



&ASSOCIATES 500 Australian Avenue South Suite 530 West Palm Beach, FL 33401 561.746.6900 www.chenmoore.com **CERTIFICATES OF AUTHORIZATION** EB4593 LC26000425

REGISTRATION CRISTOBAL BETANCOURT **REGISTRATION NO. LA6666941** DATE: 10/08/15

## SITE DATA TABLE: COMMUNITY CENTER

۲ ZONING:	RS-8 SINGLE FAMILY DW	/ELLING
ED USE:	COMMUNITY CENTER	
	REQUIRED	PROVIDED
M PROPERTY SIZE	5,000 SF	15,000 SF
M BUILDING SETBACKS:		
FRONT	20'	13'
SIDE, INTERIOR	7'	10'
SIDE, STREET	12'-6"	9'-4"
REAR	15'	10'-0"
IM BUILDING AREA	35% MAX.	26%
RCEL)		
IM BUILDING HEIGHT	35' MAX.	20'-6"
/IPERVIOUS AREA		10,718 SF (60%)
ERVIOUS AREA		4,282 SF (40%)
	PARKING RATIO	PROVIDED
	REQUIREMENT (SF)	PARKING
REQUIREMENTS FOR		·
NITY CENTER		
EVENT SPACE (1,792 SF)	1 SPACE PER 200 SF = 9	
OFFICE SPACE (469 SF)	1 SPACE PER 300 SF = 2	
COMMON AREA (1,208 SF)	1 SPACE PER 200 SF = 6	
· · · · · · · · · · · · · · · · · · ·		
PARKING INCLUDING OVERFLOW PARKING AREA		
STANDARD PARKING SPACES (10'X20')		25
ACCESSIBLE SPACES (12'X20')		2

## SUB-CONSULTANT



PROJECT INFORMATION

## SOUTH SIDE COMMUNITY CENTER

RIVIERA BEACH, FL PROJECT NUMBER 15-221.002

CLIENT PROJECT NUMBER

VERIFY SCALES

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REVISIONS

DATE OF ISSUE

DESIGNED BY

10/08/15

EH

COMMUNITY


**CENTER SITE PLAN** 

DRAWN BY JS

CHECKED BY

DRAWING TITLE

DRAWING NUMBER

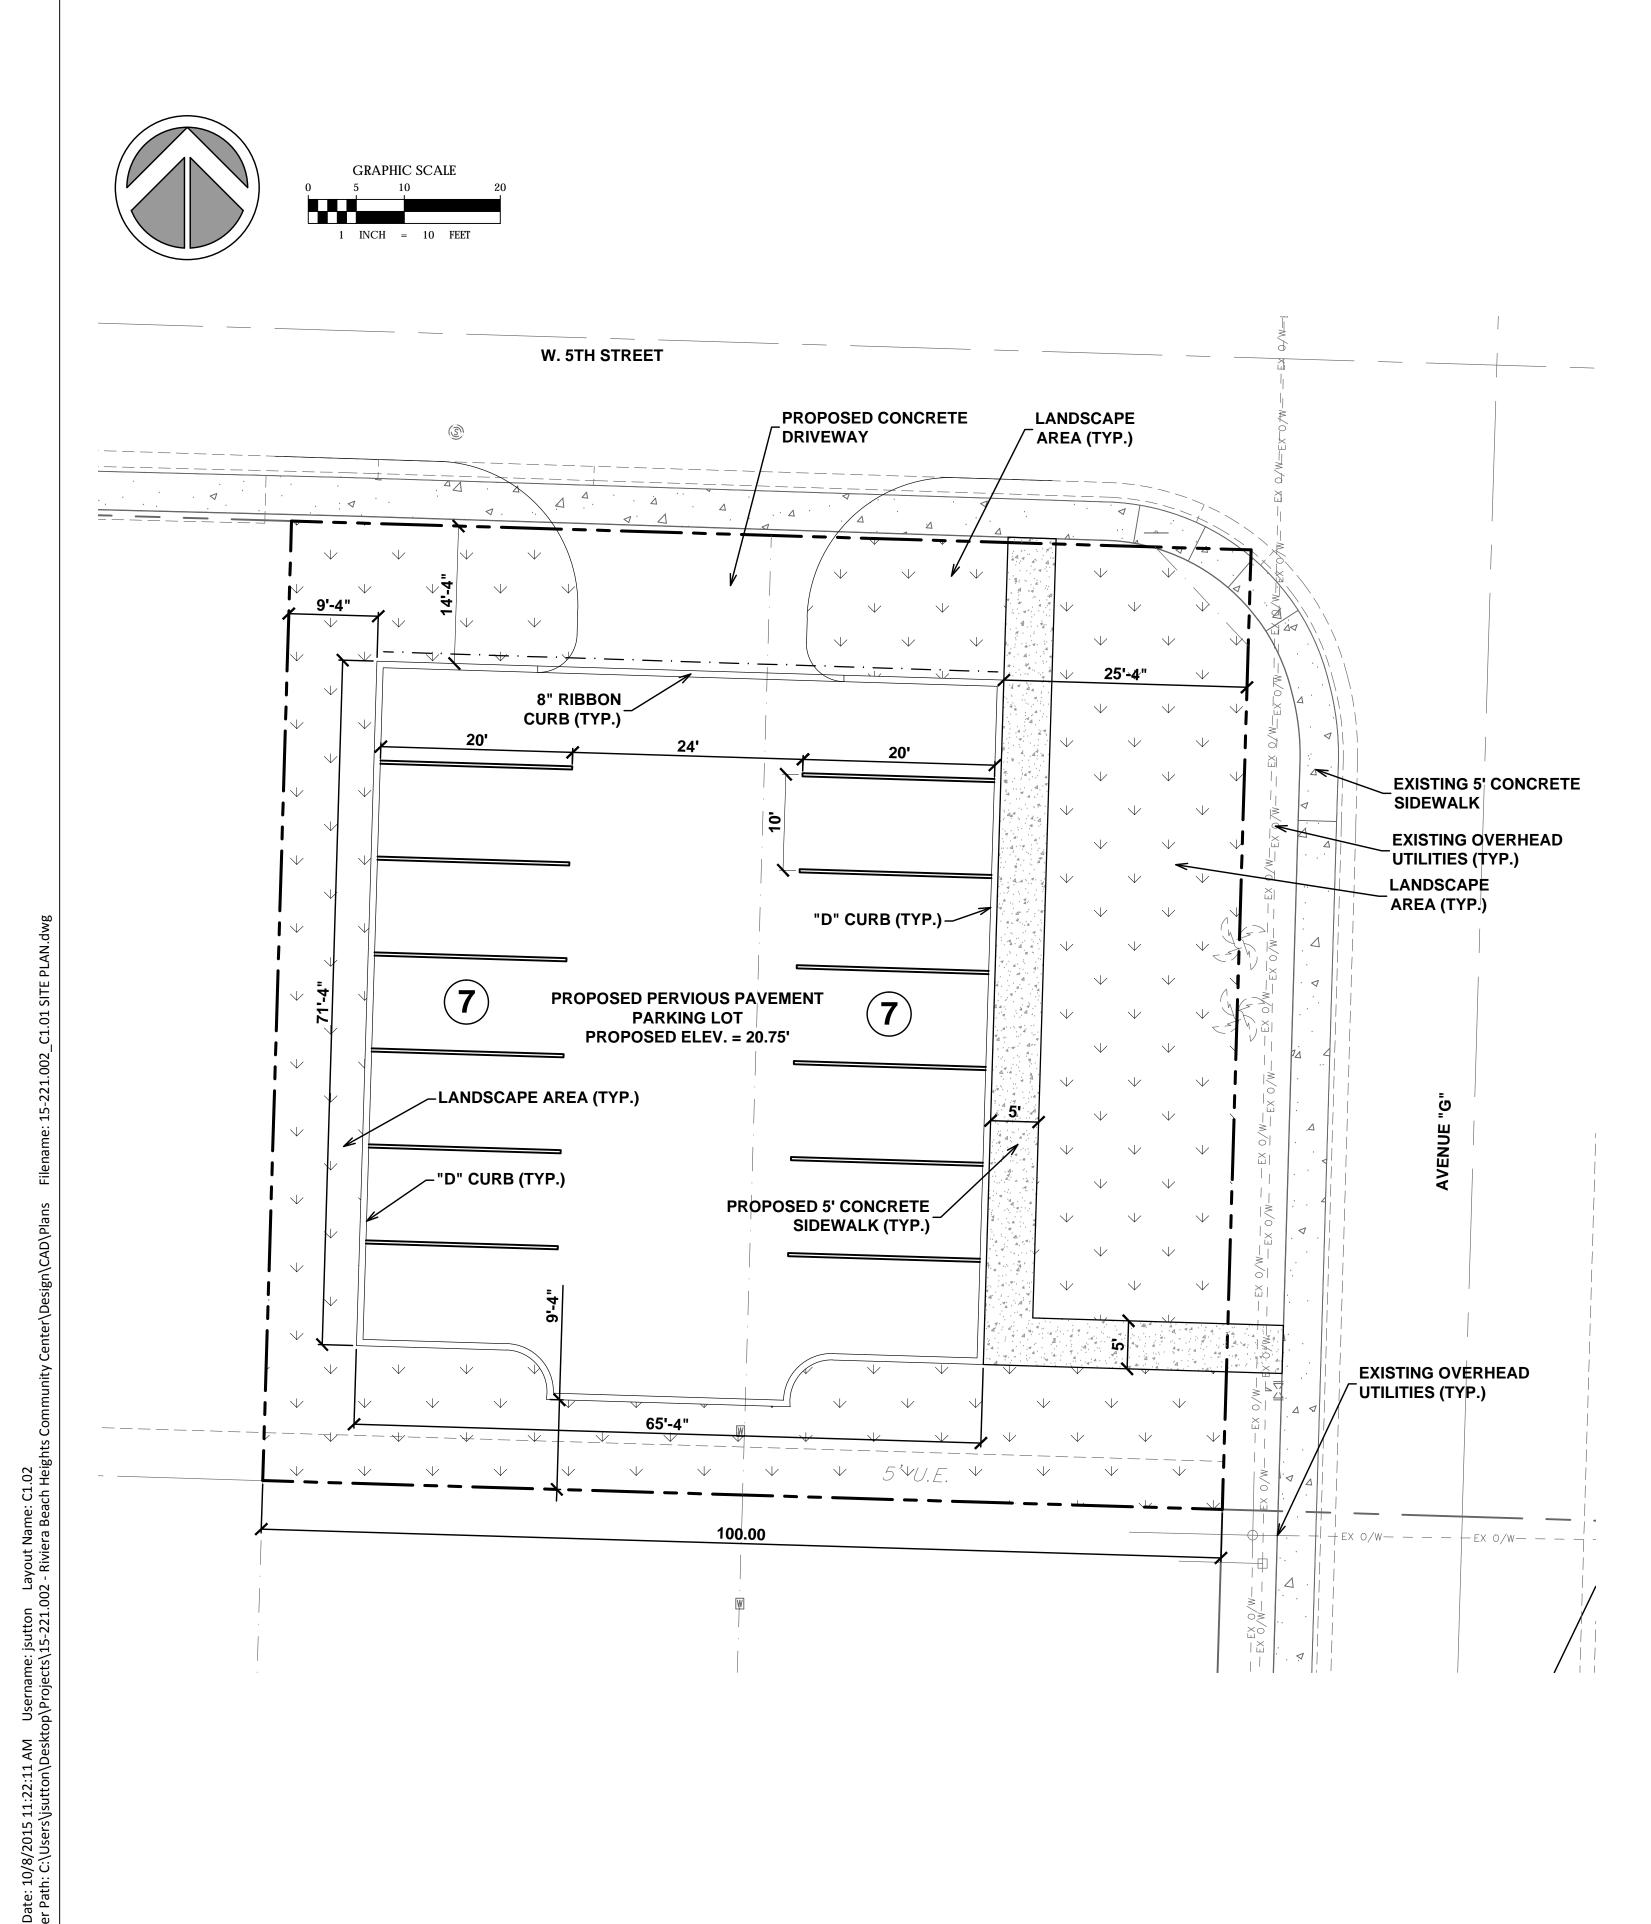

## SITE DATA TABLE: OVERFLOW PARKING LOT

RS-8 SINGLE FAMIL	Y DWELLING				
COMMUNITY CENT LOT	COMMUNITY CENTER OVERFLOW PARKING				
REQUIRED	PROVIDED				
5,000 SF	10,000 SF				
20'	13'				
7'	9'-4"				
12'-6"	25'-4"				
15'	9'-4"				
•					
	5,710 SF (25%)				
TOTAL PERVIOUS AREA					
	COMMUNITY CENT LOT <b>REQUIRED</b> 5,000 SF 20' 7' 12'-6"				

## PRELIMINARY SITE PLAN SUBMITTAL. NOT FOR CONSTRUCTION

SITE PLAN DRAWING NUMBER 1.02 

OF

OVERFLOW PARKING LOT

DRAWING TITLE

CHECKED BY EH

JS

JS DRAWN BY

DESIGNED BY

DATE OF ISSUE 10/08/15

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CLIENT PROJECT NUMBER

RIVIERA BEACH, FL PROJECT NUMBER 15-221.002

CENTER

SOUTH SIDE COMMUNITY

**PROJECT INFORMATION** 



SUB-CONSULTANT

EB4593 LC26000425 REGISTRATION CRISTOBAL BETANCOURT REGISTRATION NO. LA6666941


DATE: 10/08/15

500 Australian Avenue South Suite 530 West Palm Beach, FL 33401 561.746.6900 www.chenmoore.com **CERTIFICATES OF AUTHORIZATION** 

# City Council EHXIBIT "A"



&ASSOCIATES

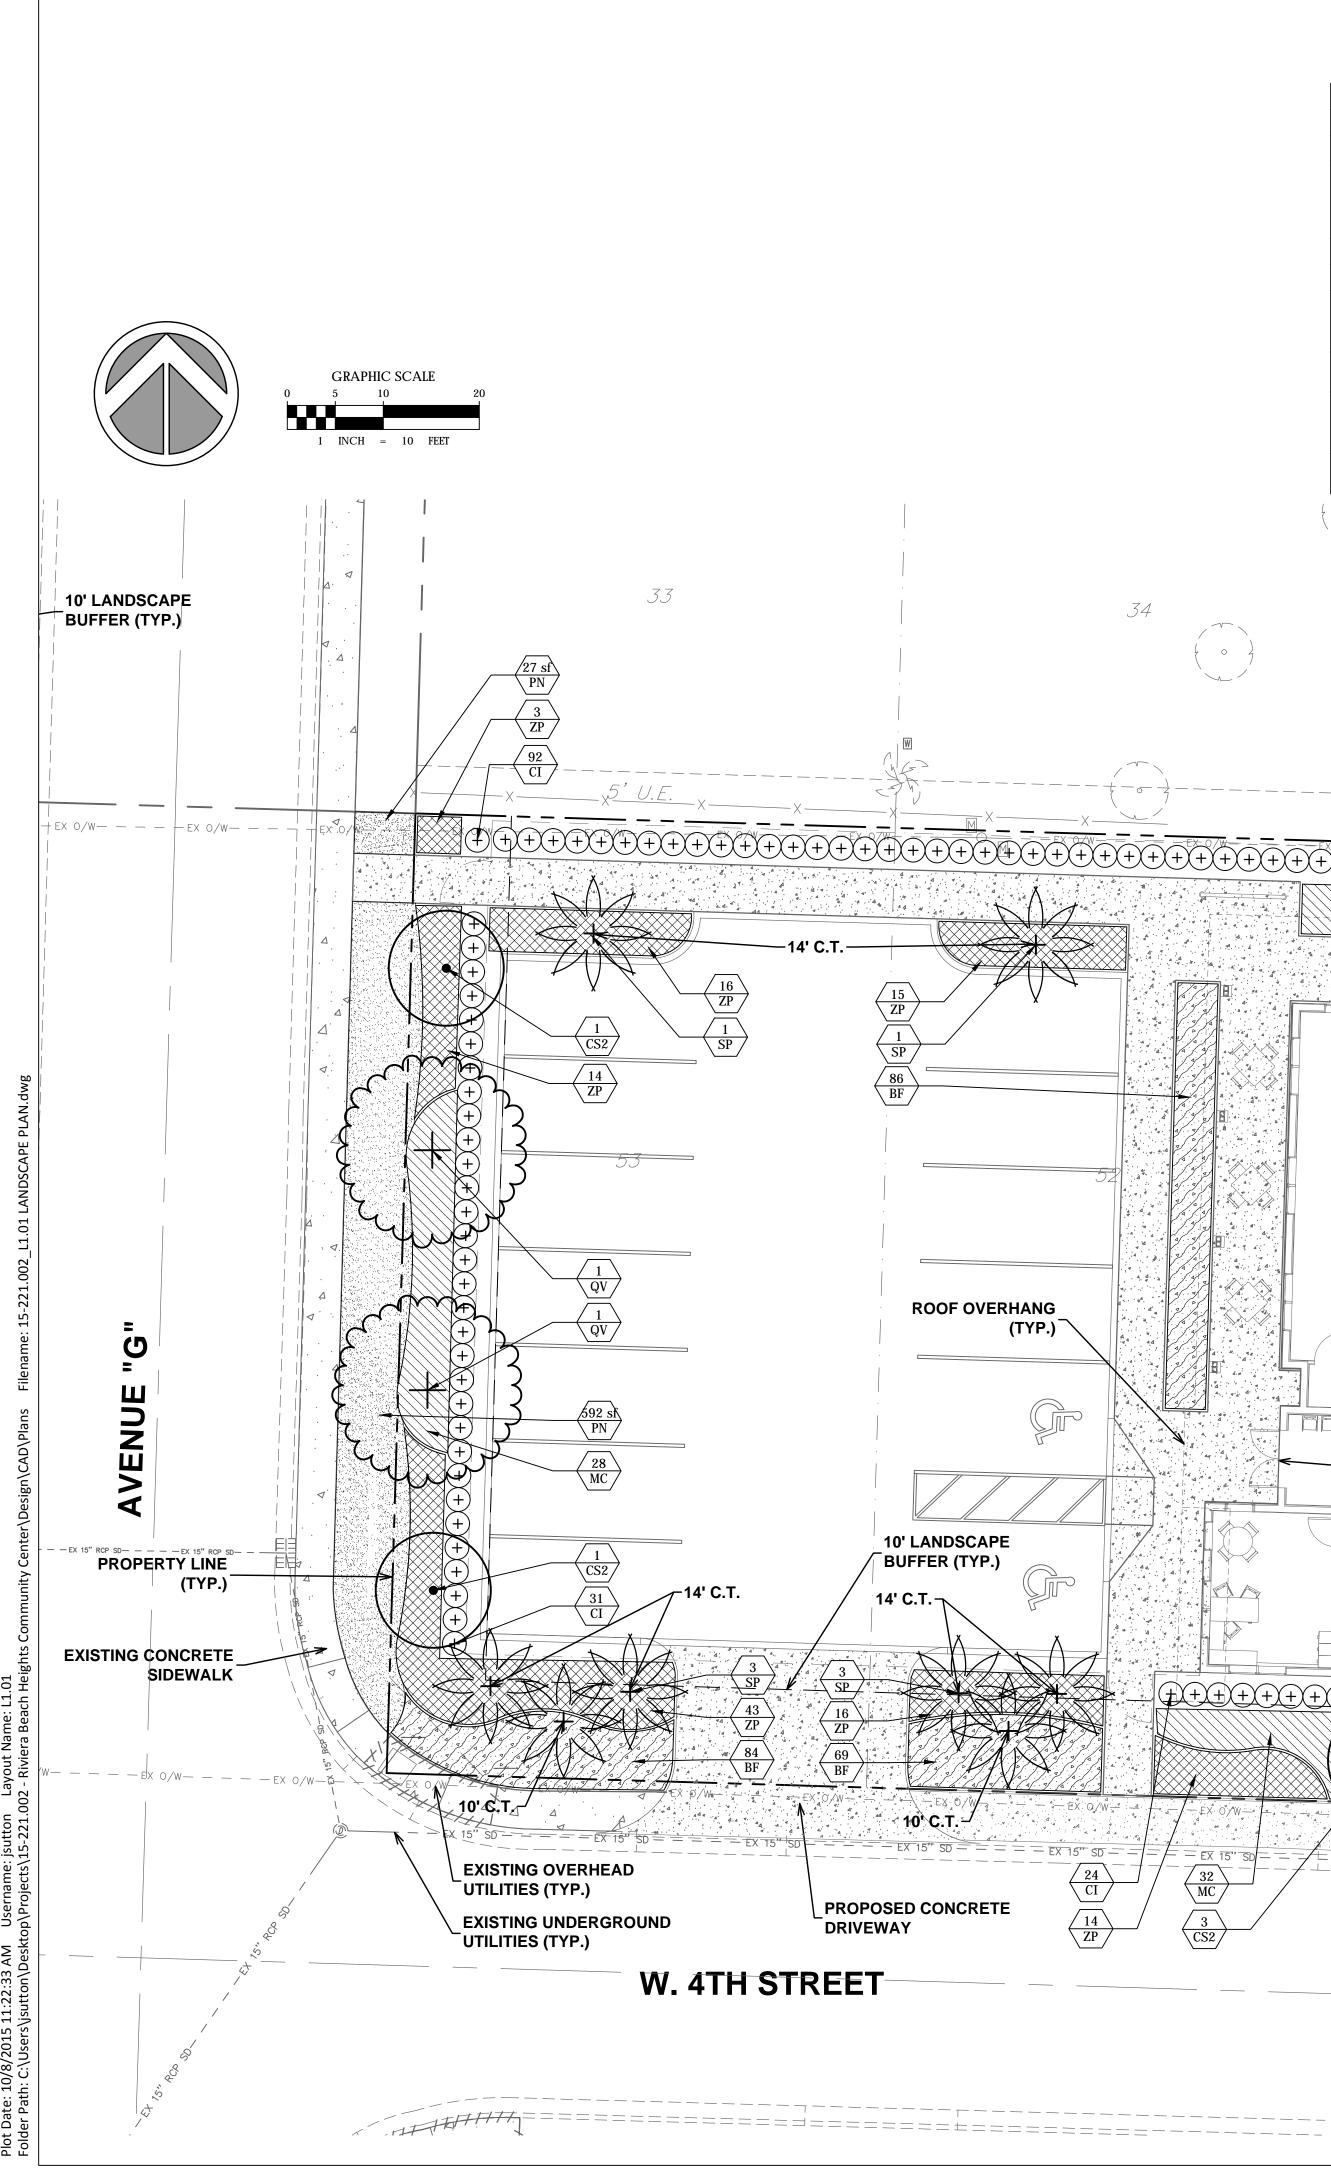



## SITE LANDSCAPE DATA TABLE: COMMUNITY CENTER

												_
	LAND USE CATEGORY: RS-8 SINGLE FAMILY DWELLING	#						TO 55 1 1 1 1		TION		
	CODE APPLICATION		REQUIRED	PROVIDED	EXISTING	RELOCATED	PROPOSED	TREE VALADA	TION/LOCA	TION		
	SEC. 31-609 DEVELOPMENT LANDSCAPE REQUIREMENTS 1 TREE PER 1,500 SF	15,000	10	21	x	x	21	PROXIMITY OF	<b>OVERHEA</b>	D, SPECICES SELECTED DU D UTILITY LINES. (2) LIVE ( S SELECTED DUE TO PRO)	OAKS, (14)	
		-						OVERHEAD UT	FILITY LINES	5		_
	MIN. 20% OF DEVELOPED SITE SHALL BE LANDSCAPED		3,000	4,282				73% SHRUBS/	GROUNDC	OVERS AND 27% BAHIA T	JRF	
	SEC. 31-610 PARKING AREAS FOR NONRESIDENTIAL DEVELOPMEN		1				1					1)
	AVENUE G: MIN. 10' BUFFER W/ 1 TREE PER 20 LF	100	5	5	Х	x	5	CABBAGE PAL	M. BUFFER	VER BUTTONWOOD, (2) L TREES ARE COUNTED TO REE PER 1,500 SF.		
	CONTINUOUS HEDGE		CONTINUOUS HEDGE	CONTINUOUS HEDGE	Х	X	CONTINUOUS HEDGE					
	WEST 4TH STREET: MIN. 10' BUFFER W/ 1 TREE PER 20 LF	80	4	8	х	x	8	PALM. BUFFER	R TREES AR	VER BUTTONWOOD, (5) C E COUNTED TOWARDS TH REE PER 1,500 SF		
	CONTINUOUS HEDGE		CONTINUOUS HEDGE	CONTINUOUS HEDGE	Х	х	CONTINUOUS HEDGE					
Ľ			PL	ANT SCH	IEDULE	L1.01						
			TREES	COL	DE QTY O	COMMON NAME	BOTANICAL NAME		CONT	SIZE	<u>NATIVE</u>	
34			·	) CS2	5 5	Silver Buttonwood	Conocarpus erect	us `Sericeus`	F.G.	12` OAH, 2" DBH MIN.	Yes	
			{ + }	QV	2 I	Park Side Live Oak	Quercus virginiana	a `Park Side` TM	F.G.	14` HT, 5` SPRD, 4" DBH	Yes	
				SP SP	14 (	Cabbage Palmetto	Sabal palmetto		F.G.	10`,14`, 18` CT., Stag. Ht.	Yes	
			SHRUI			COMMON NAME	BOTANICAL NAME		<u>CONT</u>	<u>SIZE</u>		SPACING
			+			Coco Plum	Chrysobalanus ica		3 gal	24" HT, 24" SPRD		30" o.c.
			EX O/W	<u>B AREAS</u> <u>COI</u>		COMMON NAME	BOTANICAL NAME		CONT	<u>SIZE</u>		<u>SPACING</u>
				BF		Stalked Bulbine	Bulbine frutescens		1 gal.	MIN 12" FULL		18" o.c.
		18'	С.т.	MC	105 I	Pink Muhly	Muhlenbergia cap	pillaris	3 gal.	MIN. 24" HT.	Yes	30" o.c.
				ZP	148 0	Coontie	Zamia pumila		3 gal.	14" HT, 14" SPRD	Yes	30" o.c.
			GROL	JND COVERS COL	<u>DE QTY (</u>	COMMON NAME	BOTANICAL NAME		CONT	SIZE	<u>NATIVE</u>	
			С. <sub>1</sub> т.	PN	1,150 sf H	Bahia Grass	Paspalum notatun	1	Solid Sod	FULL	No	
	PROPOSED 1-STORY COMMUNITY CENTER F.F.E. = 20.75' NAVD		N N N N N N N N N N N N N N N N N N N									
			ش ۲. ۲.									
G												
			С.Т.									
	-MAIN ENTRANCE (TYP.)											
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$\begin{array}{c} 24 \\ \hline CI \\ \hline MC \\ \hline \end{array}$	= EX 15" SD = = EX 1	— EX 15" SD — —	— — — EX									
$\begin{array}{c c} \hline 14 \\ \hline ZP \end{array}$ $\begin{array}{c} \hline 3 \\ \hline CS2 \end{array}$	18 MC											

# City Council EHXIBIT "B"



&ASSOCIATES 500 Australian Avenue South Suite 530 West Palm Beach, FL 33401 561.746.6900 www.chenmoore.com **CERTIFICATES OF AUTHORIZATION** EB4593 LC26000425

REGISTRATION CRISTOBAL BETANCOURT REGISTRATION NO. LA6666941 DATE: 10/08/15

SUB-CONSULTANT



PROJECT INFORMATION

## SOUTH SIDE COMMUNITY CENTER

RIVIERA BEACH, FL PROJECT NUMBER 15-221.002

CLIENT PROJECT NUMBER

VERIFY SCALES

IF NOT ONE INCH ON THIS SHEET, ADJUST SCALES ACCORDINGLY

REVISIONS

DATE OF ISSUE 10/08/15

DESIGNED BY

JS

DRAWN BY

JS

DRAWING TITLE

EH

COMMUNITY

CENTER

LANDSCAPE


PLAN

L1.01

OF

DRAWING NUMBER

CHECKED BY

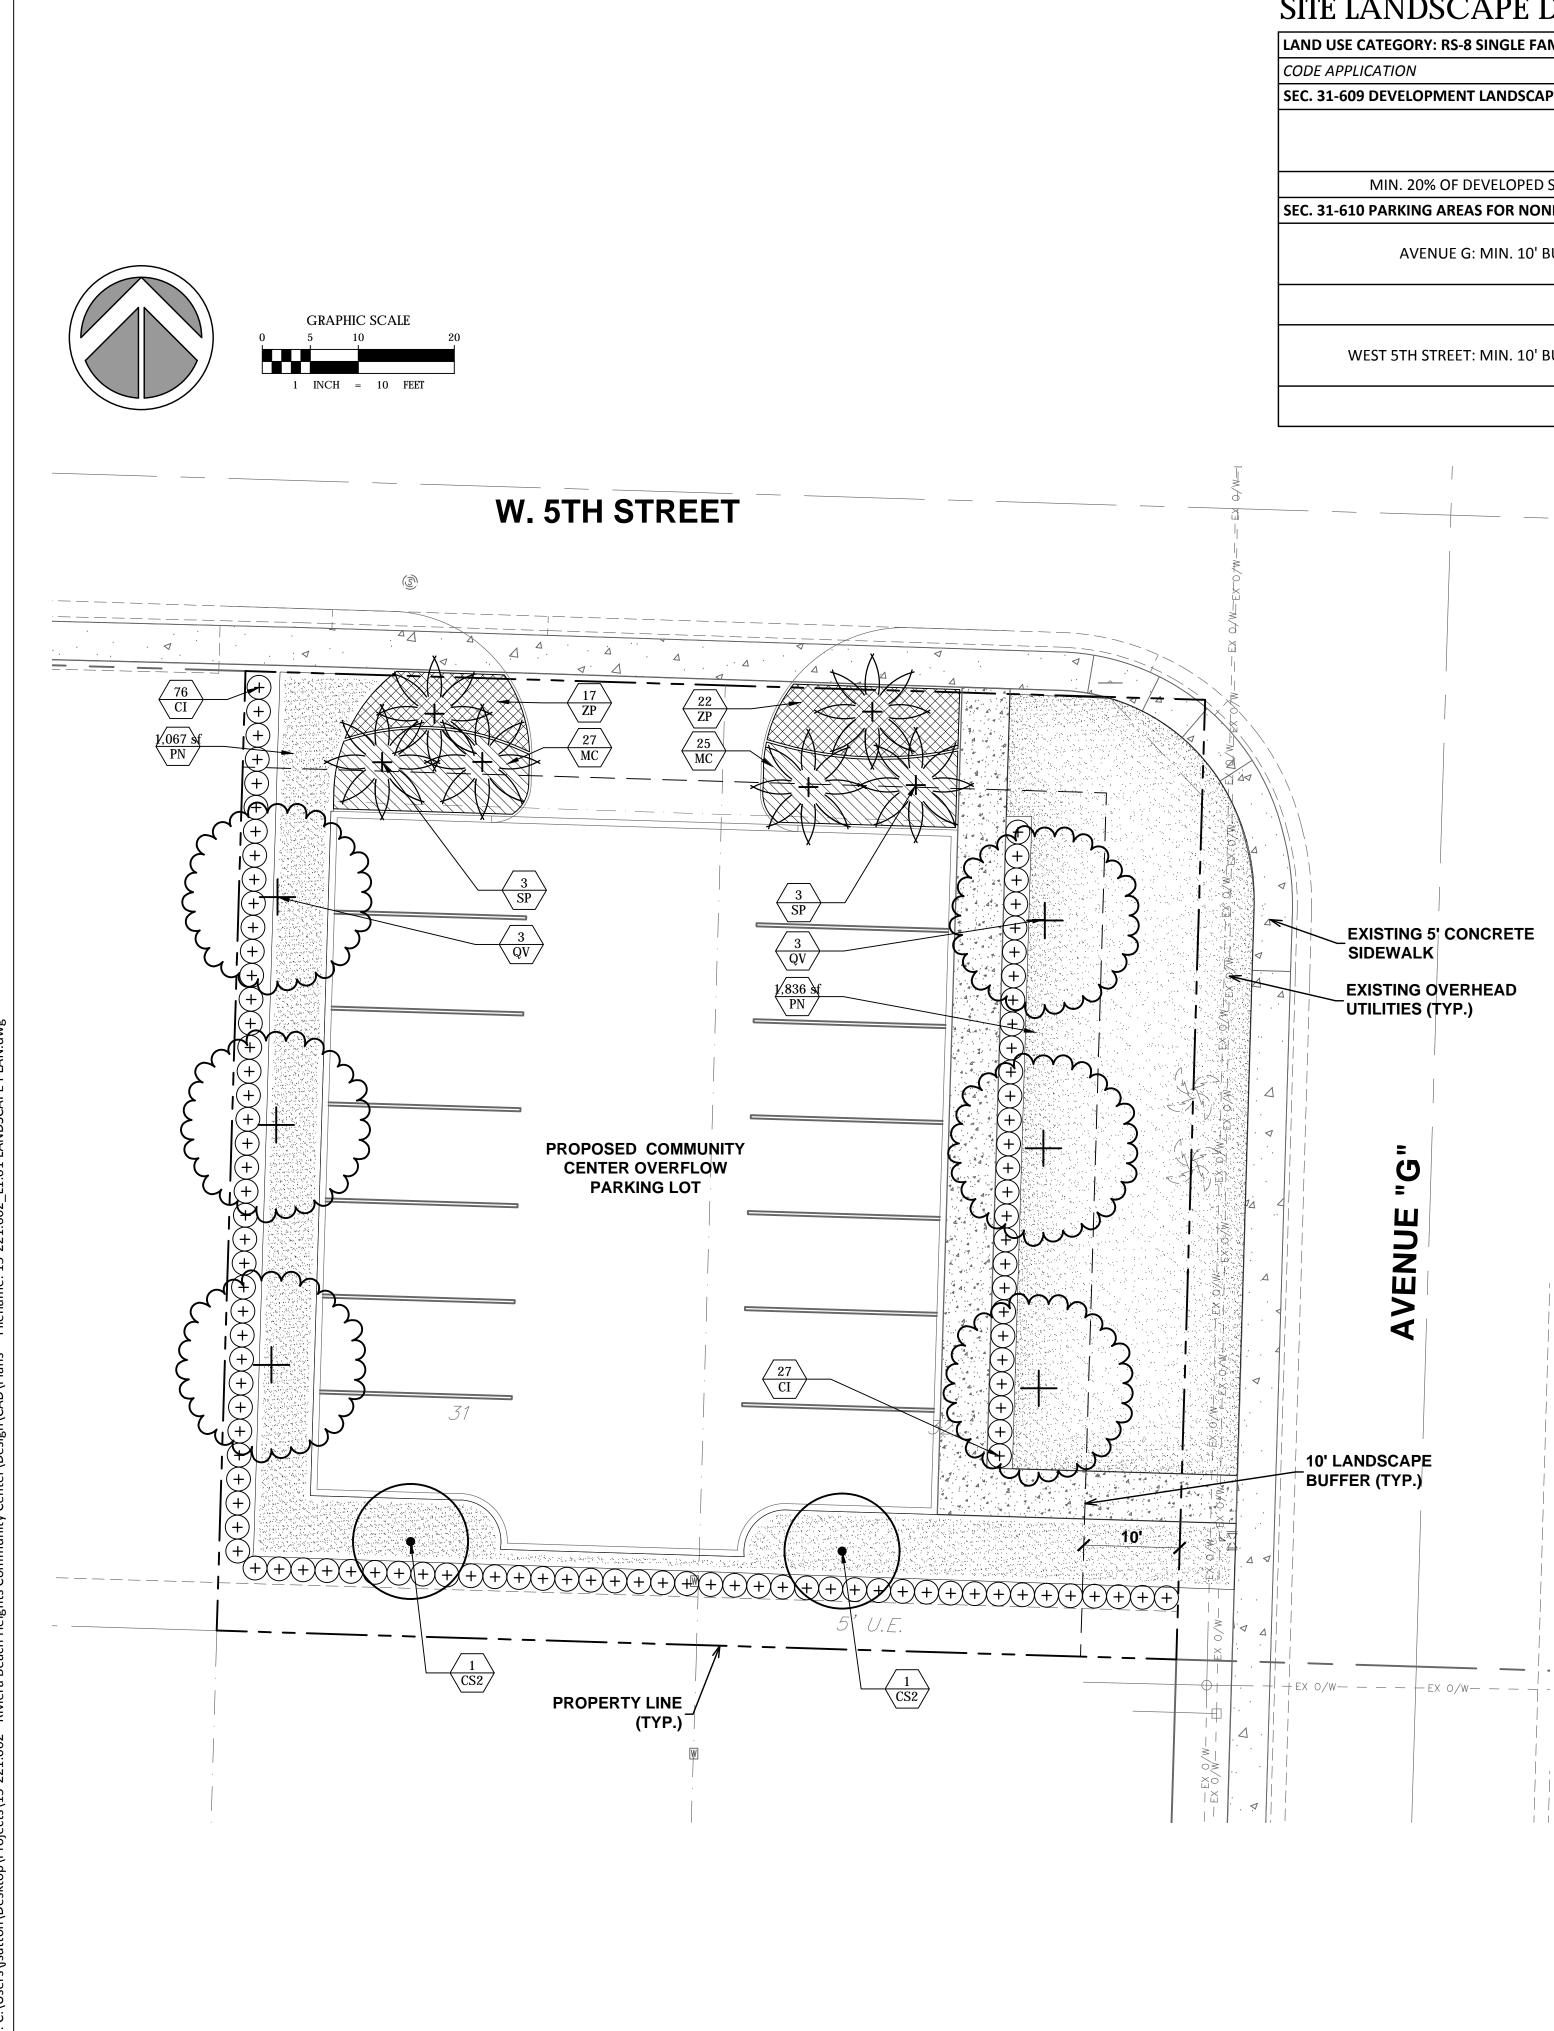

## SITE LANDSCAPE DATA TABLE: OVERFLOW PARKING LOT

LAND USE CATEGORY: RS-8 SINGLE FAMILY DWELLING							
CODE APPLICATION	#	REQUIRED	PROVIDED	EXISTING	RELOCATED	PROPOSED	TREE VALADATION/LOCATION
SEC. 31-609 DEVELOPMENT LANDSCAPE REQUIREMENTS							
1 TREE PER 1,500 SF	10,000	7	14	х	x	14	(2) SILVER BUTTONWOOD, SPECIES SELECTED DUE TO PROXIMITY OF OVERHEAD UTILITY LINES. (6) LIVE OAKS, (6) CABBAGE PALMS,
MIN. 20% OF DEVELOPED SITE SHALL BE LANDSCAPED		2,000	4,290				28% SHRUBS/ GROUNDCOVERS AND 72% BAHIA TURF
SEC. 31-610 PARKING AREAS FOR NONRESIDENTIAL DEVELOPMEN							
AVENUE G: MIN. 10' BUFFER W/ 1 TREE PER 20 LF	75	4	4	х	x	4	PROPOSED TREES: (1) SILVER BUTTONWOOD, (3) LIVE OAK. BUFFER TREES ARE COUNTED TOWARDS THE REQUIRERMENTS OF 1 TREE PER 1,500 SF
CONTINUOUS HEDGE		CONTINUOUS HEDGE	CONTINUOUS HEDGE	х	x	CONTINUOUS HEDGE	
WEST 5TH STREET: MIN. 10' BUFFER W/ 1 TREE PER 20 LF	65	4	7	х	x	7	PROPOSED TREES: (1) LIVE OAK, (6) CABBAGE PALM. BUFFER TREES ARE COUNTED TOWARDS THE REQUIRERMENTS OF 1 TREE PER 1,500 SF
CONTINUOUS HEDGE		CONTINUOUS HEDGE	CONTINUOUS HEDGE	х	х	CONTINUOUS HEDGE	

## PLANT SCHEDULE L1.02

	TREES	CODE	QTY	COMMON NAME	BOTANICAL NAME	CONT	SIZE	<u>NATIVE</u>	
	$(\cdot)$	CS2	2	Silver Buttonwood	Conocarpus erectus `Sericeus`	F.G.	12` OAH, 2" DBH MIN.	Yes	
۰۰۰۲ +		QV	6	Park Side Live Oak	Quercus virginiana `Park Side` TM	F.G.	14` HT, 5` SPRD, 4" DBH	Yes	
ι.		SP	6	Cabbage Palmetto	Sabal palmetto	F.G.	10`,14`, 18` CT., Stag. Ht.	Yes	
	SHRUBS	CODE	QTY	COMMON NAME	BOTANICAL NAME	CONT	SIZE	<u>NATIVE</u>	<u>SPACING</u>
	+	CI	103	Coco Plum	Chrysobalanus icaco	3 gal	24" HT, 24" SPRD	Yes	30" o.c.
	SHRUB AREAS	<u>CODE</u>	QTY	COMMON NAME	BOTANICAL NAME	<u>CONT</u>	SIZE	<u>NATIVE</u>	<u>SPACING</u>
		MC	52	Pink Muhly	Muhlenbergia capillaris	3 gal.	MIN. 24" HT.	Yes	30" o.c.
		ZP	39	Coontie	Zamia pumila	3 gal.	14" HT, 14" SPRD	Yes	30" o.c.
	GROUND COVERS	<u>CODE</u>	QTY	COMMON NAME	BOTANICAL NAME	CONT	SIZE	NATIVE	
		PN	1,836 sf	Bahia Grass	Paspalum notatum	Solid Sod	FULL	No	

# City Council EHXIBIT "B"

CHEN-MOORE

&ASSOCIATES 500 Australian Avenue South Suite 530 West Palm Beach, FL 33401 561.746.6900 www.chenmoore.com **CERTIFICATES OF AUTHORIZATION** EB4593 LC26000425

REGISTRATION CRISTOBAL BETANCOURT REGISTRATION NO. LA6666941 DATE: 10/08/15

SUB-CONSULTANT

CLIENT

PROJECT INFORMATION

## SOUTH SIDE COMMUNITY CENTER

RIVIERA BEACH, FL PROJECT NUMBER 15-221.002

CLIENT PROJECT NUMBER

VERIFY SCALES

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REVISIONS

DATE OF ISSUE 10/08/15

DESIGNED BY

EH

OVERFLOW

PARKING

LANDSCAPE

PLAN

L1.02

OF

DRAWING NUMBER


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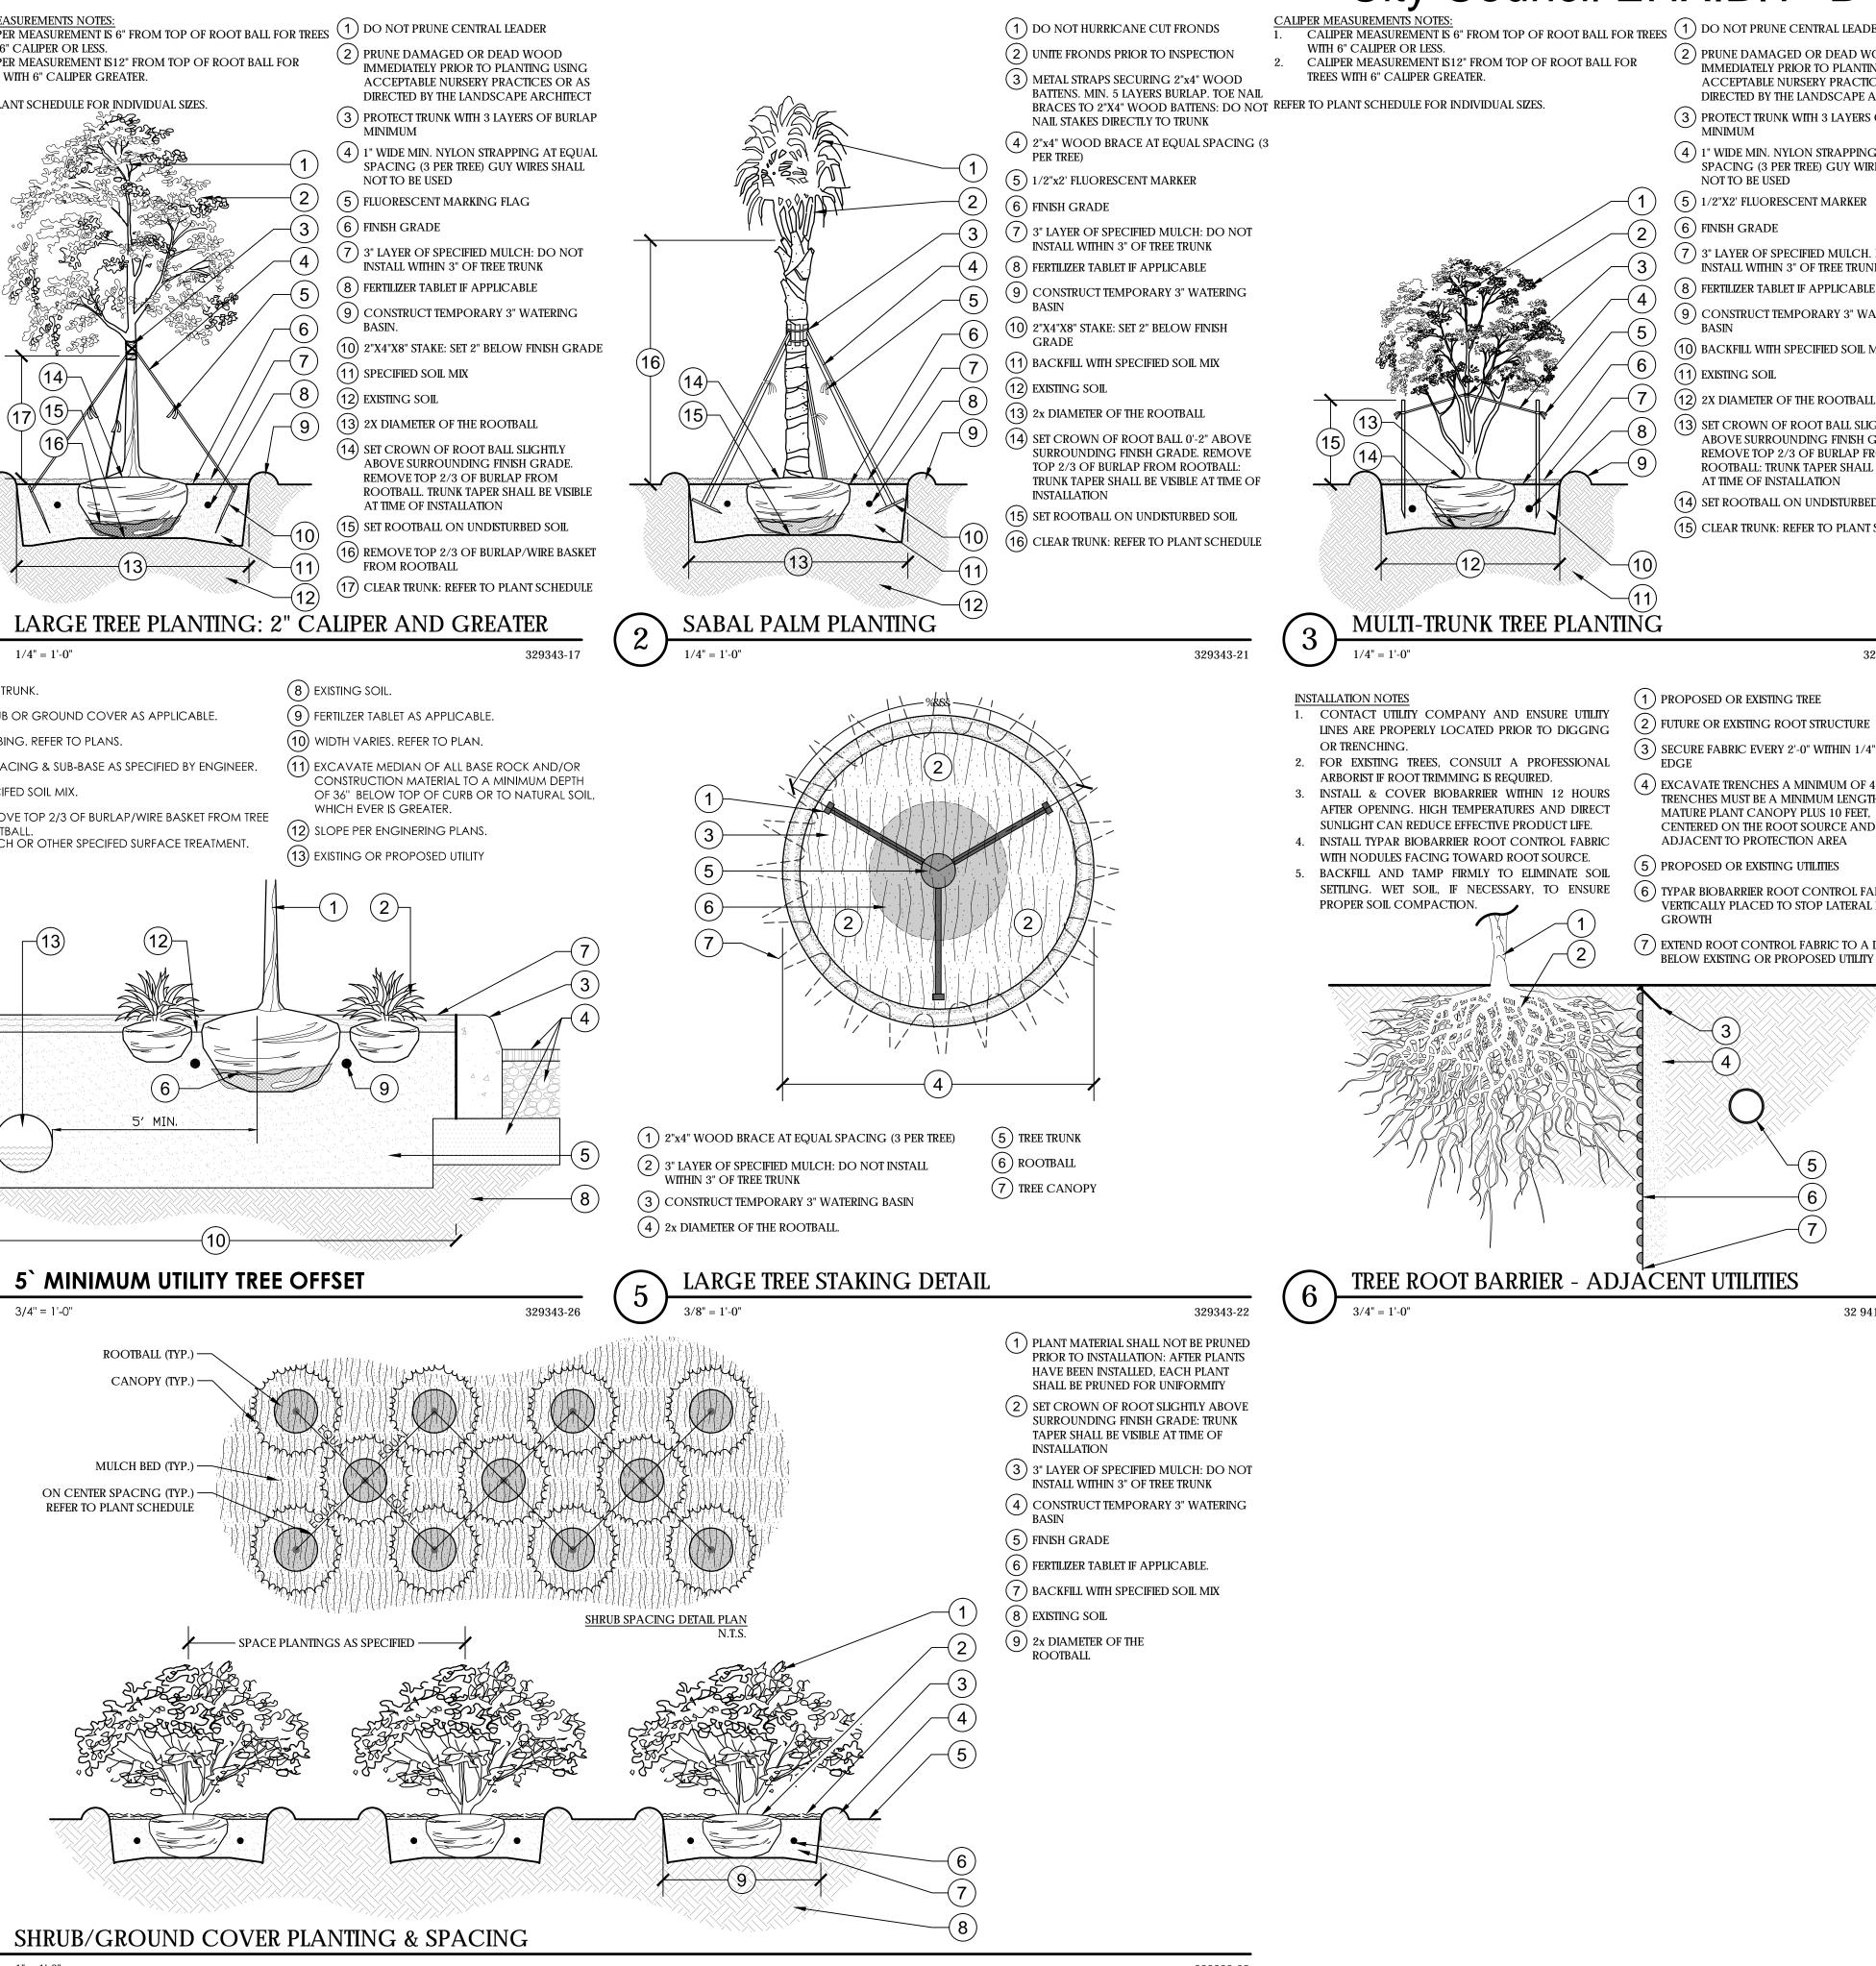
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329333-08

## PRELIMINARY SITE PLAN SUBMITTAL. NOT FOR CONSTRUCTION

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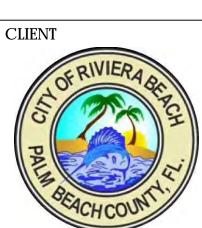
15-221.002

PROJECT NUMBER

RIVIERA BEACH, FL

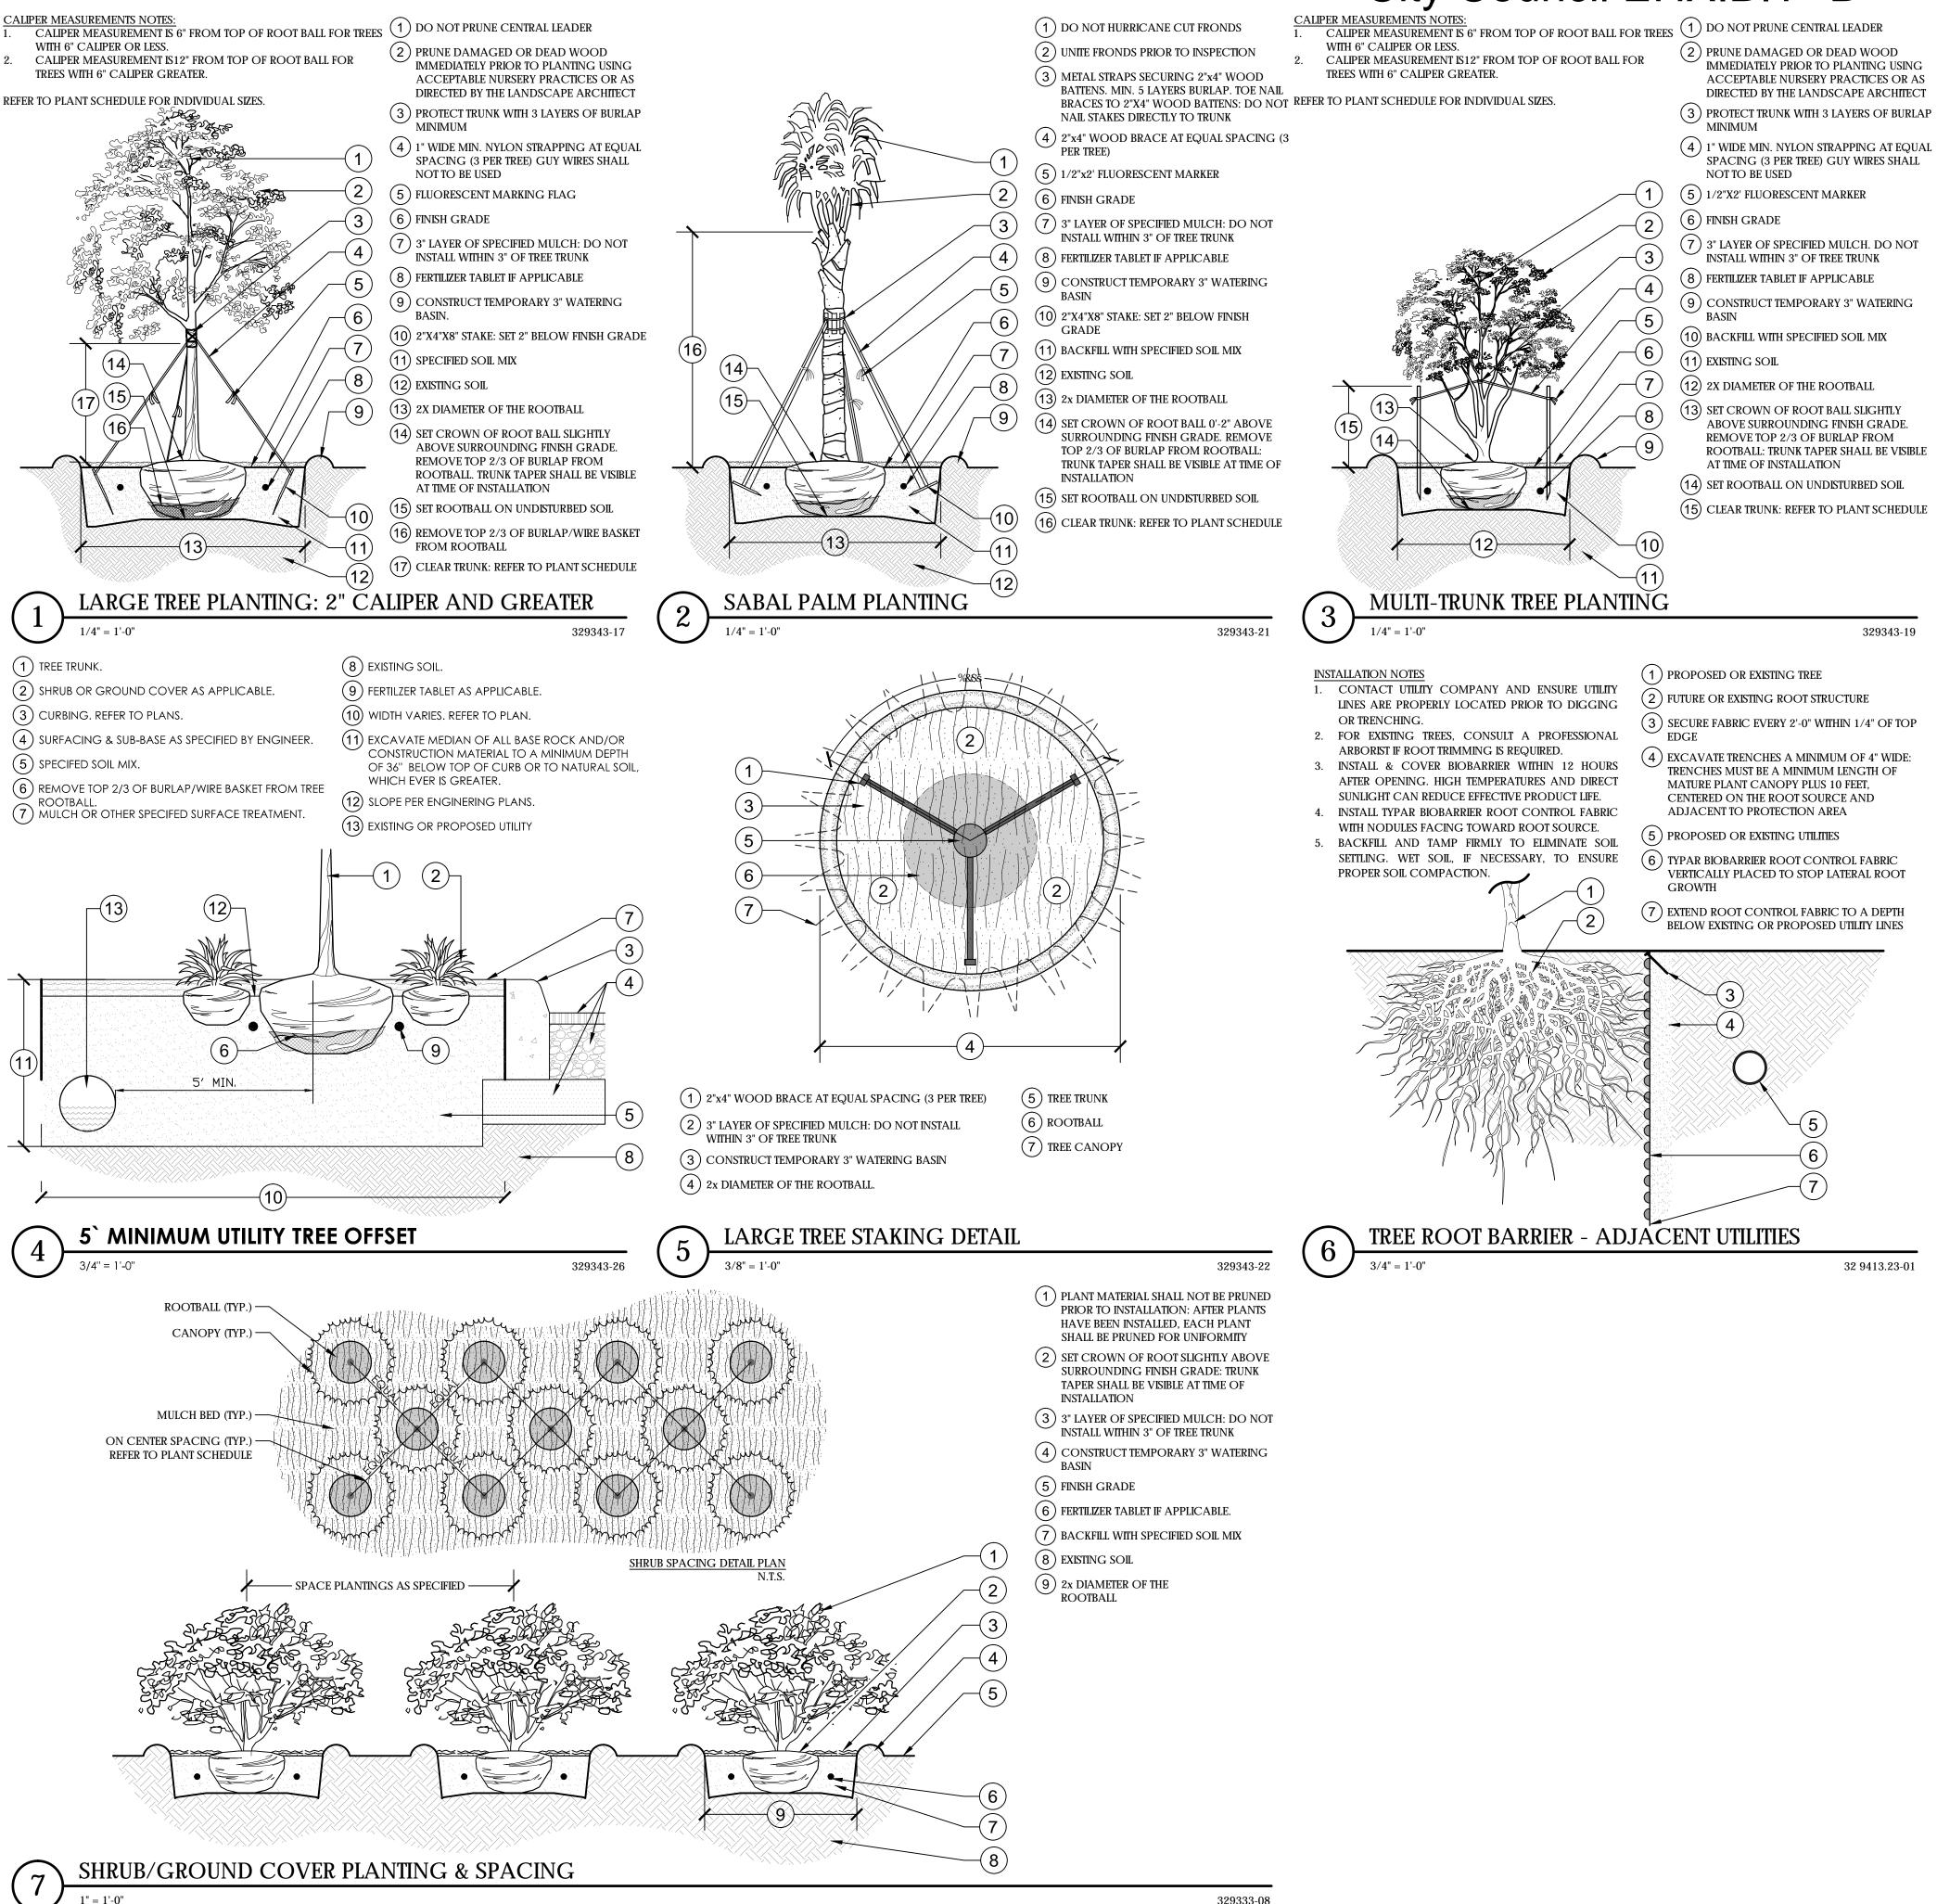COMMUNITY CENTER

PROJECT INFORMATION SOUTH SIDE



# City Council EHXIBIT "B"

- (14) SET ROOTBALL ON UNDISTURBED SOIL
- (15) CLEAR TRUNK: REFER TO PLANT SCHEDULE

- (4) EXCAVATE TRENCHES A MINIMUM OF 4" WIDE: TRENCHES MUST BE A MINIMUM LENGTH OF

- (6) TYPAR BIOBARRIER ROOT CONTROL FABRIC VERTICALLY PLACED TO STOP LATERAL ROOT
- (7) EXTEND ROOT CONTROL FABRIC TO A DEPTH BELOW EXISTING OR PROPOSED UTILITY LINES

(3) SECURE FABRIC EVERY 2'-0" WITHIN 1/4" OF TOP

329343-19

**CHEN-MOORE** 

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## LANDSCAPE SPECIFICATIONS 1. <u>GENERAL</u> 1.1. WORK PERFORMED SHALL COMPLY WITH THE FOLLOWING: THESE GENERAL NOTES, CONSTRUCTION DOCUMENTS AND SPECIFICATIONS. 1.1.2.

- 1.2. SOURCE OF BASE INFORMATION PROVIDED BY OWNER AND IS ASSUMED TO BE CORRECT. IF SITE DISCREPANCIES ARE PRESENT, CONTRACTOR SHALL NOTIFY OWNER'S REPRESENTATIVE IMMEDIATELY IF CONTRACTOR CONTINUES WORK WITHOUT THE PROPER NOTIFICATION, CONTRACTOR DOES SO AT HIS OWN RISK.
- 1.3. THE CONTRACTOR SHALL FURNISH ALL MATERIALS, LABOR, SUPERVISION, AND EQUIPMENT REQUIRED FOR THE WORK AS SHOWN ON THE CONSTRUCTION DOCUMENTS DESCRIBED HEREIN. 1.4. CONTRACTOR SHALL BE RESPONSIBLE FOR ANY COORDINATION WITH SUB-CONTRACTORS AS
- REQUIRED TO COMPLETE THE WORK OF THIS PROJECT. 1.5. CONTRACTOR SHALL VERIFY LOCATIONS OF PERTINENT SITE IMPROVEMENTS INSTALLED UNDER OTHER CONTRACTS. IF ANY PART OF THIS PLAN CANNOT BE FOLLOWED DUE TO SITE CONDITIONS,
- CONTACT OWNER'S REPRESENTATIVE FOR INSTRUCTIONS PRIOR TO COMMENCING WORK 1.6. CONTRACTOR TO NOTIFY "SUNSHINE STATE ONE CALL OF FLORIDA, INC." AT 1-800-432-4770 TWO FULL BUSINESS DAYS PRIOR TO DIGGING FOR UNDERGROUND UTILITY LOCATIONS.
- 1.7. CONTRACTOR IS RESPONSIBLE FOR DETERMINING ALL UTILITY LOCATIONS AND INSTALLING FACILITIES SO AS TO NOT CONFLICT. THE LOCATION OF EXISTING UTILITIES OR SITE FEATURES AS SHOWN ON THE PLANS MAY VARY IN RELATION TO ACTUAL EXISTING CONDITIONS. ANY DIFFERING SITE CONDITIONS FROM THAT WHICH IS REPRESENTED HEREON, WHETHER ABOVE, ON OR BELOW THE SURFACE OF THE GROUND, SHOULD BE BROUGHT TO THE IMMEDIATE ATTENTION OF THE LANDSCAPE ARCHITECT AND THE OWNER IN WRITING. NO CLAIM FOR EXPENSES INCURRED BY THE CONTRACTOR DUE TO DIFFERING SITE CONDITIONS WILL BE ALLOWED IF THE CONTRACTOR FAILS TO PROVIDE THE REQUIRED WRITTEN NOTIFICATION OF SUCH CONDITIONS FOR REVIEW BY THE LANDSCAPE ARCHITECT AND THE OWNER.
- 1.8. CONTRACTOR SHALL NOTIFY ALL APPROPRIATE UTILITY COMPANIES OF PROPOSED START OF WORK IN ACCORDANCE WITH THEIR STANDARD REQUIREMENTS, INCLUDING BUT NOT LIMITED TO, WATER, SANITARY SEWER, POWER, NATURAL GAS, TELEPHONE AND CABLE TV COMPANIES.
- 1.9. IT SHALL BE THE CONTRACTOR'S SOLE RESPONSIBILITY TO TAKE THE NECESSARY PRECAUTIONS TO FOR IRRIGATION OR ELECTRICAL LINES WITHIN DRIP LINES OF EXISTING TREES. COORDINATE ALL ENSURE PROPER SAFETY AND WORKMANSHIP WHEN WORKING IN THE VICINITY OF EXISTING UTILITY TRENCHING REQUIRED FOR UTILITY WORK WITH THE LANDSCAPE PLANS. LINES. 4.6. ROOT PRUNING SHALL OCCUR IN ACCORDANCE WITH TREE RELOCATION NOTES AS NOTED ON 1.10. PERFORM EXCAVATION IN THE VICINITY OF UNDERGROUND UTILITIES WITH CARE AND BY HAND, IF PLANS.
- NECESSARY. THE CONTRACTOR BEARS FULL RESPONSIBILITY FOR THIS WORK AND DISRUPTION OF 5. DAMAGE TO UTILITIES SHALL BE REPAIRED IMMEDIATELY AND AT NO EXPENSE TO THE OWNER.
- 1.11. THE SUCCESSFUL BIDDER SHALL FURNISH TO THE OWNER A UNIT PRICE BREAKDOWN FOR ALL ROOTBALL MATERIALS. THE OWNER MAY, AT ITS DISCRETION, ADD OR DELETE FROM THE MATERIALS UTILIZING ALL TREES SHALL BE PLANTED WITH A MINIMUM OF 6" TOPSOIL AROUND AND BENEATH THE 5.2. THE UNIT PRICE BREAKDOWN SUBMITTED. ROOTBALL 1.12. IT IS THE RESPONSIBILITY OF THE CONTRACTOR TO ENSURE THAT ALL REQUIRED PERMITS ARE MINIMUM TOPSOIL SHALL BE 2" FOR SODDED GRASS AREAS. 5.3. OBTAINED AND ARE IN HAND AT THE JOB SITE PRIOR TO THE COMMENCEMENT OF CONSTRUCTION. 54 PLANTING SOIL MIX SHALL BE A WEED FREE MIX AS FOLLOWS: CONTRACTOR SHALL ABIDE BY ALL PERMIT CONDITIONS. DICOT TREES & SHRUBS: 50% SAND, 40% MUCK & 10% PEAT 5.4.1.
- 2. PRE-CONSTRUCTION RESPONSIBILITY MONOCOT PALMS: 70% SAND & 30% MUCK 5.4.2.2.1. UPON RECEIPT OF NOTICE OF AWARD, THE CONTRACTOR SHALL ARRANGE A PRE-CONSTRUCTION 5.4.3. TURF: 80% SAND, 10% PEAT & 10% MUCK CONFERENCE TO INCLUDE ALL INVOLVED GOVERNMENTAL AGENCIES, ALL AFFECTED UTILITY 6. LANDSCAPE PLANTING OWNERS, THE OWNER, THE LANDSCAPE ARCHITECT, ANY OTHER PERTINENT PARTIES AND HIMSELF. 6.1. THIS PLAN HAS BEEN DESIGNED TO MEET OR EXCEED ALL APPLICABLE CODES.
- 2.2. CONTRACTOR SHALL PROVIDE TEMPORARY SANITARY FACILITIES ONSITE. LOCATION TO BE THE PLANTING PLAN SHALL BE INSTALLED IN COMPLIANCE WITH ALL EXISTING CODES AND 6.2. DETERMINED BY THE OWNER. JANITORIAL SERVICES SHALL BE PROVIDED BY CONTRACTOR APPLICABLE DEED RESTRICTIONS. THROUGHOUT THE DURATION OF PROJECT. 6.3. PLANT MATERIAL: ALL PLANT MATERIAL SHALL BE FLORIDA #1 OR BETTER AS ESTABLISHED BY "GRADES
- 2.3. PRIOR TO BEGINNING CONSTRUCTION, THE CONTRACTOR SHALL VERIFY THE SIZE, LOCATION, AND STANDARDS FOR NURSERY PLANTS" OF THE STATE OF FLORIDA, DEPARTMENT OF AGRICULTURE. ELEVATION, AND MATERIAL OF ALL EXISTING UTILITIES WITHIN THE AREA OF CONSTRUCTION. 6.4. ALL PLANT MATERIAL SHALL BE TRUE TO THE BOTANICAL NAME, GENUS, SPECIES AND/OR HYBRID 2.4. IF UPON EXCAVATION, AN EXISTING UTILITY IS FOUND TO BE IN CONFLICT WITH THE PROPOSED DESIGNATION. CONSTRUCTION OR TO BE OF A SIZE OR MATERIAL DIFFERENT FROM THAT SHOWN ON THE PLANS; 6.5. ALL TREES, SHRUBS AND GROUNDCOVERS SHALL BE OF THE SIZES (HEIGHT & SPREAD) AS SPECIFIED IN THE CONTRACTOR SHALL IMMEDIATELY NOTIFY THE LANDSCAPE ARCHITECT. THE PLANT LIST. CONTAINER SIZE IS FOR REFERENCE PURPOSES ONLY. ALL PLANT MATERIAL SHALL 10. PROJECT CLOSEOUT 2.5. IT SHALL BE THE CONTRACTOR'S RESPONSIBILITY TO MAKE ARRANGEMENTS FOR THE FIELD MEET OR EXCEED THE MINIMUM SIZES AT INSTALLATION, AS SPECIFIED IN THE PLANT LIST.
- LOCATIONS AND FOR ANY TREES PROPOSED FOR RELOCATION. THIS SHALL BE DONE IN A TIMELY QUANTITIES LISTED ON THE PLANT LIST ARE FOR ESTIMATING PURPOSES. CONTRACTOR SHALL VERIFY 66 MANNER TO MINIMIZE IMPACT ON CONSTRUCTION SCHEDULE. ANY DELAY CAUSED BY THE ALL QUANTITIES. MULCH, TOPSOIL, FERTILIZER, ETC. SHALL BE INCLUDED IN THE UNIT COST OF THE CONTRACTOR BY THE RELOCATION OF TREES SHALL BE INCIDENTAL TO THE CONTRACT AND NO PLANTS.
- EXTRA COMPENSATION WILL BE ALLOWED. 6.7. WHERE THERE IS A DISCREPANCY EITHER IN QUANTITIES, PLANT NAMES, SIZES OR SPECIFICATIONS 2.6. CONTRACTOR SHALL VERIFY LIMITS OF CONSTRUCTION AS NOTED ON THE PLANS. ANY WORK BETWEEN THE PLAN OR PLANT LIST, THE PLAN TAKES PRECEDENCE. PERFORMED OUTSIDE OF THE AGREED UPON LIMITS OF CONSTRUCTION SHALL BE DONE AT THE 6.8. ALL SUBSTITUTIONS AND CHANGES SHALL BE APPROVED IN WRITING PRIOR TO INSTALLATION. ANY EXPENSE OF THE CONTRACTOR. DISCREPANCIES BETWEEN PLANS, SITE AND SPECIFICATIONS SHALL BE BROUGHT TO THE IMMEDIATE 3. <u>SITE DEMOLITION</u> ATTENTION OF THE LANDSCAPE ARCHITECT, THE OWNER AND/OR GOVERNING MUNICIPALITY.
- 3.1. ITEMS SHALL REMAIN UNLESS OTHERWISE NOTED ON THE PLAN(S). REMOVE DESIGNATED ITEMS 6.9. WHERE MATERIAL OR DEBRIS HAS WASHED OR FLOWED INTO OR BEEN PLACED IN WATER COURSES, CONTRACTOR SHALL BE RESPONSIBLE FOR PROVIDING FINAL GRADING OF ALL ASSOCIATED 10.3. SHOWN ON THE PLAN TO THE FULL DEPTH OF THEIR CONSTRUCTION UNLESS OTHERWISE NOTED. DITCHES, DRAINS, CATCH BASINS, OR ELSEWHERE AS A RESULT OF THE CONTRACTOR'S OPERATIONS, PLANTING AREAS. 3.2. ALL HARDSCAPE DESIGNATED FOR REMOVAL SHALL BE SAW CUT, LEAVING UNIFORM EDGES TO THE 6.10. AFTER FINAL GRADE, LANDSCAPE AREAS ARE TO BE RAKED TO A DEPTH OF \*Ï" ALL ROCK AND
- SUCH MATERIAL OR DEBRIS SHALL BE REMOVED AND SATISFACTORILY DISPOSED OF DURING GREATEST EXTENT POSSIBLE. MATERIAL EDGES TO REMAIN SHALL BE SHORED UP AND PROTECTED PROGRESS OF THE WORK. THESE AREAS SHALL BE KEPT IN A CLEAN AND NEAT CONDITION. FOREIGN INORGANIC MATERIALS SHALL BE REMOVED AND DISPOSED OF PROPERLY OFF-SITE. DURING CONSTRUCTION TO PRESERVE EDGE INTACT. REPAIRS TO DAMAGED EDGES SHALL BE 10.4. THE CONTRACTOR SHALL MAINTAIN ACCURATE AND COMPLETE RECORDS OF WORK ITEMS ALL PLANTING HOLES TO BE HAND DUG EXCEPT WHERE MACHINE DUG HOLES WILL NOT ADVERSELY 6.11. REPAIRED BY CONTRACTOR AT NO ADDITIONAL COST TO THE OWNER. COMPLETED. AFFECT EXISTING TREES, DAMAGE UTILITIES OR OTHER IMPROVEMENTS. 3.3. NO EXISTING MATERIAL SHALL BE USED IN NEW CONSTRUCTION UNLESS NOTED ON THE PLANS OR 6.12. ALL PLANTING BEDS IN OPEN AREAS AND AROUND BUILDING FOUNDATIONS SHALL BE EXCAVATED 10.5. UPON COMPLETION OF CONSTRUCTION, THE CONTRACTOR SHALL SUBMIT TO THE LANDSCAPE
- APPROVED DURING THE SHOP DRAWING APPROVAL PROCESS. 3.4. SALVAGE EXISTING MATERIALS AS INDICATED ON THE PLANS. SALVAGED MATERIALS SHALL BE HANDLED WITH CARE AND STORED ON-SITE OR AS DIRECTED BY OWNER. CLEAN ALL DEBRIS AND CONSTRUCTION MATERIAL FROM SALVAGED ITEMS; REUSE AS DIRECTED BY OWNER'S
- REPRESENTATIVE. FEDERAL LAWS.
- 3.6. CONTRACTOR SHALL PROTECT ADJACENT WATER BODIES, COASTAL DUNE SYSTEMS AND PROPERTIES FROM DAMAGE BY SEDIMENTATION OR OTHER POTENTIAL CONSTRUCTION RELATED CAUSES.

## 4. TREE PRESERVATION

OVERALL SYSTEM IS NOT AFFECTED. 6.15. BURLAP, SYNTHETIC STRING, CORDS AND/OR LIFTING ROPES SHALL BE REMOVED FROM THE BE REPLACED IN KIND AS IT RELATES TO SPECIES, QUANTITY AND SIZE. ROOTBALLS BEFORE ANY TREES ARE PLANTED. THE TOP 1/3RD OF BURLAP MUST BE REMOVED FROM HE TOP OF THE ROOTBALLS. THE TOP 1/3RD OF WIRE BASKETS SHALL BE COMPLETELY REMOVED AND 11.3. ALL TREES THAT LEAN OR ARE BLOWN OVER, CAUSED BY WINDS LESS THAN 74 MPH AS DETERMINED 4.1. ALL TREES TO BE PRESERVED AS INDICATED ON THE TREE DISPOSITION PLAN SHALL BE PROTECTED BY A TREE PROTECTION BARRICADE, UNLESS OTHERWISE NOTED ON PLAN. BY THE NATIONAL HURRICANE CENTER, WILL BE RE-SET AND BRACED BY THE CONTRACTOR AT NO THE BOTTOM 2/3RDS SHALL BE CUT BEFORE THE TREES ARE INSTALLED. ADDITIONAL COST TO THE OWNER. 6.16. NO PLUNGING OF ANY TREE OR PALM WILL BE ACCEPTED.

- ALL APPLICABLE LOCAL, STATE AND FEDERAL CODES, ORDINANCES AND REGULATIONS.

- 3.5. REMOVE DEMOLISHED MATERIALS FROM SITE AND DISPOSE OF AS REQUIRED BY LOCAL, STATE OR
- 3.7. ALL IRRIGATION IN DEMOLITION AREA TO BE CAPPED AND ADJUSTED AS NECESSARY TO ENSURE

- 4.2. TREE PROTECTION BARRICADES SHALL BE PROVIDED BY LANDSCAPE CONTRACTOR AROUND THE 6.17. NO PLANT MATERIAL WILL BE ACCEPTED SHOWING EVIDENCE OF CABLE, CHAIN MARKS, EQUIPMENT DRIP LINE OF EXISTING TREES TO BE PRESERVED IN PLACE, AS SHOWN ON PLAN. PRESERVATION SCARS. OR OTHERWISE DAMAGED. BARRICADES SHALL BE LEFT IN PLACE THROUGHOUT DURING ALL PHASES OF CONSTRUCTION. 6.18. PLANT MATERIAL WILL NOT BE ACCEPTED WHEN THE BALL OF EARTH SURROUNDING ITS ROOTS HAS
- 4.3. PRIOR TO ANY CONSTRUCTION A TREE PROTECTION BARRICADE INSPECTION SHALL BE CONDUCTED BEEN CRACKED, BROKEN OR OTHERWISE DAMAGED. BY THE LANDSCAPE ARCHITECT, OWNER OR GOVERNING MUNICIPALITY. REFER TO PLANS FOR TREE 6.19. ALL TREES SPECIFIED AS FIELD GROWN OR B&B TREES SHALL BE ROOT-PRUNED AT THE NURSERY A PRESERVATION BARRICADE FENCING DETAIL. MINIMUM OF (8) WEEKS PRIOR TO PLANTING.
- IF EXCAVATION IN THE VICINITY OF A PROTECTED TREE IS REQUIRED, CONTRACTOR SHALL ROOT 6.20. ALL PLANT MATERIAL PLANTED WITHIN THE SIGHT DISTANCE TRIANGLE AREAS SHALL BE MAINTAINED 44 PRUNE TREES. UNDER THE SUPERVISION OF A CERTIFIED ARBORIST IN ACCORDANCE TO THE TO PROVIDE UNOBSTRUCTED CROSS-VISIBILITY AT A HORIZONTAL LEVEL BETWEEN 30 INCHES AND 8 FOLLOWING CONDITIONS: FEET ABOVE ADJACENT STREET GRADE.
- ROOT PRUNE TREES A MINIMUM OF EIGHT (8) WEEKS PRIOR TO CONSTRUCTION. PRIOR TO ROOT 4.4.1. 6.21. NO CANOPY TREES SHALL BE PLANTED WITHIN 12 FEET OF A LIGHT POLE. NO PALM SPECIES SHALL BE PRUNING, THOROUGHLY WATER THE ROOT ZONE WITH AT LEAST 2 TO 3 INCHES OF WATER FOR 2 PLANTED WITHIN 6 FEET OF A LIGHT POLE. TO 3 DAYS PRIOR TO ROOT PRUNING. SEE BELOW FOR RELOCATION TIMELINE.
  - 1. PROVIDE TEMPORARY IRRIGATION FOR EACH TREE THROUGHOUT THE DURATION OF CONSTRUCTION.
  - 2. ROOT PRUNE TREES, SHOWN ON PLAN IN AREAS WHERE ROOTS WILL CONFLICT WITH CONSTRUCTION ACTIVITY. PRUNING OF ROOTS SHOULD BE DONE IN A MANNER TO PRESERVE THE GREATEST AMOUNT OF THE ROOT BASE AS POSSIBLE
  - 3. BACKFILL TRENCH WITH PLANTING SOIL.
  - 4. FERTILIZE WITHIN THE ROOT ZONE (SEE BELOW).
- ROOT PRUNING SHALL BE ACCOMPLISHED BY DIGGING A TRENCH AROUND THE TREE IN AREAS 4.4.2.WHERE PROPOSED SITE WORK WILL BE PERFORMED. TRENCHING SHALL BE AT A MINIMUM OF 24" DEEP. ROOT PRUNE ONLY WITH A MECHANICAL ROOT-PRUNING SAW OR A TRENCHER WITH A MAXIMUM TRENCH WIDTH OF 8".
- 4.4.3. ALL EXPOSED ROOTS SHALL BE CUT OFF SMOOTHLY, WITH SHARP INSTRUMENTS. BACKFILL 7. TURF GRASSES TRENCHES WITH SOIL CONSISTING OF 30% SILICA SAND AND 70% MUCK. WATER THOROUGHLY AFTER ROOT PRUNING, AND ONCE WEEKLY DURING THE ROOT REGENERATION PERIOD, WITH A SOLUBLE FERTILIZER THAT HAS A 20.20.20 ANALYSIS AT MANUFACTURER'S RECOMMENDED RATE.
- THE CONTRACTOR SHALL FIELD STAKE THE LIMIT OF ROOT PRUNING. LIMITS OF ROOT PRUNING SHALL BE APPROVED BY THE LANDSCAPE ARCHITECT PRIOR TO ANY EXCAVATION. DO NOT ROOT PRUNE 8. 8.1.
- PLANTING SOIL
- 5.1. ALL TREES SHALL BE PLANTED WITH A MINIMUM OF 12" TOPSOIL AROUND AND BENEATH THE

- ARCHITECT OF RECORD COMPLETE SETS OF "AS-BUILT" CONSTRUCTION DRAWINGS. THESE TO A DEPTH OF TWENTY-FOUR INCHES fre(11 AND BACK FILLED WITH SOIL MIX AS SPECIFIED IN DRAWINGS SHALL BE MARKED TO SHOW "AS-BUILT" CONSTRUCTION CHANGES AND DIMENSIONED SECTION 5.00. PLANTING BED SHALL BE FREE FROM ROCK, CONSTRUCTION DEBRIS OR OTHER LOCATIONS AND ELEVATIONS OF ALL IMPROVEMENTS INCLUDING PRODUCT/EQUIPMENT AS EXTRANEOUS MATERIAL. SPECIFIED OR REVISED DURING THE SHOP DRAWING SUBMITAL PROCESS. AS-BUILT DRAWINGS 6.13. ALL PLANTING BEDS IN MEDIANS, HARDSCAPE AREAS OR AREAS ENCOMPASSED BY IMPERVIOUS SHALL BE SIGNED AND SEALED BY A FLORIDA REGISTERED LAND SURVEYOR. MATERIAL SHALL BE EXCAVATED TO A DEPTH OF THIRTY-SIX INCHES FI \* I'L OR UNTIL NATIVE SOILS
- ENCOUNTERED TO ENSURE DRAINAGE. BACK FILL WITH SOIL MIX AS SPECIFIED IN SECTION 5.00. 11. GUARANTEE PLANTING BED SHALL BE FREE FROM ROCK, CONSTRUCTION DEBRIS OR OTHER EXTRANEOUS MATERIAL
- 6.14. EXCAVATE PLANTING PITS TO A DEPTH SO THAT THE TRUNK FLARE AND FIRST ORDER LATERAL ROOT(S) WILL BE PLANTED AT FINISH GRADE OR SLIGHTLY HIGHER. ADVENTITIOUS ROOTS ARE NOT CONSIDERED FIRST ORDER ROOTS.

- STANDARD NURSERY PRACTICES. ALL PLANT MATERIAL SHALL BE WATERED IN AT TIME OF PLANTING IN ACCORDANCE WITH 9.2. STANDARD NURSERY PRACTICES. IN ADDITION. CONTRACTOR WILL CONTINUE THE WATERING OF PLANT MATERIAL UNTIL SUBSTANTIAL COMPLETION AND THE LANDSCAPE IS TURNED OVER TO THE OWNER.
- 10.1. DURING CONSTRUCTION, THE PROJECT SITE AND ALL ADJACENT AREAS SHALL BE MAINTAINED IN A NEAT AND CLEAN MANNER. UPON FINAL CLEAN UP, THE PROJECT SITE SHALL BE LEFT CLEAR OF ALL SURPLUS MATERIAL OR TRASH. THE PAVED AREAS SHALL BE SWEPT BROOM CLEAN.
- 10.2. THE CONTRACTOR SHALL RESTORE, REPLACE OR AS DIRECTED BY THE LANDSCAPE ARCHITECT, ANY PUBLIC OR PRIVATE PROPERTY DAMAGED BY THE WORK OF THE CONTRACTOR, HIS EQUIPMENT, EMPLOYEES OR THOSE OF HIS SUB-CONTRACTORS. THIS WORK SHALL BE RESTORED TO A CONDITION EQUAL TO OR BETTER THAN THAT OF THE EXISTING ADJACENT AREAS. THE RESTORATION WORK SHALL BE AT THE CONTRACTOR'S EXPENSE. SUITABLE MATERIALS AND METHODS SHALL BE USED FOR SUCH **RESTORATION.**

11.2. FOR ALL REPLACEMENT PLANT MATERIAL, THE WARRANTY PERIOD SHALL BE EXTENDED AN ADDITIONAL 90 DAYS BEYOND THE ORIGINAL WARRANTY PERIOD. REPLACEMENT MATERIAL SHALL

## City Council EHXIBIT "B"

- 6.22. GROUND COVER PLANTINGS SHALL PROVIDE NOT LESS THAN 50 PERCENT COVERAGE IMMEDIATELY UPON PLANTING AND 100 PERCENT COVERAGE WITHIN 6 MONTHS AFTER PLANTING.
- 6.23. TREES AND PALMS SHALL BE MAINTAINED TO ALLOW FOR CLEAR PASSAGE 8' IN ALL PEDESTRIAN AREAS.
- ALL LANDSCAPE MATERIAL SHALL BE SETBACK A MINIMUM OF 10' FROM ANY FIRE HYDRANT. 6.24.
- 6.25. CONTRACTOR SHALL REMOVE ALL NURSERY STAKES, CONDUIT, FLAGGING AND NURSERY TAPE PRIOR TO STAKING.
- 6.26. CONTRACTOR SHALL STAKE & GUY ALL TREES AND PALMS AT TIME OF PLANTING AS PER THE APPROPRIATE DETAIL. CONTRACTOR IS RESPONSIBLE FOR THE MAINTENANCE AND/OR REPAIR OF ALL STAKING AND GUYING DURING WARRANTY PERIOD AND REMOVAL & DISPOSAL OF STAKING AFTER ESTABLISHMENT/WARRANTY PERIOD.
- 6.27. TREES THAT CANNOT STAND WITHOUT THE SUPPORT OF STAKES AND/OR GUYS SHALL BE REJECTED.
- 7.1. ALL AREAS NOT USED FOR BUILDINGS, VEHICULAR USE AREAS, WALKS OR PLANTING BEDS SHALL BE GRASSED. GRASSING SHALL EXTEND TO ANY ABUTTING STREET PAVEMENT EDGE AND TO THE MEAN WATERLINE OF ANY ABUTTING CANAL, LAKE OR WATERWAY. REFER TO PLANTING SCHEDULE FOR ESTIMATED QUANTITY AND SPECIES.

## MULCH & FERTILIZER

- ALL PLANTING BEDS AND WATER BASINS FOR TREES SHALL BE COVERED WITH A 3" MINIMUM DEPTH OF SHREDDED FLORI-MULCH, MELALEUCA OR EUCALYPTUS MULCH GRADE 'B' OR BETTER, UNLESS OTHERWISE SPECIFIED.
- 8.2. INDIVIDUAL TREES PLANTED IN LAWN AREAS SHALL BE MULCHED WITH A MINIMUM 3' DIAMETER MULCH RING.
- 8.3. A I @7 < C< 5@@BC H69-**BCH5**@@98 K **+k** -**B** ' Ï C : HF99 H B?C'
- 8.4. FERTILIZER MIX AS FOLLOWS:
- 8.4.1. DICOT TREES & SHRUBS: NPK 18-4-2, SLOW RELEASE W/ MICRONUTRIENTS
- 8.4.2. MONOCOT PALMS: NPK 8-2-12, SLOW RELEASE W/ MICRONUTRIENTS
- TURF: NPK 16-4-8, SLOW RELEASE W/ MICRONUTRIENTS 8.4.3.

## 9. WATERING

9.1. ALL LANDSCAPED AREAS WITHIN THE COMMUNITY CENTER SITE WILL BE IRRIGATED BY AN UNDERGROUND, AUTOMATIC, RUST-FREE IRRIGATION SYSTEM PROVIDING 100% COVERAGE AND 50% SPRAY OVERLAP. THE SYSTEM SHALL BE MAINTAINED IN GOOD WORKING ORDER AND DESIGNED TO MINIMIZE WATER ON IMPERVIOUS SERVICES AND NOT OVERSPRAY WALKWAYS. A RAIN SENSOR DEVICE SHALL BE INSTALLED TO OVERRIDE THE IRRIGATION CYCLE OF THE SYSTEM WHEN ADEQUATE RAINFALL HAS OCCURRED. ALL LANDSCAPE AREAS WITHIN THE OVERFLOW PARKING SITE SHALL BE HAND WATERED FOR DURATION OF ESTABLISHMENT PERIOD IN ACCORDANCE WITH

11.1. ALL NEW PLANT MATERIAL SHALL BE GUARANTEED FOR 1 YEAR FROM TIME OF FINAL ACCEPTANCE OF PROJECT. ANY PLANT MATERIAL NOT IN A HEALTHY GROWING CONDITION WILL BE REPLACED IN KIND BY THE CONTRACTOR AT NO ADDITIONAL COST TO THE OWNER WITHIN 10 DAYS OF NOTIFICATION.



## &ASSOCIATES

500 Australian Avenue South Suite 530 West Palm Beach, FL 33401 561.746.6900 www.chenmoore.com **CERTIFICATES OF AUTHORIZATION** EB4593 LC26000425

REGISTRATION CRISTOBAL BETANCOURT **REGISTRATION NO. LA6666941** DATE: 10/08/15

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**PROJECT INFORMATION** 

## SOUTH SIDE COMMUNITY CENTER

## **RIVIERA BEACH, FL** PROJECT NUMBER 15-221.002

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DESIGNED BY

JS

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DRAWING TITLE


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LANDSCAPE

SPECIFICATIONS

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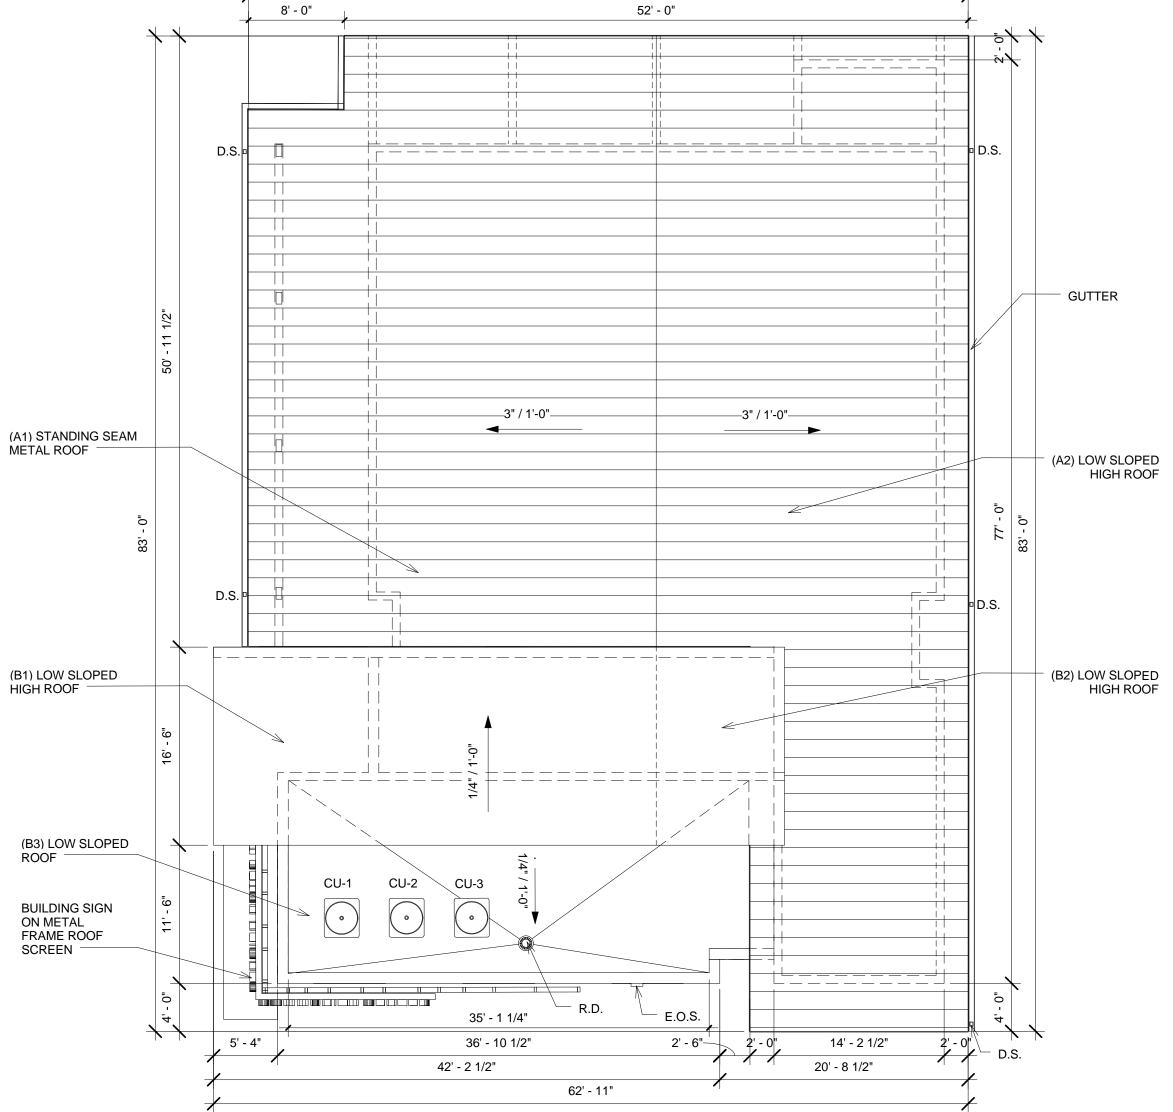


PEF						DDE, 20 Equired			•		03.1.	)														
OCCUPANCY	OCC LOAD	WATER CLOSETS				LAVAT	DRINKING FOUNTAIN		SER\ SIN		SHO	WEF														
EVENT		ма	MALE FEMALE		MALE	FEMALE					1 PER 500										1		4.0550			
SPACE (A-3)		1 PEF	R 125	1 PE	R 65	1 PE	R 200	1 SER SIN		NOT REQUIRED																
		REQ.	PROD.	REQ.	PROD.	REQUIRED	PROVIDED	REQ.	PRVD.	REQ.	PRVD.	REQ.	PRVD													
	120	.96		1.84		.6		.24		1		0														
OFFICES		MALE FEMALE			MALE	FEMALE																				
(B)		1 PER 25 FOR THE FIRST 50 AND 1 PER 50 FOR THE REMAINDER EXCEEEDING 50		50 AND 1 PER 50 FOR THE REMAINDER EXCEEEDING 80 FOR THE		ND 1 PER R THE INDER	1 PER 100		NOT REQUIRED		not Requirei															
		REQ.	PROD.	REQ.	PROD.	REQUIRED	PROVIDED	REQ.	PRVD.	REQ.	PRVD.	REQ.	PRVD													
	5	.10		1.2		.125		.05		0		0														
TOTAL		1.06	2	2.04	2	.725	3	.29	1	1		0	0													

 $\rightarrow$ 
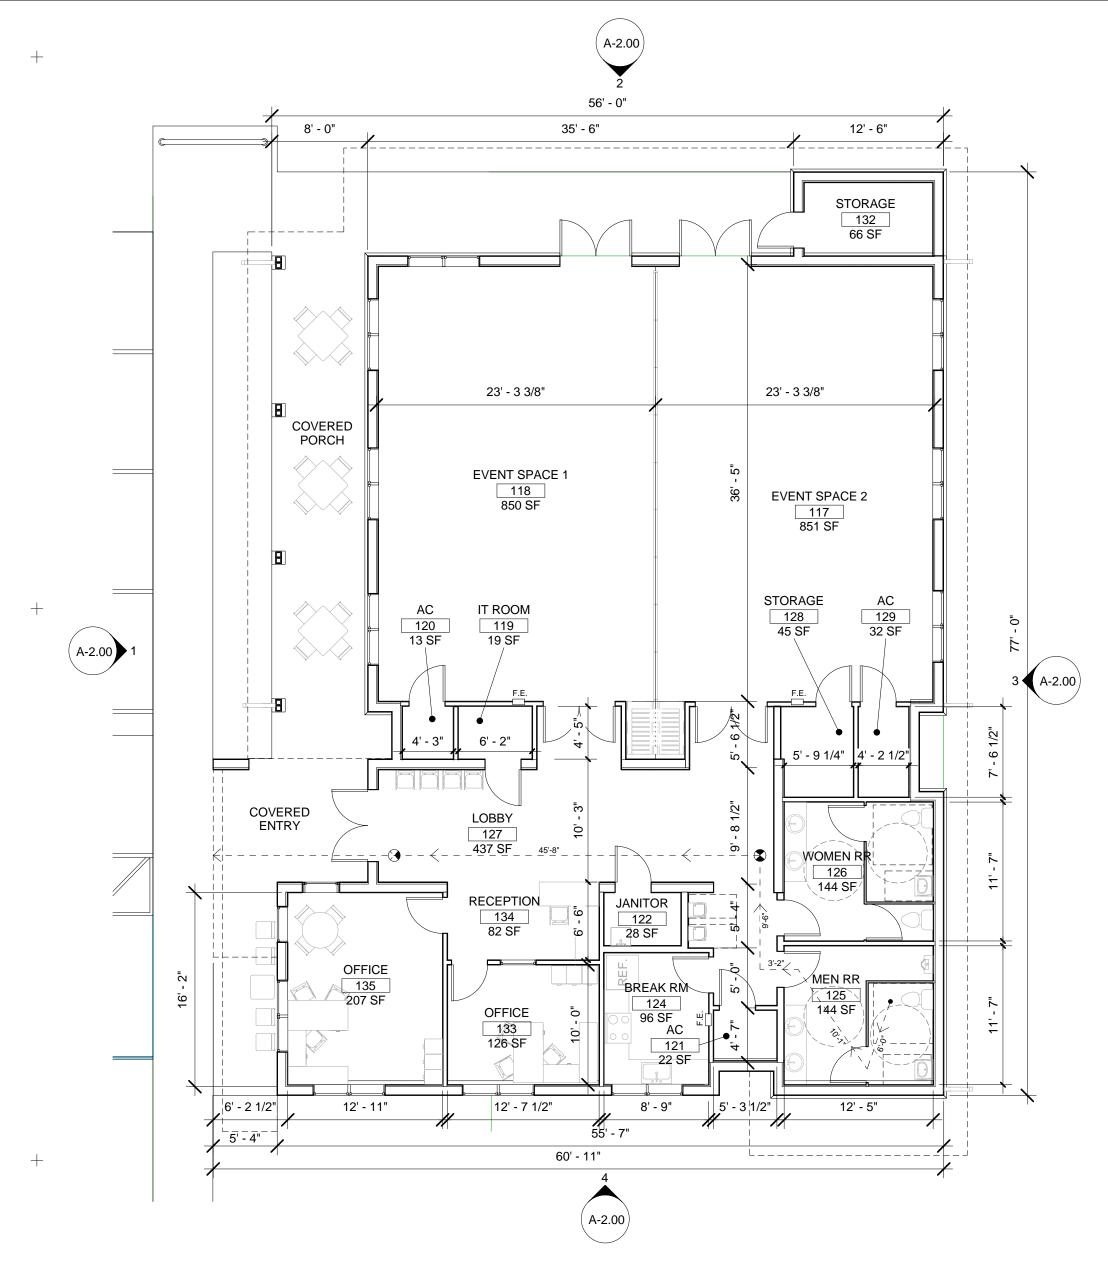
<ol> <li>RB Heights Community Center - SCHEME 2 .rvt</li> </ol>	
center\01-Preliminary\A15-011	
- RB Heights Community C	
D - Projects/15 PROJECTS/A15-011	
vrchitecture+Design/A+	

+



60' - 0"

## ROOF PLAN 1/8" = 1'-0"

## LIFE SAFETY CODE

LIFE SAFETY CODE:		
FLORIDA FIRE PREVENTION CODE FIFTI NFPA 101. LIFE SAFETY CODE, 2015 EDI		14)
OCCUPANCY CLASSIFICATION (CHAPTER 6)	A-3 ASSEMBLY	4,455 S.F.
MEANS OF EGRESS (CHAPTER 7)		
	ALLOWABLE	PROVIDED
OCCUPANT LOAD (TABLE 7.3.1.2)		
EVENT SPACE (LESS CONCENTRTATED USE, WITHOUT FIXED SEATING) - (1/15 SF - NET) 1,792 / 15 = 119.46	119.46	-
OFFICE (1 / 100 SF) 469 / 100 = 4.69	4.69	-
TOTAL OCCUPANT LOAD	124.15	125
REQUIRED MEANS OF EGRESS (CHAPTERS 12-42)		
MINIMUM STAIR WIDTH (TABLE 7.2.2.1)	44 IN	N/A
MINIMUM WIDTH PER OCCUPANT SERVED (SECTION 7.3.4)		
PER LEVEL 0.2 X _125_(2ND FL)_ = 25 IN.	25 IN.	60 IN. (MIN)
PER STAIRS 0.3 X	N/A	N/A
NUMBER OF MEANS OF EGRESS (SECTION 7.4)	2	3
ARRANGEMENT OF MEANS OF EGRESS (SECTION 7.5)	-	* SEE PLAN
1. FIGURE A.7.5.1.3.2 (a) thru FIGURE A.7.5.1.3.2 (e)		
DEAD END (TABLE A.7.6)	20 FT.	10' - 4"
COMMON PATH (TABLE A.7.6)	20 / 75 FT.	74' - 6"
TRAVEL DISTANCE (TABLE A.7.6)	200 FT.	74' - 6"
MININUM NUMBER OF EXITS (TABLE 1018.1)	2	3

## ROOF AREA CALCULATIONS

MAX ROOF DRAINAGE PROJECTED AREA			
ROOF	ROOF SIZE	VERTICAL WALL (1/2) AREA	
ROOF 'A1'	1,682 SF	98 SF	
ROOF 'A2'	1,834 SF	82 SF	
ROOF 'B1'	610 SF	0 SF	
ROOF 'B2'	177 SF	0 SF	
ROOF 'B3'	637 SF	134 SF	

## **ROOF DRAIN CALCULATIONS**

VERTICAL	CONDL	JCT	ORS	AN	D	L
AS PER FLORIDA PL	UMBING CODE	2014.	TABLE 11	06.2(2)	BAS	SEI

(ASTERTEORIDATEORIDATEORIDING CODE 2014, TABLE 1100.2(2) DA			,
ROOF	TOTAL ROOF AREA	REQUIRED SIZE OF VERTICAL LEADERS	
ROOF 'A1 + B1'	2,390 SF	2-3/4" X 4-1/4" (4" DIA.)	
ROOF 'A2 + B2'	2,093 SF	2-3/4" X 4-1/4" (4" DIA.)	
ROOF 'B3'	771 SF	3" DIA.	

NOTE 1 : GUTTERS & LEADERS TO BE PER MANUFACTURERS RECOMENDATION

## EMERGENCY OVERFLOW SCUPPERS

2 SF	N/A	
	11/1	
1 SF	N/A	
1 SF	12" X 2"	

TYPICAL EMERGENCY OVERFLOW SCUPPER

12" ----- $\mathbf{X}$ -----

## GENERAL NOTES:

LIFE SAFETY LEGEND

\_\_\_\_\_

---- COMMON PATH

1. FIRE EXTINGUISHERS TO BE MULTI-PURPOSE ABC (DRY CHEM) INSTALL IN ACCORDANCE W/ NFPA 10.

- SEPARATION OF EXITS

MAXIMUM TRAVEL DISTANCE TO AN EXIT

2. REFER TO ELECTICAL DRAWINGS FOR EXIT LIGHT LOCATIONS AND EMERGENCY LIGHTING

FE FIRE EXTINGUISHER - MP5 (OR APPROVED EQUAL)

# City Council EHXIBIT "C"

MATTHEW F. WEST AR 93859

LORIDA BUILDING CODE FIFTH EE	· · /	
OCCUPANCY CLASSIFICATION (CHAPTER 3)	A-3 ASSEMBLY	
TYPE OF CONSTRUCTION (CHAPTER 6)	TYPE V (B) (NON-S	PRINKLERED)
	ALLOWED	PROVIDED
MAXIMUM HEIGHT IN FEET (TABLE 503, SECTION 504)	40 FT (60 FT) *	20'-6"
MAX. NO. STORIES	1	1
AREA: ONE STORY	6,000 SF	4,455 SF
IRE RESISTANCE RATINGS FOR BUILD	NG ELEMENTS	<ul> <li>(TABLE 601)</li> </ul>
	ALLOWED	PROVIDED
PRIMARY STRUCTURAL FRAME		
INCLUDING COLUMNS, GIRDERS, TRUSSES	0 HR	0 HR
BEARING WALLS		
EXTERIOR (TABLE 602)	0 HR	0 HR
INTERIOR	0 HR	0 HR
NONBEARING WALLS AND PARTITIONS		
FLOOR CONSTRUCTION		
INTERIOR	0 HR	0 HR
AND SECONDARY MEMBERS	0 HR	0 HR
ROOF CONSTRUCTION		
AND SECONDARY MEMBERS	0 HR	0 HR
FIRE RESISTANCE RATINGS FOR EXTER	RIOR WALLS-	TABLE 602)
IRE SEPARATION DISTANCE	ALLOWED	PROVIDED
0 FT TO 5 FT	N/A	N/A
OVER 5 FT TO 10 FT	N/A	1 HR
OVER 10 FT TO 20 FT	N/A	1 HR
OVER 20 FT TO 30 FT	N/A	0 HR
OVER 30 FT	0 HR	0 HR
MEANS OF EGRESS (CHAPTER 10)		
	ALLOWABLE	PROVIDED
OCCUPANT LOAD (SECTION 1004, TABLE 1004.1.1)		
ASSEMBLY (A-3) (UNCONCENTRATED TABLES AND CHAIRS) - 1/15 NET (1,792 / 15 = 119.46)	119.46	-
BUSINESS (B) - (1/100 GROSS, 469/100 = 4.69)	4.69	-
		-
		-
TOTAL OCCUPANT LOAD	124.15	125
EGRESS WIDTH PER OCCUPANT SERVED (SECTION 1005)		
STAIRS (0.3 X 125 (2ND FL) = 33.3)	N/A	N/A
LEVEL (0.2 X 125 (2ND FL) = 21.4)	25 IN	60 IN (MIN.)
MINIMUM CLEAR OPENING OF EXIT DOORS (SECTION 1008.1.1)	32 IN.	34 IN
MINIMUM STAIR WIDTH (SECTION 1009.1)	44 IN.	N/A
COMMON PATH OF EGRESS (SECTION 1014.3)	75 FT.	74' - 6"
EXIT ACCESS TRAVEL DISTANCE (TABLE 1016.2)	200 FT.	74' - 6"
	20 FT.	10' - 4"
DEAD ENDS (SECTION 1018.4)	2011.	



WEST ARCHITECTURE + DESIGN, LLC AA26001503

318 SOUTH DIXIE HIGHWAY SUITE 4-5 LAKE WORTH FL 33460 561-588-2027 T 561-582-9419 F

www.west-arch.com

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CONSULTANT

NEW DEVELOPMENT FOR:

## **RIVIERA** BEACH HEIGHTS COMMUNITY CENTER

## 594 W 4TH ST. RIVIERA BEACH, FL 33404

DATE:	10-06-15
NUMBER:	A15-011
REVIEWED:	MW
MANAGED:	PG
DRAWN:	BG
REVISION:	

TOTAL AREA 1,780 SF 1,916 SF 610 SF 177 SF 771 SF

LEADERS


ED ON 5 IN ANNUAL RAINFALL MINIMUM PROVIDED SIZE OF RECTANGULAR VERTICAL LEADERS 3" X 4" 3" X 4" 4" DIA.

 $\square$ 


ON 5 IN ANNUAL RAINFALL) PROVIDED OVERFLOW SCUPPER SIZE

> N/A N/A 12" X 8"

<u>NOTE:</u> SCUPPERS TO BE PLACED TO ALLOW NO MORE THAN 2" OF WATER TO ACCUMULATE ON THE ROOF

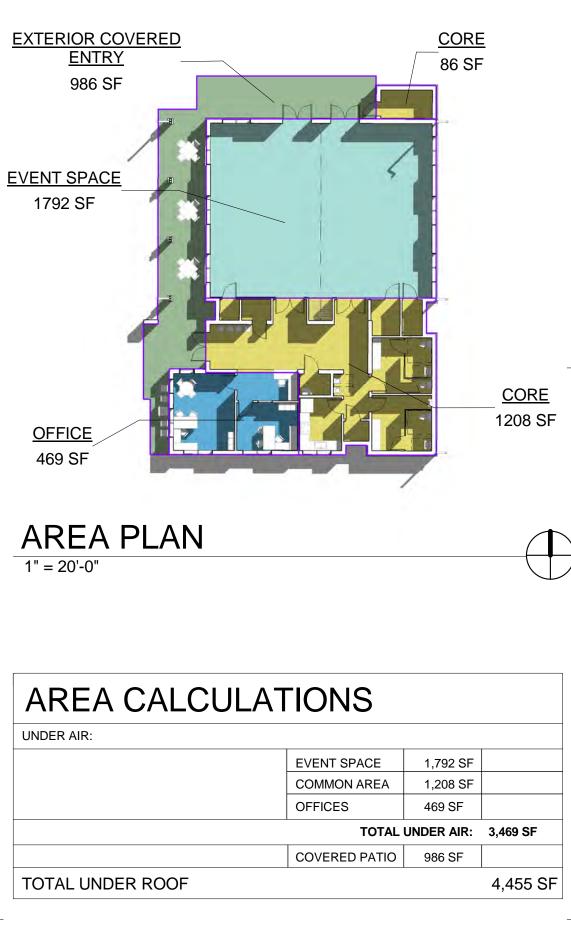

## FLOOR PLAN

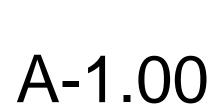

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A-2.00 1/8" = 1'-0"

**3 EAST ELEVATION** A-2.00 1/8" = 1'-0"

> 14 15

13 -

19

7 -

\_\_\_\_

5 -

3

\_\_\_\_\_




# A-2.00 1/8" = 1'-0"

2 NORTH ELEVATION

 $\left( 1 \right)$ 

A-2.00 1/8" = 1'-0"

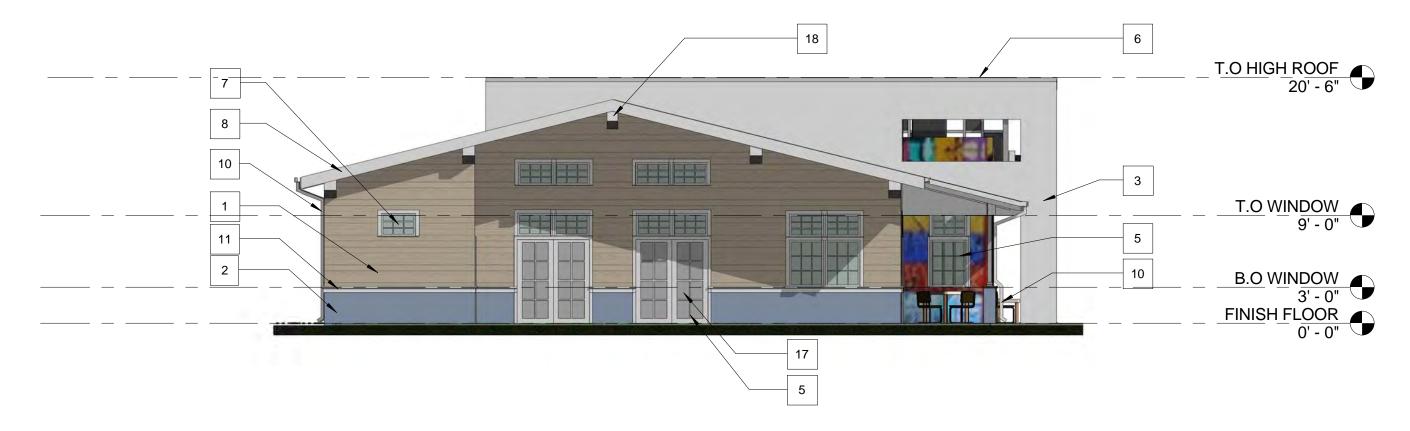



## WEST ELEVATION

+



# City Council EHXIBIT "C"



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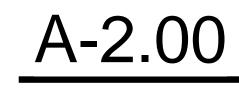
DA	TE:	10-06-15
NU	MBER:	A15-011
RE	VIEWED:	MW
MA	NAGED:	PG
DR	AWN:	BG
RE	VISION:	

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## FINISH MATERIAL LEGEND NAME / MANUF. / FINISH SYMBOL DESCRIPTION PAINTED STUCCO BEIGE - FINE TEXTURE 1 SIDING PAINTED STUCCO **BLUE - FINE TEXTURE** 2 3 PAINTED STUCCO WHITE - FINE TEXTURE METAL DOOR PAINTED WHITE 4 STOREFRONT 5 MANUFACTURER STND. - WHITE MULLION 6 BUILT-UP ROOF WHITE STOREFRONT - WINDOW GRAY TINTED 7

8	FASCIA	PAINTED WHITE
9	GUTTER	MANUFACTURER STND WHITE
10	DOWNSPOUT	MANUFACTURER STND WHITE
11	SILL	PAINTED WHITE
12	STANDING SEAM METAL ROOF	SILVER METALLIC
13	SCREEN - MULLION	ANODIZED ALUMINUM
14	SCREEN - PANEL	VARIES (TO BE DETERMINED)
15	SIGNAGE	(TO BE DETERMINED)
16	PAINTED STUCCO ART WALL	(TO BE DETERMINED)
17	STOREFRONT DOOR	MANUFACTURER STND WHITE
18	OUTLOOKER	PAINTED WHITE
19	CONCRETE AWNING	PAINTED WHITE
20	ALUMINUM COLUMN	MANUFACTURER STND WHITE
21	COLUMN BASE	PAINTED STUCCO - BLUE
22	LOUVER	MANUFACTURER STND WHITE

## EXTERIOR ELEVATIONS





## VIEW FROM SOUTHEAST

+

+

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VIEW FROM NORTHEAST

+



## VIEW FROM SOUTHWEST



## VIEW FROM NORTHWEST

+

# City Council EHXIBIT "C"

CONSULTANT:

NEW DEVELOPMENT FOR:

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# 594 W 4TH ST. RIVIERA BEACH, FL 33404

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## RENDERINGS

